

# LAEP EARLY CHILDHOOD CENTER

DSA Application Number: 03-122151

IDENTIFICATION STAMP DIV. OF THE STATE ARCHITECT

APP: 03-122151 INC:

REVIEWED FOR

SS FLS ACS D

DATE: 11/02/2022

# abode communities architecture

PROJ

# LAEP EARLY CHILDHOOD CENTER

13928 KORNBLUM AVE. HAWTHORNE, CA 90250

CLIENT:

#### Los Angeles Education Partnership

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ARCHITECT:

CONSULTANTS:

Abode Communities 1149 S. Hill Street, Suite 700 Los Angeles, CA 90015 T: 213.629.2702

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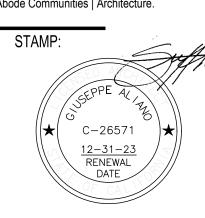
MECHANICAL/
ELECTRICAL/ PLUMBING
Breen Engineering
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Torrance, CA 90504
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STRUCTURAL

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#### DSA APPLICATION NUMBER: 03-122151

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PROGRESS SET 02.01.22

DSA PROGRESS SET 03.02.22

DSA APPLICATION SET 04.01.22

DSA BACK-CHECK SET 10.05.22

DSA BACK-CHECK SET 10.24.22

DSA BACK-CHECK SET 11.01.22

SHEET NAME:
COVER SHEET

SHEET NUMBER:

# LAEP EARLY CHILDHOOD CENTER

## TENANT IMPROVEMENT

DSA APPLICATION NUMBER: 03-122151

#### PROJECT DESCRIPTION

THE PROJECT CONSISTS OF A TENANT IMPROVEMENT TO 4 EXISTING 900 S.F. MODULAR CLASSROOM BUILDINGS AT PRAIRIE VISTA SOUTH MIDDLE SCHOOL.

THE PROJECT ENCOMPASSES 4 CLASSROOMS, NEW RESTROOMS. KITCHEN, LAUNDRY AND OFFICE SPACE IN A COMBINED AREA OF APPR0X. 3.628 S.F.

SCOPE INCLUDES DEMOLITION OF EXISTING WALL SURFACES, CEILINGS (WHERE NEEDED), AND FINISHES, RECONFIGURATION OF THE FLOOR PLAN, AND NEW DOORS, WINDOWS, PARTITIONS, AND FINISHES WITHIN THE EXISTING BUILDINGS. THERE WILL BE NO WORK TO MODIFY THE EXISTING STRUCTURE. PROVIDE NEW FIRE ALARM SYSTEM INSTALLATION FOR THE CHILDHOOD CENTER AND TIED TO THE EXISTING CAMPUS FIRE ALARM SYSTEM UNDER DSA A#03-101976.

#### PROJECT DIRECTORY

#### PROJECT APPLICANT

LOS ANGELES EDUCATION PARTNERSHIP 1541 WILSHIRE BOULEVARD SUITE 200 LOS ANGELES, CA 90017 213.622.5237

#### PROJECT ARCHITECT

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#### MECHANICAL/ ELECTRICAL/ PLUMBING


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#### **STRUCTURAL**

Breen Engineering 1983 W. 190th St., Suite 200 Torrance, CA 90504 T: 310.464.8404

#### **SURVEYOR**

Cal Vada Surveying, Inc. 411 Jenks Cir., Suite 205 Corona, CA 92878 T: 951.280.9960

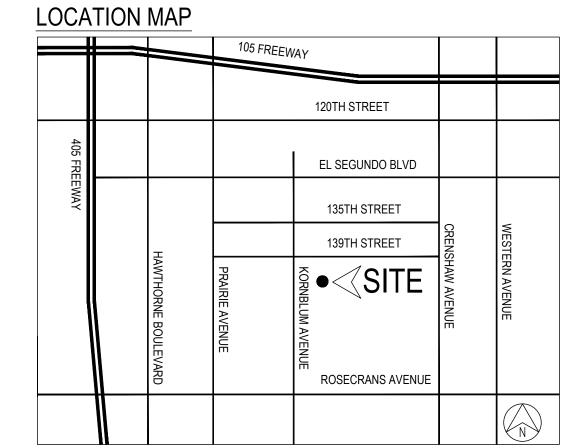

#### STATEMENT OF GENERAL CONFORMANCE

FOR ARCHITECTS/ENGINEERS WHO UTILIZE PLANS, INCLUDING BUT NOT LIMITED TO SHOP DRAWINGS, PREPARED BY OTHER LICENSED DESIGN PROFESSIONALS AND/OR CONSULTANTS (APPLICATION No. 03-122151 FILE No. \_\_\_\_\_ 19-44

THE DRAWINGS OR SHEETS LISTED ON THE COVER OR INDEX SHEET THIS DRAWING. PAGE OF SPECIFICATIONS / CALCULATIONS

HAVE BEEN PREPARED BY OTHER DESIGN PROFESSIONALS OR CONSULTANTS WHO ARE LICENSED AND/OR AUTHORIZED TO PREPARE SUCH DRAWINGS IN THIS STATE. IT HAS BEEN EXAMINED BY ME FOR:

- 1. DESIGN INTENT AND APPEARS TO MEET THE APPROPRIATE REQUIREMENTS OF TITLE 24, CALIFORNIA CODE OF REGULATIONS AND THE PROJECT SPECIFICATIONS PERPARED BT ME, AND
- COORDINATION WITH MY PLANS AND SPECIFICATIONS AND IS ACCEPTABLE FOR INCORPORATION INTO THE CONSTRUCTION OF THIS PROJECT.

THE STATEMENT OF GENERAL CONFORMANCE "SHALL NOT BE CONSTRUED AS RELIEVING ME OF MY RIGHTS, DUTIES, AND RESPONSIBILITIES UNDER SECTIONS 17302 AND 81138 OF THE EDUCATION CODE AND SECTIONS 4-336, 4-341 AND 4-344" OF TITLE 24, PART 1. (TITLE 24, PART 1, SECTION 4-317 [B])

I FIND THAT:		RAWINGS OR SHEETS LISTED ON THE R OR INDEX SHEET
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INTEN X HAS/I	NT, AND	FORMANCE WITH THE PROJECT DESIGN INATED WITH THE PROJECT PLANS AND
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ARCHITECT RESPONSIBI	-	GNATED TO BE IN GENERAL
GIUSEPPE A	LIANO	
PRINT NAME	:	
C-26571		12-31-23
LICENSE NU	MBER	EXPIRATION DATE

#### SITE INFORMATION

SITE ADDRESS:

13928 KORNBLUM AVENUE HAWTHORNE. CA 90250

#### **BUILDING DATA**

AS PER PREVIOUS SUBMITTAL DSA A#03-101976

STRUCTURAL DESIGN: RIGID FRAME TYPE OF CONSTRUCTION: TYPE V-N (ICC: TYPE V-B) WIND LOAD (EXP C): 70 MPH FLOOR LIVE LOAD: 50 PSF ROOF LIVE LOAD: 20 PSF

OCCUPANCY: 24' X 40' CLASSROOM: E

(4) 24' X 40' BUILDING = (4) X 960 SF = 3840 SF TOTAL AREA

#### APPLICABLE CODES AS OF JANUARY 1, 2020

- 2019 CALIFORNIA ADMINISTRATIVE CODE (CAC), PART 1, TILTE 24 CCR\*
- 2019 CALIFORNIA BUILDING CODE (CBC), PART 2, TITLE 24 CCR (2018 INTERNATIONAL BUILDING CODE, VOL 1&2, AND 2019 CALIFORNIA AMENDMENTS)
- 2019 CALIFORNIA ELECTRICAL CODE (CBC), PART 3, TITLE 24 CCR
- (2017 NATIONAL ELECTRICAL CODE, AND 2019 CALIFORNIA AMENDMENTS)
- 2019 CALIFORNIA MECHANICAL CODE (CBC), PART 4, TITLE 24 CCR • (2018 IAPMO UNIFORM MECHANICAL CODE, AND 2019 CALIFORNIA AMENDMENTS)
- 2019 CALIFORNIA PLUMBING CODE (CBC), PART 5, TITLE 24 CCR
- (2018 IAPMO UNIFORM PLUMBING CODE, AND 2019 CALIFORNIA AMENDMENTS)
- 2019 CALIFORNIA ENERGY CODE (CEC), PART 6, TITLE 24 CCR • 2019 CALIFORNIA FIRE CODE (CFC), PART9, TITLE 24 CCR
- (2018 INTERNATIONAL FIRE CODE, AND 2019 CALIFORNIA AMENDMENTS)
- 2019 CALIFORNIA EXISTING BUILDING CODE (CEBC), PART 10, TITLE 24 CCR
- (2018 INTERNATIONAL EXISTING BUILDING CODE, AND 2019 CALIFORNIA AMENDMENTS)
- 2019 CALIFORNIA GREEN BUILDING STANDARDS CODE (CALGREEN), PART 11, TITLE 24 CCR
- 2019 CALIFORNIA REFERENCED STANDARDS CODE. PART 12. TITLE 24 CCR
- TITLE 19 CCR, PUBLIC SAFETY, STATE FIRE MARSHAL REGULATIONS

NOTE: CAL/OSHA ELEVATOR UNIT ENFORCES CCR TITLE 8 AND USES 2004 ASME A17.1 BY ADOPTION.

\* ALL PARTS OF THE 2019 CALIFORNIA BUILDING CODE BECOME EFFECTIVE JANUARY 1, 2020 EXCEPT THE EFFECTIVE DATE FOR THE USE OF THE 2019 BUILDING ENERGY EFFICIENCY STANDARDS (TITLE 24, PART 1, CHAPTER 10) IS JANUARY 8, 2019 AND THE EFFECTIVE DATE FOR THE USE OF THE CALIFORNIA ADMINISTRATIVE CODE (TITLE 24, PART 1, CHAPTER 4) IS JANUARY 8, 2019.

CURRENT AS OF OCTOBER 10, 2020 ERRATA (CBC VOLUMES 1 AND 2)

#### APPLICABLE STANDARDS

- NFPA 13 (2016) STANDARD FOR THE INSTALLATION OF SPRINKLER SYSTEMS
- NFPA 14 (2016) STANDARD FOR THE INSTALLATION OF STANDPIPE AND HOSE SYSTEMS (CA AMENDED)
- NFPA 72 (2016) NATIONAL FIRE ALARM AND SIGNALING CODE (CA AMENDED)
- NFPA 2001 (2015) STANDARD ON CLEAN AGENT FIRE EXTINGUISHING SYSTEMS
- UL 464 (2003) AUDIBLE SIGNALING DEVICES FOR FIRE ALARM AND SIGNALING SYSTEMS, INCLUDING ACCESSORIES • UL 521 (1999) - STANDARD FOR HEAT DETECTORS FOR FIRE PROTECTIVE
- UL 1971 (2002, R2010) STANDARD FOR SIGNALING DEVICES FOR THE HEARING
- AAMA TIR A8-16 STRUCTURAL PERFORMANCE OF COMPOSITE THERMAL BARRIER FRAMING SYSTEMS (CA AMENDED)
- ACI 355.2-07 QUALIFICATION OF POST-INSTALLED MECHANICAL ANCHORS IN CONCRETE AND COMMENTARY (CA AMENDED)
- ACI 355.4-11 QUALIFICATION OF POST-INSTALLED ADHESIVE ANCHORS IN CONCRETE AND COMMENTARY (CA AMENDED)
- ACI 506R-16 GUIDE TO SHOTCRETE (CA AMENDED)
- ACI 506.2-13 [DSA-SS, DSA-SS/CC] GUIDE TO SHOTCRETE (CA AMENDED)
- AISC 358-16 PREQUALIFIED CONNECTIONS FOR SPECIAL AND INTERMEDIATE STEEL MOMENT FRAMES FOR SEISMIC APPLICATIONS
- ASCE/SEI 7-16 MINIMUM DESIGN LOADS AND ASSOCIATED CRITERIA FOR
- BUILDINGS AND OTHER STRUCTURES WITH SUPPLEMENT NO. 1. (CA AMENDED) ASCE/SEI 41-13 - SEISMIC EVALUATION AND RETROFIT OF EXISTING BUILDINGS
- ASCE/SEI 41-17 [DSA-SS, DSA-SS/CC] SEISMIC EVALUATION AND RETROFIT OF EXISTING BUILDINGS (CA AMENDED)
- ASTM A153/A153M-16a SPECIFICATION FOR ZINC COATING (HOT-DIP) ON IRON
- AND STEEL HARDWARE ASTM A1064-17 - STANDARD SPECIFICATION FOR CARBON-STEEL WIRE AND
- WELDED WIRE REINFORCEMENT, PLAN AND DEFORMED, FOR CONCRETE
- ASTM C94/C94M-17 SPECIFICATION FOR READ-MIXED CONCRETE
- ASTM C150/C150M-15 SPECIFICATION FOR PORTLAND CEMENT
- ASTM C618-17 [DSA-SS, DSA SS/CC] STANDARD SPECIFICATION FOR COAL FLY ASH AND RAW OR CALCINED NATURAL POZZOLAN FOR USE IN CONCRETE
- ASTM C635/C635M-17 [DSA-SS, DSA SS/CC] SPECIFICATION FOR THE MANUFACTURE, PERFORMANCE AND TESTING OF METAL SUSPENSION SYSTEMS FOR ACOUSTICAL TILE AND LAY-IN PANEL CEILINGS
- ASTM C1157/C1157M-17 STANDARD PERFORMANCE SPECIFICATION FOR HYDRAULIC CEMENT
- ASTM E580/E580M-17 STANDARD PRACTICE FOR INSTALLING OF CEILING SUSPENSION SYSTEMS FOR ACOUSTICAL TILE AND LAY-IN PANELS IN AREAS SUBJECT TO EARTHQUAKE GROUND MOTIONS
- ASTM E662-17a STANDARD TEST METHOD FOR SPECIFIC OPTICAL DENSITY OF SMOKE GENERATED BY SOLID MATERIALS.
- AWS D1.1/D1.1M-15 STRUCTURAL WELDING CODE STEEL
- AWS D1.4/D1.4M-2011 STRUCTURAL WELDING CODE REINFORCING STEEL INCLUDING METAL INSERTS AND CONNECTIONS IN REINFORCED CONCRETE
- AWS D1.8/D1/8M-2016 STRUCTURAL WELDING CODE SEISMIC SUPPLEMENT. AWS QC1-2016 - SPECIFICATION FOR AWS CERTIFICATION OF WELDING
- FM 1950-2016 AMERICAN NATIONAL STANDARD FOR SEISMIC SWAY BRACES FOR PIPE. TUBING AND CONDUIT.
- ICC-ES AC 70-18 ACCEPTANCE CRITERIA FOR FASTENERS POWER-DRIVEN INTO CONCRETE, STEEL AND MASONRY ELEMENTS. ICC-ES AC 156-18 - ACCEPTANCE CRITERIA FOR SEISMIC CERTIFICATION BY
- SHAKE-TABLE TESTING OF NONSTRUCTURAL COMPONENTS. ICC-ES AC 232-18 - ACCEPTANCE CRITERIA FOR ANCHOR CHANNELS IN
- CONCRETE ELEMENTS. ICC-ES AC 308-18 - ACCEPTANCE CRITERIA FOR POST-INSTALLED ADHESIVE
- ANCHORS IN CONCRETE ELEMENTS. ICC-ES AC 446-18 - ACCEPTANCE CRITERIA FOR HEADED CAST-IN SPECIALTY
- NFPA 72-16 NATIONAL FIRE ALARM AND SIGNALING CODE (AMENDED).
- PCI MNL 120-17 PCI DESIGN HANDBOOK 8TH EDITION.

INSERTS IN CONCRETE

 PTI DC35.1-14 - RECOMMENDATIONS FOR PRESTRESSED ROCK AND SOIL ANCHORS.

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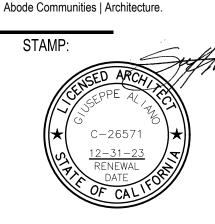
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DATE REV PROGRESS SET 02.01.22 DSA PROGRESS SET 03.02.22 DSA APPLICATION SET 04.01.22 DSA BACK-CHECK SET 10.05.22 DSA BACK-CHECK SET 10.24.22 DSA BACK-CHECK SET 11.01.22

> SHEET NAME: TITLE SHEET

SHEET NUMBER: G0.01

#### ARREVIATIONS

ABBREVIA1	<u> </u>				
A.B. A.C. ACCES. A.D. ADJ. A.F.F. A.P. APPROX. ARCH./ARCH'T	ANCHOR BOLT ASPHALTIC CONCRETE ACCESSORIES AREA DRAIN ADJACENT ABOVE FINISH FLOOR ACCESS PANEL APPROXIMATELY ARCHITECT	H.B. H.C. HDR. HDWR. HT. HORIZ. H.P. HTG. H.W.	HOSE BIB HANDICAP OR HOLLOW CORE HEADER HARDWARE HEIGHT HORIZONTAL HIGH POINT HEATING HOT WATER	S.L.D. S.M.D. S.P.D. SPEC. SQ. SRI S.S.D. S.S.D.	SEE LANDSCAPE DRAWINGS SEE MECHANICAL DRAWINGS SEE PLUMBING DRAWINGS SPECIFICATIONS SQUARE SOLAR REFLECTANCE INDEX SEE STRUCTURAL DRAWING SELECT STRUCTURAL OR STAINLESS STEEL
BBT BD. BLDG.	ALUMINUM  BIO BASED TILE  BOARD  BUILDING	I.B.C. I.D. INCL. I.E.	INTERNATIONAL BUILDING CODE INSIDE DIAMETER INCLUDED, INCLUDING INVERT ELEVATION INFORMATION	STD. ST'L STOR. STRUCT'L	STANDARD STEEL STORAGE STRUCTURAL TELEPHONE
BLK. BLKG. BLKT. BM. B.N. B.O. B.S. BRDG. BRKT.	BLOCK BLOCKING BLANKET BEAM BOUNDARY NAIL BOTTOM OF BOTH SIDES BRIDGING BRACKET	INFO. INSUL. INT. JST. JT. KM	INFORMATION INSULATION INTERIOR  JOIST JOINT  KILOMETER  LENGTH	TEMP. T&B T&G T.O.C. OR T.C. T.O.D. T.O.P. T.O.R. T.O.SL.	TEMPERED TOP & BOTTOM TONGUE & GROOVE TOP OF CURB OR TOP OF CONCRETE TOP OF DECK TOP OF PARAPET TOP OF ROOF TOP OF SLAB
B.T.U. B.U.R. CAB. CATV.	BRITISH THERMAL UNIT BUILT UP ROOF  CABINET CABLE TV	L.A.R.R. LAV. LBS. LG. L.H.	LOS ANGELES RESEARCH REPORT LAVATORY POUNDS LARGE LEFT HAND	T.O.ST. T.O.W. OR TW TS T.V. TYP.	TOP OF STEEL TOP OF WALL TUBULAR STEEL TELEVISION TYPICALWORK POINT
C.B. C.B.C. C.T. C.F.M. C.G.	CATCH BASIN CALIFORNIA BUILDING CODE CERAMIC TILE CUBIC FEET PER MINUTE CORNER GUARD CONSTRUCTION JOINT	L.L. L.P. LT. LT. WT. LOUV.	LIVE LOAD LOW POINT LIGHT LIGHTWEIGHT LOUVER	U.B.C. U.L. U.N.O. U.P.C.	UNIFORM BUILDING CODE OR APPLICABLE LOCAL BLDG. CODE UNDERWRITERS LABORATORY UNLESS NOTED OTHERWISE UNIFORM PLUMBING CODE
C.L. CLG. CLO. CLR. C.M.U. CM C.O. COEF. COL. CONC. CONN. CONST. CONT.	CENTER LINE CEILING CLOSET CLEAR CONCRETE MASONRY UNIT CENTIMETER CLEANOUT COEFFICIENT COLUMN CONCRETE CONNECT/CONNECTION CONSTRUCTION CONTINUOUS	MAT'L MAX. M.B. M.C. MECH. MEMB. MFG. M.H. MIN. MIR. MISC. MTL.	MATERIAL MAXIMUM MACHINE BOLT MEDICINE CABINET MECHANICAL MEMBRANE MANUFACTURER MANHOLE MINIMUM MIRRORED MISCELLANEOUS METAL	V. V.B. V.C.T. V.G.D.F. VENT. VERT. VI.F. V.T.R. VOL. W. W/ W/O	VOID VAPOR BARRIER VINYL COMPOSITION TILE VERTICAL GRAIN DOUGLAS FIR VENTILATION VERTICAL VERIFY IN FIELD VENT TO ROOF VOLUME WEST OR WIDE FLANGE WITH WITHOUT
CTR. C.W. CU. DBL. DEPT. D.F.	CENTER COLD WATER CUBIC  DOUBLE DEPARTMENT DOUGLAS FIR	N. (N) N.G. N.I.C. NO. N.T.S.	NORTH NEW NATURAL GRADE NOT IN CONTRACT NUMBER NOT TO SCALE	WD. W.F. W.GL. W.H. W.M. WP.M.	WOOD WALL FURNACE WIRE GLASS WATER HEATER OR WEEP HOLE WATER METER WATERPROOF MEMBRANE WEIGHT
DIM. DN. DR. D.S. DWG.	DIMENSION DOWN DOOR DOWNSPOUT DRAWING  EAST	OBS. O.C. O.D. OPNG. OPP. OT. O.T.B.	OBSCURE ON CENTER OUTSIDE DIAMETER OPENING OPPOSITE OUTLET OPEN TO BELOW	W.W.F. WK.PT.	WELDED WIRE FABRIC WORK POINT
EA. E.F. E.J. EL. ELAST. MEM. ELEC. ELECL. ELEV. EQ. EQUIP. EXIST'G OR (E) EXT.	EACH EACH FACE EXPANSION JOINT ELEVATION, VERTICAL ELASTOMERIC MEMBRANE ELECTRIC ELECTRICAL ELEVATOR EQUAL EQUIPMENT EXISTING EXTERIOR	P.A. P.L. P. LAM PLT. PLBG. PLYWD. P.O.C. P.S.F. PT. PTD. P.T.W. PVC	PLANT AREA PROPERTY LINE PLASTIC LAMINATE PLATE PLUMBING PLYWOOD POINT OF CONNECTION POUNDS PER SQUARE FOOT POINT/PRESSURE TREATED PAINTED PRESSURE TREATED WOOD POLYVINYL CHLORIDE		
F.C. F.D. F.E.	FINISH CEILING FLOOR DRAIN FIRE EXTINGUISHER	Q.T. R.A.	QUARRY TILE RETURN AIR		
F.F. F.G. F.H. FIN. FIX. F.J. F.L.	FINISH FLOOR FINISH GRADE FIRE HYDRANT FINISH FIXED FLOOR JOIST FLOW LINE	REFRIG. REG. REINF. REQ'D R.R. RTF	REFRIGERATOR/REFRIGERATION REGISTER, REGULATION OR REGULAR REINFORCING REQUIRED ROOF RAFTERS RIGID THERMAL FOIL		
FLR. F.O.F. F.O.M. F.S. F.O.S. FT. FTG.	FLOOR FACE OF FINISH FACE OF MASONRY FINISH SURFACE FACE OF STUD FOOT FOOTING	S. S.A. S.A.F.F. S.C. SCHED. SCUP.	SOUTH OR SINK SUPPLY AIR SELF-ADHERED FLEXIBLE FLASHING SOLID CORE SCHEDULE SCUPPER		
GALV. G.B. GEN. G.C. G.P.M. G.S. G.S.M. GWB GYP.	GALVANIZED GRAB BAR GENERAL GENERAL CONTRACTOR GALLONS PER MINUTE GRAVEL STOP GALVANIZED SHEET METAL GYPSUM WALL BOARD GYPSUM	S.F.  SGL. SHT. SHT'G SIM. SM. S.C.D. S.E.D.	SQUARE FOOT OR SUB FLOOR SINGLE SHEET SHEATHING SIMILAR (BUT NOT IDENTICAL) SMALL SEE CIVIL DRAWINGS SEE ELECTRICAL DRAWINGS		

SHEET INDEX TOTAL: 98 SHEETS

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G2.02 GENERAL NOTES

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G3.04 ACCESSIBILITY - PLUMBING ELEMENTS & FACILITIES G3.05 ACCESSIBILITY - COMMUNICATION ELEMENTS & FEATURES G3.06 ACCESSIBILITY - MOUNTING HEIGHTS & ACCESSORIES

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A7.04 BUNGALOW 4 FINISH PLAN

A8.01 BUNGALOW 1 POWER & COMMUNICATIONS PLAN A8.02 BUNGALOW 2 POWER & COMMUNICATIONS PLAN A8.03 BUNGALOW 3 POWER & COMMUNICATIONS PLAN

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FIRE ALARM

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FA1.00 FIRE ALARM FLOOR PLANS

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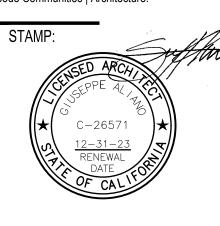
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PROGRESS SET	02.01.22	
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G0.02

#### [A]. GENERAL

- THIS PROJECT SHALL COMPLY TO THE CURRENT EDITION 2019 OF THE CALIFORNIA BUILDING CODE, CALIFORNIA RESIDENTIAL CODE, CALIFORNIA PLUMBING CODE, CALIFORNIA MECHANICAL CODE, CALIFORNIA ELECTRIC CODE, CALIFORNIA FIRE CODE, CALIFORNIA HEALTH AND SAFETY CODE AND CITY OF HAWTHORNE MUNICIPAL CODE AS WELL AS CALGREEN CODE, LEED, TITLE 24 ACCESSIBILITY AND ENERGY CODE REQUIREMENTS.
- 2. THESE DRAWINGS AND SPECIFICATIONS AND COPIES ARE LEGAL INSTRUMENTS OF SERVICE FOR USE BY THE OWNER AND AUTHORIZED REPRESENTATIVES ON THE DESIGNATED PROPERTY ONLY.
- 3. THE CONTRACTOR SHALL CAREFULLY INSTRUCT EACH OF THE SUBCONTRACTORS TO BECOME THOROUGHLY FAMILIAR WITH ALL OF THE DRAWINGS AND SPECIFICATIONS. WHEREVER EXISTING CONDITIONS MAY HAVE A BEARING ON THE EXPEDITIOUS PERFORMANCE OF THE WORK, THE SUBCONTRACTOR SHALL VISIT THE JOB SITE AND PERSONALLY INSPECT AND VERIFY THE SITE FOR COMPARISON WITH PERTINENT SECTIONS OF SPECIFICATIONS AND DRAWINGS. NO ALLOWANCE CAN BE SUBSEQUENTLY MADE ON BEHALF OF THE SUBCONTRACTOR FOR ERRORS DUE TO THE NEGLIGENCE OF FAILING TO BECOME ACQUAINTED WITH THE EXISTING SITE CONDITIONS.
- 4. VERIFY ALL EXISTING CONDITIONS AND DIMENSIONS BEFORE SUBMITTING BID OR PROCEEDING WITH THE WORK. ACTUAL FIELD CONDITIONS MAY VARY FROM THE PLANS. ANY DISCREPANCIES BETWEEN DRAWINGS AND FIELD CONDITIONS SHALL BE REPORTED IMMEDIATELY TO THE ARCHITECT. NO DEVIATION FROM CONTRACT DRAWINGS OR SPECIFICATIONS SHALL BE MADE WITHOUT WRITTEN APPROVAL FROM THE ARCHITECT.
- 5. VERIFY LOCATIONS OF ALL UTILITIES (GAS, WATER, SEWER CONNECTIONS AND ELECTRICAL METERS) PRIOR TO 1.
- 6. CONTRACTOR SHALL PROVIDE TEMPORARY TOILETS AND OTHER TEMPORARY FACILITIES AS REQUIRED.
- PROVIDE PEDESTRIAN AND PROPERTY PROTECTION BARRICADES AND/OR CANOPIES AS REQUIRED BY C.B.C. SECT. PROVIDE DETAILS AND SPECIFICATIONS FOR ALL SWINGING DOORS IN SECURITY OPENINGS IN ACCORDANCE WITH THE 3306, AND AS NECESSARY FOR PEDESTRIAN SAFETY. NO PERSON SHALL PERFORM ANY WORK ON ANY BUILDING OR FOLLOWING REQUIREMENTS: STRUCTURE ADJACENT TO A PUBLIC WAY IN GENERAL USE BY THE PUBLIC FOR PEDESTRIAN TRAVEL, UNLESS THE PEDESTRIANS SHALL BE PROTECTED BY FENCES, CANOPIES OR OTHER DEVICES.
- IMPROVEMENTS ON THE SITE, WORK AND PROCESS, STORED MATERIALS, AND PUBLIC AND PRIVATE IMPROVEMENTS ON PROPERTY ADJACENT TO THE SITE SHALL BE PROTECTED BY THE CONTRACTOR FROM DAMAGE ARISING FROM THE WORK. ALL DAMAGE SO OCCURRING SHALL BE REPAIRED OR REPLACED BY THE CONTRACTOR AT NO COST TO
- PRIOR TO PLACEMENT OF FILL, CLEAR SURFACE AREAS OF VEGETATION, ASPHALT, CONCRETE PAVEMENTS, SURFACE OBSTRUCTIONS AND OTHER DELETERIOUS MATERIALS. REMOVE ALL UTILITY LINE OBSTRUCTIONS EXTENDING BELOW FINISH GRADE AND FILL HOLES WITH COMPACTED SOIL. ALL MATERIALS GENERATED FROM CLEARING TO BE REMOVED AND DISPOSED OF AT A LEGAL DUMP SITE.
- 10. IMPROVEMENTS ON THE SITE, WORK AND PROCESS, STORED MATERIALS, AND PUBLIC AND PRIVATE IMPROVEMENTS ON PROPERTY ADJACENT TO THE SITE SHALL BE PROTECTED BY THE CONTRACTOR FROM DAMAGE ARISING FROM THE WORK. ALL DAMAGE SO OCCURRING SHALL BE REPAIRED OR REPLACED BY THE CONTRACTOR AT NO COST TO
- 11. OVERLOADING: DO NOT OVERLOAD ANY PART OF THE STRUCTURES BEYOND THE SAFE CARRYING CAPACITY BY PLACING OF MATERIALS, EQUIPMENT, TOOLS, MACHINERY, OR ANY OTHER ITEM THEREON.
- DIMENSIONS
- a. ALL DIMENSIONS ARE TO BE VERIFIED
- b. ALL DIMENSIONS ARE TO FACE OF STUD, UNLESS OTHERWISE NOTED.
- c. DIMENSIONS AND ELEVATIONS ARE TO TOP OF CONCRETE, BRICK OR OTHER HARD SURFACE MATERIAL, NOT TO TOP OF FLOOR COVERING OR ROOFING.
- d. DO NOT SCALE DRAWINGS; DIMENSIONS GOVERN. IF DIMENSIONS ARE NOT SHOWN ON DRAWINGS, CONTACT
- 13. REFERENCE TO ANY DETAIL OR DRAWINGS IS FOR CONVENIENCE ONLY AND DOES NOT LIMIT THE APPLICATION OF SUCH DRAWING OR DETAIL.
- 14. LARGER SCALE DETAIL DRAWINGS TAKE PRECEDENCE OVER SMALLER SCALE DETAIL DRAWINGS. DISCREPANCIES SHOULD BE NOTED TO THE ARCHITECT FOR CLARIFICATION.
- 15. CONTRACTOR SHALL COORDINATE WITH ALL EQUIPMENT MANUFACTURERS FOR EQUIPMENT ROUGH-IN
- REQUIREMENTS.
- 16. UNLESS OTHERWISE INDICATED, CLOSETS, VESTIBULES, COLUMNS, PARTITIONED OFF PORTIONS, PROJECTIONS OR RECESSES SHALL HAVE FINISHES AS SCHEDULED FOR RESPECTIVE SPACE IN WHICH THEY OCCUR.
- 17. THE STRUCTURAL, MECHANICAL AND ELECTRICAL DRAWINGS ARE SUPPLEMENTARY TO THE ARCHITECTURAL DRAWINGS. SHOULD THERE BE A DISCREPANCY BETWEEN THE ARCHITECTURAL DRAWINGS AND THE CONSULTING ENGINEERS DRAWINGS, THE DISCREPANCY IS TO BE BROUGHT TO THE ATTENTION OF THE ARCHITECT PRIOR TO INSTALLATION OF SAID WORK. ANY WORK INSTALLED IN CONFLICT WITH THE ARCHITECTURAL DRAWINGS SHALL BE CORRECTED BY THE CONTRACTOR AT HIS/HER OWN EXPENSE.
- 18. SPECIFICATIONS, BOUND SEPARATELY, ARE PART OF THESE DOCUMENTS. ALL ADDENDA, CHANGE ORDERS, BULLETINS AND NOTICES, IF ANY, ISSUED LATER, SHALL BE CONSIDERED AS PART OF THE WORK.
- 19. THE CONTRACTOR SHALL BE RESPONSIBLE FOR CONTINUOUS CLEAN-UP OF THE SITE AND OF ALL DEBRIS, WHETHER CREATED BY THE CONTRACTOR, OR BY THE FAILURE OF THE SUBCONTRACTORS TO CLEAN UP AFTER
- 20. THERE SHALL BE NO EXPOSED PIPE CONDUITS, DUCTS, VENTS, ETC., IN DESIGNATED FINISH SPACES, UNLESS NOTED AS EXPOSED CONSTRUCTION ON FINISH SCHEDULE.
- 21. WHERE FACTORY PRIMED ITEMS OCCUR, SUCH AS GRILLES, DIFFUSERS, METAL TRIM AND ACCESSORIES, ETC., PAINT TO MATCH THE ADJACENT SURFACE OR AS DIRECTED BY THE ARCHITECT. REFER TO SPECIFICATIONS FOR ALL OTHER ITEMS NOT INCLUDED ON FINISH SCHEDULE.
- 22. UNLESS OTHERWISE NOTED, ALL EXTERIOR AND INTERIOR EXPOSED METAL TRIM, TRELLIS, RAILINGS, MOLDINGS, FRAMES, CASTINGS, ETC. SHALL BE PAINTED. VERIFY WITH ARCHITECT.
- 23. IT SHALL BE THE RESPONSIBILITY OF THE CONTRACTOR TO OBTAIN APPROVAL BY THE LOCAL BUILDING INSPECTOR FOR ALL CONCEALED WORK BEFORE CLOSING UP.
- 24. ALL BATHROOM AND TOILET ROOMS SHALL BE VENTILATED TO PROVIDE FIVE AIR CHANGES PER HOUR, AND CONNECTED DIRECTLY TO THE OUTSIDE. FAN SHALL BE OPERATED FROM THE LIGHT SWITCH.
- 25. PROVIDE BACKING FOR ALL CABINETS, TOWEL BARS, GRAB BARS, ETC.
- 26. ALL LUMBER IN CONTACT WITH MASONRY OR CONCRETE LESS THAN 6" ABOVE THE GROUND SHALL BE PRESSURE-TREATED OR DURABLE WOOD.
- 27. FIRE BLOCK AT MID-HEIGHT OF WALLS OVER 8'-0" HIGH.
- 28. ALL EXTERIOR OPENINGS EXPOSED TO THE WEATHER SHALL BE FLASHED IN SUCH A MANNER AS TO MAKE THEM
- 29. ALL SHEET METAL WORK SHALL BE MINIMUM 24 GAUGE GALVANIZED STEEL UNLESS NOTED OTHERWISE
- 30. PROVIDE APPROVED STUCCO WEEP SCREEDS AT SILL PLATE OF ALL STUCCO WALLS. STUCCO FINISH SHALL NOT EXTEND BELOW FINISH GRADE. STUCCO WEEP SCREED TO BE AT LEAST 2" ABOVE PAVEMENT AND AT LEAST 4" ABOVE GRADE.
- 31. ALL GLAZING WITHIN 18" OF A FLOOR SHALL BE TEMPERED OR WIRED.
- 32. THERE ARE TO BE NO TRENCHES OR EXCAVATIONS 5'-0" OR MORE IN DEPTH INTO WHICH A PERSON IS REQUIRED TO DESCEND.
- 33. FIRE BLOCKING AND DRAFTSTOPPING SHALL BE INSTALLED PER C.B.C. SECTION 717.
- 34. PENETRATION IN ROOF FOR VENTS, PIPES, ETC. SHALL BE LOCATED 18"-24" FROM A ROOF DRAIN, PARAPET, CHANGE IN ROOF PLANE, OR OTHER VENTS OR PIPES.
- 35. PLUMBING PENETRATIONS OF AREA SEPARATION WALLS MUST BE CAST IRON OR WROUGHT IRON.
- 36. ACCESS PANELS SHALL BE PROVIDED WHERE REQUIRED BY CODES OR WHEREVER REQUIRED FOR PROPER OPERATION OF MECHANICAL OR ELECTRICAL EQUIPMENT. CONTRACTOR SHALL COORDINATE LOCATION, SIZE AND THE TYPE OF ACCESS PANEL WITH THE SUBCONTRACTOR'S WORK AND SHALL VERIFY LOCATIONS WITH ARCHITECT PRIOR TO CONSTRUCTION.
- 37. ALL WALLS HAVING PLUMBING ARE TO BE SIZED TO ACCOMMODATE THE PLUMBING. REFERENCE FLOOR PLANS FOR LOCATION

- 38. PROVIDE SOLID WALL BACKING FOR ALL WALL HUNG EQUIPMENT, FURNISHINGS AND CABINETS.
- 39. PROVIDE FURRED OUT SURFACES WHERE REQUIRED TO CONCEAL PIPING, DUCTS, ETC., IN FINISHED ROOMS SHOULD CONDITIONS NECESSITATE ALTERATIONS IN INDICATED CEILING HEIGHTS DUE TO STRUCTURAL OR MECHANICAL REQUIREMENTS, OBTAIN APPROVAL FROM THE ARCHITECT BEFORE INSTALLING FURRING.
- 40. PROVIDE PLYWOOD BACKING 8'-0" HIGH AT TELEPHONE EQUIPMENT LOCATIONS

ARE REQUIRED TO BE GALVANIZED OR CAST IRON PIPING.

- 41. ALL ELEVATORS IN THIS STRUCTURE MUST SATISFY THE PROVISIONS OF C.B.C. CHAPTER 30 AND TITLE 24. ELEVATORS SHALL REQUIRE APPROVAL & PERMIT PRIOR TO PERMIT ISSUANCE.
- 42. RECESSED CEILING LIGHT FIXTURES MUST BE BOXED AROUND WITH 5/8" TYPE 'X' DRYWALL TO MAINTAIN THE 1-HOUR CEILING ASSEMBLY.
- 43. ALL PLUMBING PENETRATION THROUGH WALLS WHICH REQUIRE PROTECTED OPENINGS (OCCUPANCY SEPARATION WALLS, AREA SEPARATION WALLS, CORRIDOR WALLS AND WALLS CLOSE TO A REAL OR IMAGINARY PROPERTY LINE)
- 44. PLUMBING PENETRATION THROUGH A HORIZONTAL OCCUPANCY SEPARATIONS SHALL BE BOXED OUT AND FILLED WITH APPROVED SAFING MATERIAL. INSULATION IS NOT APPROVED. (SECTION 709.6.3)

- ALL OPENINGS IN EXTERIOR WALLS OR ROOFS WHICH ARE LESS THAN 16'-0" ABOVE ADJACENT AREAS ACCESSIBLE TO THE PUBLIC SHALL BE CONSIDERED SECURITY OPENINGS AND SHALL COMPLY TO THE PROVISIONS OF THE C.B.C.
- 2. DOORS, SWINGING
- a. WOOD FLUSH-TYPE DOORS SHALL BE 1-3/8" THICK MINIMUM WITH SOLID CORE CONSTRUCTION, OR
- b. HOLLOW CORE DOORS OR DOORS LESS THAN 1-3/8" IN THICKNESS COVERED ON THE INSIDE FACE WITH 16 GAUGE SHEET METAL ATTACHED WITH SCREWS AT 6" ON CENTER AROUND THE PERIMETER OR EQUIVALENT, OR
- WOOD PANEL TYPE DOORS WITH PANELS FABRICATED OF LUMBER NOT LESS THAN 9/16" THICKNESS, PROVIDED SHAPED PORTIONS OF PANELS ARE NOT LESS 1/4" THICK. INDIVIDUAL PANELS SHALL NOT EXCEED 300 S. F. IN AREA. STILES AND RAILS SHALL BE OF SOLID LUMBER IN THICKNESS WITH OVERALL DIMENSIONS OF NOT LESS THAN 1-3/8" AND 3" IN WIDTH. MULLIONS SHALL BE CONSIDERED A PART OF ADJACENT PANELS UNLESS SIZED AS REQUIRED HEREIN FOR STILES AND RAILS EXCEPT MULLIONS NOT OVER 18" LONG MAY HAVE AN OVERALL WIDTH S OF NOT LESS THAN 2". CARVED AREAS SHALL HAVE A THICKNESS OF NOT LESS THAN 3/8".
- d. DOOR STOPS OF IN-SWINGING DOORS SHALL BE OF ONE-PIECE CONSTRUCTION WITH THE JAMB OR JOINED BY RABBET TO THE JAMB.
- e. ALL PIN-TYPE HINGES WHICH ARE ACCESSIBLE FROM OUTSIDE THE SECURED AREA WHEN THE DOOR IS CLOSED SHALL HAVE NON-REMOVABLE HINGE PINS. IN ADDITION, THEY SHALL HAVE MINIMUM 1/4" DIAMETER STEEL JAMB STUD WITH 1/4" MINIMUM PROTECTION UNLESS THE HINGES ARE SHAPED TO PREVENT REMOVAL OF THE DOOR IF THE HINGE PINS ARE REMOVED.
- f. THE STRIKE PLATE FOR LATCHES AND THE HOLDING DEVICE FOR PROJECTING DEADBOLTS IN WOOD CONSTRUCTION SHALL BE SECURED TO THE JAMB AND THE WALL FRAMING WITH SCREWS NOT LESS THAN 2-1/2"
- g. SPECIFY DEADBOLTS WITH HARDENED INSERTS; DEADLOCKING LATCH KEY-OPERATED LOCKS ON EXTERIOR; LOCKS OPERABLE WITHOUT KEY, SPECIAL KNOWLEDGE OR SPECIAL EFFORT ON INTERIOR; AND TYPE THROW, AND EMBEDMENT OF DEADBOLTS FOR SINGLE SWINGING DOOR, ACTIVE LEAF OF PAIRS OF DOORS, OR BOTTOM LEAF OF DUTCH DOOR.
- h. A HOOK-SHAPED OR AN EXPANDING-LUG DEADBOLT SHALL HAVE A MINIMUM THROW OF 3/4"
- i. CYLINDER GUARDS SHALL BE INSTALLED ON ALL CYLINDER LOCKS WHENEVER THE CYLINDER PROJECTS BEYOND THE FACE OF THE DOOR OR IS OTHERWISE ACCESSIBLE TO GRIPPING TOOLS.

- a. GLAZED OPENINGS WITHIN 40" OF THE DOOR LOCK WHEN THE DOOR IS IN THE CLOSED POSITION, SHALL BE FULLY TEMPERED GLASS OR APPROVED BURGLARY RESISTANT MATERIAL, OR SHALL BE PROTECTED BY METAL BARS, SCREENS OR GRILLS HAVING A MAXIMUM OPENING OF 2". THE PROVISIONS OF THIS SECTION SHALL NOT APPLY TO VIEW PORTS OR WINDOWS WHICH DO NOT EXCEED 2" IN THEIR GREATEST DIMENSIONS.
- b. ALL TRANSOM WINDOW GLAZING SHALL BE OF TEMPERED GLASS
- c. GLAZING IN FIXED AND SLIDING PANELS OF SLIDING GLASS DOOR ASSEMBLIES AND PANELS IN SWINGING DOORS OTHER THAN WARDROBE DOORS SHALL BE TEMPERED SAFETY GLAZING.
- d. GLAZING ADJACENT TO A DOOR AND WITHIN THE SAME WALL PLANE AS THE DOOR WHOSE NEAREST EXPOSED EDGE IS WITHIN A 24" ARCH OF THE VERTICAL EDGE OF THE DOOR IN A CLOSED POSITION AND WHOSE BOTTOM EDGE IS LESS THAN 60 INCHES ABOVE THE FLOOR OR WALKING SURFACE SHALL BE TEMPERED SAFETY GLAZING AND SHALL BE IDENTIFIED AS SUCH.
- e. GLAZING IN FIXED PANELS WHICH HAVE A GLAZED AREA IN EXCESS OF 9 SQ. FT. AND THE LOWEST EDGE IS LESS THAT 18" ABOVE THE FINISHED FLOOR AND THE TOP EDGE IS GREATER THAT 36" ABOVE THE FLOOR AND ONE OR MORE WALKING SURFACES ARE WITHIN 36" OF SUCH GLAZING SHALL BE TEMPERED SAFETY GLAZING AND SHALL BE IDENTIFIED AS SUCH.
- f. OTHER OPERABLE WINDOWS SHALL BE PROVIDED WITH SUBSTANTIAL LOCKING DEVICES.
- g. SLIDING GLASS DOORS AND WINDOWS SHALL BE EQUIPPED WITH LOCKING DEVICES AND SHALL BE SO CONSTRUCTED AND INSTALLED THAT THEY REMAIN INTACT AND ENGAGED WHEN SUBJECTED TO THE TESTS SPECIFIED IN THE C.B.C. CHAPTER 24.
- h. SLIDING DOORS AND WINDOWS SHALL BE PROVIDED WITH A DEVICE IN THE UPPER CHANNEL OF THE MOVING PANEL TO PROHIBIT RAISING AND REMOVING OF THE MOVING PANEL IN THE CLOSED OR PARTIALLY OPEN
- ANY RELEASE FOR METAL BARS, GRILLS, GRATES OR SIMILAR DEVICES CONSTRUCTED TO PRECLUDE HUMAN ENTRY THAT ARE INSTALLED SHALL BE LOCATED ON THE INSIDE OF THE ADJACENT ROOM AND AT LEAST 24" FROM THE CLOSEST OPENING THROUGH SUCH METAL BARS, GRILLS, GRATES OR SIMILAR DEVICES THAT EXCEEDS 2" IN ANY DIMENSION. THIS RELEASE DEVICE SHALL BE OPERABLE FROM THE INSIDE WITHOUT THE USE OF A KEY OR SPECIAL KNOWLEDGE OR EFFORT.
- SCREENS, BARRICADES, OR FENCES MADE OF MATERIAL WHICH PRECLUDE HUMAN CLIMBING SHALL BE PROVIDED AT EVERY PORTION OF EVERY ROOF, BALCONY, OR SIMILAR SURFACE WHICH IS WITHIN 8'-0" OF A UTILITY POLE OR

## [C]. FIRE PREVENTION AND SAFETY

- THE 2019 CALIFORNIA FIRE CODE.
- ACCESS TO ALL NEW CONSTRUCTIONS SHALL COMPLY WITH C.B.C. AND ARTICLE 33 OF THE 2019 CALIFORNIA FIRE
- THE CONTRACTOR SHALL BE RESPONSIBLE TO CONSTRUCT ALL FIRE RATED SPACES TO THE REQUIREMENTS OF THE APPLICABLE CODES AND STANDARDS. PROVIDE APPROPRIATE FIRE-RATED ENCLOSURE BEHIND RECESSED LIGHT FIXTURES WHERE REQUIRED.
- PROVIDE OUTSIDE GAS SHUT-OFF VALVE CONSPICUOUSLY MARKED AND PROTECTED.
- EXIT SIGNAGE
- a. THE PATH OF EXIT TRAVEL TO AND WITHIN EXITS IN THIS BUILDING SHALL BE IDENTIFIED BY EXIT SIGNS CONFORMING TO THE REQUIREMENTS OF SECTION 1011. EXIT SIGNS SHALL BE READILY VISIBLE FROM ANY DIRECTION OF APPROACH, AND SHALL BE LOCATED AS NECESSARY TO CLEARLY INDICATE THE DIRECTION OF EGRESS TRAVEL. NO POINT SHALL BE MORE THAN 100 FEET (30480 MM) FROM THE NEAREST VISIBLE SIGN.
- b. PROVIDE APPROVED FLOOR-LEVEL EXIT SIGNS PER C.B.C. SECTION 1011.6 FOR E OCCUPANCY.
- c. PROVIDE EXIT SIGNS AND DIRECTIONAL EXIT SIGNS WITH MIN. 6" HIGH BY 3/4" STROKE BLOCK LETTERS ON A CONTRASTING BACKGROUND.
- d. WHENEVER THE BUILDING IS OCCUPIED, EXIT SIGNS SHALL BE LIGHTED SO THAT THEY ARE CLEARLY VISIBLE.
- e. EXIT SIGNS SHALL BE INTERNALLY OR EXTERNALLY ILLUMINATED. WHEN THE FACE OF AN EXIT SIGN IS ILLUMINATED BY AN EXTERNAL SOURCE, IT SHALL HAVE AN INTENSITY OF NOT LESS THAN 5 FOOT-CANDLES (54 LUX) FROM EITHER OF TWO ELECTRIC LAMPS. INTERNALLY ILLUMINATED SIGNS SHALL BE LISTED AND LABELED AND SHALL BE INSTALLED IN ACCORDANCE WITH THE MANUFACTURER'S INSTRUCTIONS AND SECTION 2702.

- f. SEE REFLECTED CEILING PLANS FOR THE LOCATION OF EXIT SIGNS
- g. EXIT SIGNS SHALL BE ILLUMINATED AT ALL TIMES AND FOR A MINIMUM OF 1-1/2 HOURS IN CASE OF PRIMARY POWER LOSS (C.B.C. SECTION 1011.2-1011.5). THE EXIT SIGNS SHALL ALSO BE CONNECTED TO AN EMERGENCY ELECTRICAL SYSTEM PROVIDED FROM STORAGE BATTERIES, UNIT EQUIPMENT OR AN ON-SITE GENERATOR SET & THE SYSTEM SHALL BE INSTALLED IN ACCORDANCE WITH THE 2007 CALIFORNIA ELECTRICAL CODE.

#### 6. EGRESS DOORS

- a. ALL EXIT EGRESS DOORS SHALL SWING IN THE DIRECTION OF EXIT TRAVEL. EXIT DOORS SHALL BE OPERABLE FORM THE INSIDE WITHOUT USE OF A KEY OR ANY SPECIAL KNOWLEDGE OR EFFORT. SEE C.B.C. SECTION 1008.1.8.3 FOR EXCEPTIONS.
- b. CONTRACTOR TO PROVIDE L.A. COUNTY APPROVED KNOX BOX OR KEY BOX ACCESS AT ALL EXTERIOR GATES AND AUTO-GATE ENTRANCES & EXITS. BOX SHALL BE PROVIDED AT LOCATION TO BE DETERMINED BY FIELD INSPECTOR IN ACCORDANCE WITH FIRE CODE 902.4 AND AS SET FORTH IN FIRE DEPARTMENT REGULATION 5.
- c. WIDTH AND HEIGHT OF REQUIRED EXIT DOORWAYS TO COMPLY WITH C.B.C. SECTION 1003.3.
- d. DOOR HANDLES, LOCK AND OTHER OPERATING DEVICES SHALL BE INSTALLED AT A MIN. 34" AND A MAX. 48" ABOVE THE FINISHED FLOOR. FLUSH BOLTS AND SURFACE BOLTS ARE PROHIBITED.
- e. PANIC HARDWARE IS TO BE INSTALLED AT ALL REQUIRED EXIT LOCATIONS AS SHOWN ON THE DRAWINGS AND PER TITLE 24, SECTION 1017.11.. PANIC HARDWARE SHALL BE PROVIDED ON EXIT DOORS SERVING ROOMS, CORRIDORS, OR STAIRWAYS HANDLING AN OCCUPANT CAPACITY OF 50 OR MORE PERSONS, FROM ANY GROUP A, E OR I OCCUPANCY. ONLY PANIC HARDWARE APPROVED AND LISTED BY THE STATE FIRE MARSHAL SHALL BE
- f. CONTRACTOR TO PROVIDE SIGN "DOOR TO REMAIN UNLOCKED WHILE BUILDING IS OCCUPIED" AT ALL DOORS
- g. ALL EGRESS DOOR OPERATION SHALL ALSO COMPLY WITH C.B.C. SECTION 1008.1.8 1008.1.8.6.

PROVIDE SINGLE STATION SMOKE DETECTORS IN EACH LEVEL TO COMPLY WITH C.B.C. SECTION 907.

- SMOKE AND/OR FIRE DAMPERS ARE REQUIRED AT DUCTS AND AIR TRANSFER OPENINGS IN ACCORDANCE WITH SECTION 716. WHERE BOTH ARE REQUIRED FIRE/SMOKE DAMPERS SHALL BE USED. SMOKE AND FIRE DAMPERS 18. PROVIDE STANDPIPE CLASS III PER C.B.C. SECTION 905.3.1 ARE ALSO REQUIRED AT PENETRATIONS OF AREA OR OCCUPANCY SEPARATIONS WALLS, HORIZONTAL EXITS WALLS, FIRE-RATED SHAFTS, FIRE-RESISTIVE FLOOR-CEILING OR ROOF-CEILING ASSEMBLIES, FIRE-RATED CORRIDOR WALLS OR CEILINGS, AND AREAS OF REFUGE THAT LEAD TO AN OPENING IN THE CORRIDOR.
- EXIT SIGNS SHALL BE ILLUMINATED AT ALL TIMES AND FOR A MINIMUM OF 1-1/2 HOURS IN CASE OF PRIMARY POWER LOSS (C.B.C. SECTION 1011.2-1011.5). THE EXIT SIGNS SHALL ALSO BE CONNECTED TO AN EMERGENCY ELECTRICAL SYSTEM PROVIDED FROM STORAGE BATTERIES, UNIT EQUIPMENT OR AN ON-SITE GENERATOR SET, & THE SYSTEM SHALL BE INSTALLED IN ACCORDANCE WITH THE 2007 CALIFORNIA ELECTRICAL CODE.
- 10. PROVIDE A COMPLETE AUTOMATIC FIRE ALARM AND DETECTION SYSTEM AT RESIDENTIAL BUILDINGS IN ACCORDANCE WITH PMC 14.25.050 AND NFPA 72. FIRE ALARM/DETECTION SYSTEM PLANS TO BE SUBMITTED TO THE BUILDING DEPARTMENT FOR FIRE DEPARTMENT REVIEW WITHIN 30 DAYS OF THE ISSUANCE OF THE BUILDING PERMIT. NO WORK ON THIS SYSTEM SHALL BE STARTED PRIOR TO THE APPROVAL OF PLANS AND THE ISSUANCE OF A FIRE DEPARTMENT PERMIT.

#### 11. FIRE PROTECTION

- a. EMERGENCY WARNINGS SYSTEMS AS PART OF THE FIRE-PROTECTIVE SIGNALING SYSTEM SHALL BE DESIGNED AND INSTALLED IN ACCORDANCE WITH 2019 CALIFORNIA FIRE CODE.
- b. GENERAL CONTRACTOR SHALL SUBMIT COMPLETE PLANS FOR FIRE ALARM AND FIRE SPRINKLER APPROVAL. CONTRACTOR SHALL PAY ALL FEES, COORDINATE ALL REQUIRED PERMITS AND PULLS PERMIT PRIOR TO
- c. AT LEAST ONE CLASS 2A-10B:C PORTABLE FIRE EXTINGUISHER SHALL BE PROVIDED ON EACH FLOOR AND DISTRIBUTED THROUGHOUT THE BUILDING OR PREMISES IN SUCH A MANNER THAT THE HORIZONTAL DISTANCE OF TRAVEL TO THE NEAREST PORTABLE FIRE EXTINGUISHER SHALL NOT EXCEED 75 FEET. (2019 CALIFORNIA
- d. CLASS I, II OR III-A FLAMMABLE LIQUIDS SHALL NOT BE PLACED, STORED OR USED IN GROUP E OCCUPANCIES, EXCEPT IN APPROVED QUANTITIES AS NECESSARY IN LABORATORIES AND CLASSROOMS AND FOR OPERATION AND MAINTENANCE AS SET FORTH IN THE CALIFORNIA FIRE CODE. (C.B.C. SECT 442.5.1)
- e. FIRE SPRINKLERS:
- e.a. THE FIRE SPRINKLER SYSTEM SHALL BE SUPERVISED AS REQUIRED IN THE C.B.C. SECTION 901.6.
- e.a. SUBMIT FIRE SPRINKLER PLANS UNDER SEPARATE PERMIT. SPRINKLER SYSTEM TO BE APPROVED BY PLUMBING DIVISION PRIOR TO INSTALLATION.
- e.b. PLANS SHOWING UNDERGROUND PIPING OF SPRINKLER SYSTEMS SHALL BE SUBMITTED FOR APPROVAL PRIOR TO INSTALLATION.
- e.c. ON-SITE PROTECTION FACILITIES (I.E. HYDRANTS, SPRINKLER SYSTEMS, ETC.) SHALL BE INSTALLED, TESTED AND ACCEPTED PRIOR TO OCCUPANCY.
- e.d. THE INSPECTION, HYDROSTATIC TEST AND FLUSHING OF THE SPRINKLER SYSTEM SHALL BE WITNESSED BY THE PROPER FIRE DEPARTMENT REPRESENTATIVE AND NO UNDERGROUND PIPING SHALL BE COVERED WITH EARTH OR HIDDEN FROM VIEW UNTIL THE FIRE DEPARTMENT REPRESENTATIVE HAS BEEN NOTIFIED AND GIVEN NO LESS THAN 48 HOURS IN WHICH TO INSPECT SUCH INSTALLATIONS.
- e.e. PROVIDE SPRINKLER HEADS AT ALL PROTECTED OPENINGS WHERE INDICATED ON DRAWINGS AND WHERE REQUIRED BY CODE.

#### f. FIRE ALARMS

f.a. THE FIRE ALARM SYSTEM SHALL BE PROPERLY INSTALLED TO COMPLY WITH THE CURRENT ISSUES OF

THE CALIFORNIA STATE FIRE MARSHALLS TITLE 19 AND SHALL BE U.L. OR FACTORY LISTED AND RATED.

- f.b. FIRE ALARM SYSTEM SHALL INCLUDE BOTH AUDIBLE AND VISUAL ALARMS.
- f.c. PROVIDE VISUAL ALARM AS NOTED: THEY SHALL HAVE A VISUAL ALARM CONNECTED TO THE BUILDING EMERGENCY ALARM SYSTEM OR SHALL HAVE A NO-VOLT ELECTRIC RECEPTACLE INTO WHICH SUCH AN ALARM CAN BE CONNECTED. THE FLASHING FREQUENCY OF VISUAL ALARM DEVICES SHALL BE LESS THAN 5 HERTZ. IF SUCH ALARMS USE POWER FROM THE BUILDING, THEY SHALL BE INSTALLED ON THE SAME SYSTEM AS THE AUDIBLE EMERGENCY ALARMS.
- f.d. VISUAL ALARMS SHALL ALSO BE INSTALLED AT LOUNGES, COMMUNITY ROOMS, CLASSROOMS, REST ROOMS, LOBBIES AND ANY OTHER AREA FOR COMMON USE.
- f.e. WRITTEN CERTIFICATION BY THE FIRE ALARM EQUIPMENT DISTRIBUTOR (OR VENDER OR MANUFACTURER) SHALL BE SUBMITTED TO THE ARCHITECT WITH COPY TO THE STATE FIRE MARSHALL STATING THAT THE SYSTEM AND ITS COMPONENT PARTS ARE LISTED AND APPROVED BY THE STATE FIRE MARSHALL AND THAT OF THE CALIFORNIA ADMINISTRATIVE COVE.
- ALL CONSTRUCTION SHALL BE COMPLETED IN COMPLIANCE WITH THE 2019 CALIFORNIA BUILDING CODE (C.B.C.) AND 12. FIRE-RESISTANCE RATED CONSTRUCTION
  - a. FIRE RESISTIVE ASSEMBLIES FOR PROTECTION OF OPENINGS TO COMPLY WITH C.B.C. 715 OR TITLE 24, S4306. b. IN FIRE RESISTIVE EXTERIOR WALL CONSTRUCTION, THE FIRE RESISTIVE RATING SHALL BE MAINTAINED FOR SUCH WALLS PASSING THROUGH ATTIC AREAS OR OTHER AREAS CONTAINING CONCEALED SPACES. C.B.C. SECTION 717.
  - c. VERTICAL OCCUPANCY SEPARATIONS MUST AFFORD A COMPLETE SEPARATION AND MUST EXTEND THROUGH UNDER FLOOR AND ATTIC AREAS, INCLUDING AREAS WHERE FIRE-RESISTIVE CEILINGS ARE SPECIFIED.
  - d. PENETRATIONS IN WALLS REQUIRING PROTECTED OPENINGS MUST BE FIRESTOPPED WITH AN APPROVED MATERIAL. SPACE BETWEEN PENETRATING MATERIALS MUST BE DESIGNED TO PREVENT THE MOVEMENT OF HOT FLAME OR GASES.

13. INTERIOR WALL AND CEILING FINISHES FOR R1 OCCUPANCY AREAS SHALL BE OF 5/8" TYPE 'X' GYPSUM BOARD, AND

SHALL NOT EXCEED A FLAME-SPREAD CLASSIFICATION OF 200 (CLASS III). INTERIOR WALL AND CEILING FINISHES

- FOR EXIT CORRIDORS SHALL NOT EXCEED A FLAME-SPREAD CLASSIFICATION OF 75 (CLASS II). INTERIOR WALL AND CEILING FINISHES FOR ENCLOSED STAIRWAY SHALL NOT EXCEED A FLAME-SPREAD CLASSIFICATION OF 25 (CLASS I) 14. PROVIDE COLLISION BARRIERS ADEQUATE TO PROTECT CONTROL METERS, REGULATORS AND PIPING FOR
- 15. ROOF COVERING SHALL BE CLASS A FIRE RETARDANT.

HAZARDOUS MATERIALS THAT ARE EXPOSED TO VEHICULAR DAMAGE.

- 16. AN OCCUPANT LOAD SIGN SHALL BE POSTED IN EACH CLASSROOM, ASSEMBLY ROOM OR SIMILAR PURPOSE ROOM HAVING AN OCCUPANT LOAD OF 50 OR MORE.
- EGRESS ILLUMINATION a. THE MEANS OF EGRESS, INCLUDING THE EXIT DISCHARGE, SHALL BE ILLUMINATED AT ALL TIMES THE BUILDING

- SPACE SERVED BY THE MEANS OF EGRESS IS OCCUPIED.
- b. THE MEANS OF EGRESS ILLUMINATION LEVEL SHALL NOT BE LESS THAN 1 FOOT-CANDLE AT THE WALKING
- c. THE POWER SUPPLY FOR MEANS OF EGRESS ILLUMINATION SHALL NORMALLY BE PROVIDED BY THE PREMISES OF ELECTRICAL SUPPLY. IN THE EVENT OF ITS FAILURE, ILLUMINATOR SHALL BE AUTOMATICALLY PROVIDED FROM AN EMERGENCY SYSTEM FOR GROUP I, DIVISIONS 1.1 & 1.2 OCCUPANCIES & FOR ALL OCCUPANCIES WHERE THE MEANS OF EGRESS SYSTEM SERVES AN OCCUPANT LOAD OF PF 100 OR MORE.
- d. THE POWER SUPPLY FOR MEANS OF EGRESS ILLUMINATION SHALL NORMALLY BE PROVIDED BY THE PREMISES' ELECTRICAL SUPPLY. IN THE EVENT OF POWER SUPPLY FAILURE, AN EMERGENCY ELECTRICAL SYSTEM SHALL AUTOMATICALLY ILLUMINATE THE FOLLOWING AREAS:
- d.a. AISLES AND UNENCLOSED EGRESS STAIRWAYS IN ROOMS AND SPACES THAT REQUIRE TWO OR MORE
- d.b. CORRIDORS, EXIT ENCLOSURES AND EXIT PASSAGEWAYS IN BUILDINGS REQUIRED TO HAVE TWO OR MORE EXITS.
- d.c. EXTERIOR EGRESS COMPONENTS AT OTHER THAN THE LEVEL OF EXIT DISCHARGE UNTIL EXIT DISCHARGE IS ACCOMPLISHED FOR BUILDINGS REQUIRED TO HAVE TWO OR MORE EXITS.I d.d. INTERIOR EXIT DISCHARGE ELEMENTS, AS PERMITTED IN C.B.C. SECTION 1024.1, IN BUILDINGS REQUIRED
- TO HAVE TWO OR MORE EXITS. d.e. EXTERIOR LANDINGS, AS REQUIRED BY C.B.C. SECTION 1008.1.5. FOR EXIT DISCHARGE DOORWAYS IN BUILDINGS REQUIRED TO HAVE TWO OR MORE EXITS.
- e. THE EMERGENCY POWER SYSTEM SHALL PROVIDE POWER FOR A DURATION OF NOT LESS THAN 90 MINUTES AND SHALL CONSIST OF STORAGE BATTERIES, UNIT EQUIPMENT OR AN ON-SITE GENERATOR. THE INSTALLATION OF THE EMERGENCY POWER SYSTEM SHALL BE IN ACCORDANCE WITH C.B.C. SECTION 2702.
- f. EMERGENCY LIGHTING FACILITIES SHALL BE ARRANGED TO PROVIDE INITIAL ILLUMINATION THAT IS AT LEAST AN AVERAGE OF 1 FOOT-CANDLE (11 LUX) AND A MINIMUM AT ANY POINT OF 0.1 FOOT-CANDLE (1 LUX) MEASURED ALONG THE PATH OF EGRESS AT FLOOR LEVEL. ILLUMINATION LEVELS SHALL BE PERMITTED TO DECLINE TO 0.6 FOOT-CANDLE (6 LUX) AVERAGE AND A MINIMUM AT ANY POINT OF 0.06 FOOT-CANDLE (0.6 LUX) AT THE END OF THE EMERGENCY LIGHTING TIME DURATION. A MAXIMUM-TO-MINIMUM ILLUMINATION UNIFORMITY RATIO OF 40 TO 1 SHALL NOT BE EXCEEDED.

AS NECESSARY.

FOLLOWING LOCATIONS:

- INTERIOR FINISH MATERIALS APPLIED TO WALL AND CEILINGS SHALL BE TESTED AS SPECIFIED IN SECTION 802,
- THE FLAME-SPREAD RATING OF PANELING MATERIALS ON THE WALLS OF THE CORRIDOR, LOBBY AND EXIT ENCLOSURE MUST BE IDENTIFIED ON PLANS.
- k. ANY DECORATIONS SHALL BE NON-COMBUSTIBLE OR FLAME-RETARDANT TREATED IN AN APPROVED MANNER (CURTAINS, DRAPES, SHADES, HANGINGS, ETC.) PER L.A.M.C 57.22. PROVIDE STATE FIRE MARSHALL CERTIFICATE
- 20. FIRE BLOCKING FIRE BLOCKING AND DRAFTSTOPPING SHALL BE INSTALLED PER C.B.C. SECTION 717 IN THE
- a. FIRE BLOCK AT MID-HEIGHT OF WALLS OVER 8'-0" HIGH.

SOFFITS, DROP CEILINGS AND COVE CEILINGS.

- b. IN CONCEALED SPACES OF STUD WALLS AND PARTITIONS, INCLUDING FURRED SPACES, AT THE CEILING AND
- c. IN CONCEALED SPACES OF STUD WALLS AND PARTITIONS, INCLUDING FURRED SPACES, AT 10' INTERVALS ALONG THE LENGTH OF THE WALL.
- d. AT ALL INTERCONNECTIONS BETWEEN CONCEALED VERTICAL AND HORIZONTALS SPACES SUCH AS OCCUR AT
- e. IN CONCEALED SPACES BETWEEN STAIR STRINGERS AT THE TOP AND BOTTOM OF THE RUN AND BETWEEN STUDS ALONG AND IN LINE WITH THE RUN OF THE STAIRS IN THE WALL UNDER THE STAIRS IS UNFINISHED.

IN OPENINGS AROUND VENTS, PIPES, DUCTS, CHIMNEYS, FIREPLACES AND SIMILAR OPENINGS WHICH AFFORD A

PASSAGE OF FIRE AT CEILING AND FLOOR LEVELS, WITH NONCOMBUSTIBLE MATERIALS. PENETRATIONS - PENETRATIONS IN WALLS REQUIRING PROTECTED OPENINGS MUST BE FIRESTOPPED WITH AN

(DESCRIBED BELOW) MUST BE DESIGNED TO PREVENT THE MOVEMENT OF HOT FLAME OR GASES.

APPROVED MATERIAL IN ACCORDANCE WITH SECTION 712.3.1. SPACE BETWEEN PENETRATING MATERIALS

- a. STEEL, COPPER OR FERROUS PIPES OR CONDUITS MAY PENETRATE CONCRETE OR MASONRY WALLS WHERE THE PENETRATING ITEM IS A MAXIMUM 6" DIAMETER AND THE AREA OF THE OPENING THROUGH THE WALL DOES NOT EXCEED 144 SQUARE INCHES.
- b. MEMBRANE PENETRATIONS OF MAXIMUM 2-HR FIRE-RESISTANCE RATED WALL AND PARTITIONS BY STEEL ELECTRICAL OUTLET BOXES NOT EXCEEDING 16 SQUARE INCHES ARE PERMITTED PROVIDED OPENINGS DO NOT EXCEED 100 SQUARE INCHES FOR ANY 100 SQUARE FEET OF WALL AREA. OUTLET BOXES ON OPPOSITE SIDES OF WALLS OR PARTITIONS MUST BE SEPARATED BY A HORIZONTAL DISTANCE OF 24".

c. WHERE WALLS ARE PENETRATED BY OTHER MATERIALS OR WHERE LARGER OPENINGS ARE REQUIRED THAN

PERMITTED IN (B) ABOVE, THEY MUST BE QUALIFIED BY TESTS CONDUCTED IN ACCORDANCE WITH SECTION

22. DUMPSTERS/CONTAINERS - DUMPSTERS AND CONTAINERS WITH AN INDIVIDUAL CAPACITY OF 1.5 CUBIC YARDS (40.5 CUBIC FEET) OR MORE SHALL NOT BE STORED IN BUILDINGS OR PLACES WITHIN 5 FEET OF COMBUSTIBLE WALLS. OPENINGS OR COMBUSTIBLE ROOF EAVES UNLESS DUMPSTERS OR CONTAINERS

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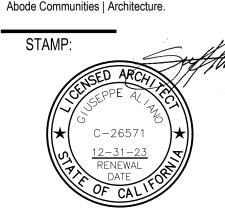
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SHEET NUMBER:

SHEET NAME:



## [D] ENERGY

- 1. THE BUILDING DESIGN MUST MEET THE REQUIREMENTS SET FORTH BY TITLE 24, PART 2, CHAPTER 2-53.
- 2. INSULATION INSTALLER SHALL POST IN A CONSPICUOUS LOCATION IN THE BUILDING A CERTIFICATE SIGNED BY THE INSTALLER AND BUILDER STATING THAT THE INSTALLATION CONFORMS WITH THE REQUIREMENTS OF TITLE 24, CHAPTER 2-53 AND THAT THE MATERIALS INSTALLED CONFORM WITH THE REQUIREMENTS OF TITLE
- 3. ALL INSULATION MATERIALS SHALL BE CERTIFIED BY THE MANUFACTURER AS COMPLYING WITH THE CALIFORNIA QUALITY STANDARDS FOR INSULATING MATERIALS.
- 4. DOORS AND WINDOWS BETWEEN CONDITIONED SPACES AND UNCONDITIONED SPACES SUCH AS CORRIDORS AND THE EXTERIOR OF THE BUILDING SHALL BE FULLY WEATHERSTRIPPED.
- 5. MANUFACTURED DOORS AND WINDOWS SHALL BE CERTIFIED AND LABELED IN COMPLIANCE WITH THE APPROPRIATE INFILTRATION STANDARDS.
- 6. CAULK PLUMBING AND ELECTRICAL PENETRATIONS, ALL WINDOW AND DOOR FRAMES, BETWEEN WALL SOLEPLATES AND FLOOR, AND ALL OTHER OPENINGS IN THE ENVELOPE.
- 7. A NIGHT SETBACK THERMOSTAT SHALL BE INSTALLED.
- 8. 25 LUMENS/WATT EFFICIENCY SHALL BE PROVIDED FOR GENERAL LIGHTING IN KITCHENS AND BATHROOMS (FLUORESCENT LIGHTS).
- 9. DUCTS SHALL BE CONSTRUCTED, INSTALLED AND INSULATED PER CHAPTER 6 OF 2007 CALIFORNIA MECHANICAL CODE.
- 10. ALL OPENINGS (DOORS AND WINDOWS) SHALL BE PROPERLY WEATHER-STRIPPED, CERTIFIED, AND LABELED.
- 11. BACKDRAFT DAMPERS FOR ALL EXHAUST AND FAN SYSTEMS SHALL BE PROVIDED.
- 12. AN R-12 EXTERIOR BLANKET SHALL BE PROVIDED FOR HOT WATER HEATER AND SOLAR TANKS.
- 13. R-3 INSULATION SHALL BE PROVIDED FOR THE FIRST FIVE FEET OF THE WATER HEATER OUTLET PIPE.
- 14. ALL WATER HEATING AND SPACE CONDITIONING EQUIPMENT, SHOWER HEADS AND FAUCETS SHALL BE CALIFORNIA ENERGY COMMISSION CERTIFIED.
- 15. PROVIDE LOW CONSUMPTION WATER CLOSETS THROUGHOUT.
- 16. ALL STEAM AND STEAM CONDENSATION RETURN PIPING AND ALL CONTINUOUSLY CIRCULATING DOMESTIC HEATING OR HOT WATER PIPING SHALL BE INSULATED AS REQUIRED BY THE PLUMBING DIVISION.
- 17. PROVIDE R-13 INSULATION AT WALLS, R-30 AT ROOF, AND R-38 AT FLOOR/CEILINGS AS INDICATED IN TITLE 24

## [E] SOUND

- 1. ALL ELECTRICAL OUTLET BOXES, TV, TELEPHONE AND INTERCOM OUTLETS IN OPPOSITE FACES OF NEW PARTY WALLS TO BE SEPARATED HORIZONTALLY BY 24". BACK AND SIDES OF BOXES TO BE SEALED WITH 1/8" RESILIENT SEALANT AND BACKED BY MINIMUM 2" THICK FIBER INSULATION.
- 2. ALL RIGID CONDUIT, DUCTS PLUMBING PIPES AND APPLIANCE VENTS LOCATED IN PARTY WALLS SHALL BE ISOLATED FROM THE STRUCTURE WITH RESILIENT SEALANT AND BACKED BY MINIMUM 2" THICK FIBER INSULATION.
- 3. ALL VENTILATING AND CONDITIONED AIR DUCTS LOCATED IN SOUND ASSEMBLIES ARE TO BE LINED.
- 4. WHERE THE FINISHED FLOORING IS PART OF A RATED SOUND PROOFING ASSEMBLY, FINISHED FLOORING TO BE INSTALLED AND INSPECTED BEFORE A CERTIFICATE OF OCCUPANCY IS ISSUED.
- 5. AN APPROVED PERMANENT, RESILIENT ACOUSTICAL SEALANT IS TO BE INSTALLED ALONG JOINT BETWEEN FLOOR AND NEW PARTY WALLS.
- 6. ALL PENETRATIONS INTO SOUND RATED PARTITIONS OR FLOOR/CEILING ASSEMBLIES SHALL BE SEALED WITH AN APPROVED RESILIENT SEALANT.
- 7. MINERAL FIBER INSULATION SHALL BE INSTALLED IN JOINT SPACES WHENEVER PLUMBING PIPING OR DUCTWORK PENETRATES A FLOOR/CEILING ASSEMBLY OR WHERE SUCH UNIT PASSES THROUGH THE PLANE OF THE FLOOR/CEILING ASSEMBLY FROM WITHIN A WALL. THE INSULATION SHALL EXTEND 12" BEYOND THE PIPE OR DUCT.
- 8. PROVIDE CONSTRUCTION DETAILS OF THE SOUND RATED PARTITION BETWEEN SOUND TRANSMISSION CLASS (STC) 50 TO 54. PARTITIONS SHALL HAVE BEEN TESTED AND APPROVED FOR A STC RATING OF NOT LESS THAN 50 (45 IF FIELD TESTED). 91.3501(D)2
- 9. FLOOR-CEILING ASSEMBLIES SHALL HAVE BEEN TESTED AND APPROVED FOR A SOUND TRANSMISSION CLASS (STC) RATING AND AN IMPACT INSULATION CLASS (IIC) RATING OF NOT LESS THAN 50.

#### [F] BEST MANAGEMENT PRACTICES

- 1. AS THE ARCHITECT/ENGINEER OF RECORD, I HAVE SELECTED APPROPRIATE BEST MANAGEMENT PRACTICES (BMPS) TO EFFECTIVELY MINIMIZE THE NEGATIVE IMPACTS OF THIS PROJECT'S CONSTRUCTION ACTIVITIES ON STORM WATER QUALITY. THE PROJECT OWNER AND CONTRACTOR ARE AWARE THAT SELECTED BMPS MUST BE INSTALLED, MONITORED AND MAINTAINED TO ENSURE THEIR EFFECTIVENESS. THE BMPS NOT SELECTED FOR IMPLEMENTATION ARE REDUNDANT OR DEEMED NOT APPLICABLE TO THE PROPOSED CONSTRUCTION ACTIVITIES.
- 2. THE LANDSCAPE DESIGNER RESPONSIBLE FOR ANY LANDSCAPING FOR THIS PROJECT SHOULD BE ADVISED TO UTILIZE PLANTING AND IRRIGATION TECHNIQUES THAT LEND THEMSELVES TO OPTIMUM CONSERVATION OF WATER RESOURCES. SEE APPENDIX CHAPTER 33.

### [G] GLAZING

- 1. EACH LIGHT OF SAFETY GLAZING MATERIAL INSTALLED IN HAZARDOUS LOCATIONS SHALL BE IDENTIFIED BY A PERMANENT LABEL THAT SPECIFIES LABELER, AND STATES THAT SAFETY GLAZING MATERIAL HAS BEEN USED IN SUCH INSTALLATIONS. THE FOLLOWING SHALL BE CONSIDERED SPECIFIC HAZARDOUS LOCATIONS FOR THE PURPOSE OF GLAZING:
- A. GLAZING IN INGRESS & EGRESS DOORS EXCEPT JALOUSIES.

B. GLAZING IN FIXED AND SLIDING PANELS OF SLIDING DOOR ASSEMBLIES AND PANELS IN SWINGING DOORS OTHER THAN WARDROBE DOORS.

- C. GLAZING IN STORM DOORS.
- D. GLAZING IN ALL UNFRAMED SWINGING DOORS.
- E. GLAZING IN DOORS & ENCLOSURES FOR HOT TUBS, WHIRLPOOLS, SAUNA'S, STEAM ROOMS, BATHTUBS AND SHOWERS.
- F. GLAZING IN FIXED AND OPERABLE PANELS ADJACENT TO A DOOR WHERE THE NEAREST EXPOSED EDGE OF THE GLAZING IS WITHIN A 24" (610 MM) ARC OF VERTICAL EDGE OF THE DOOR IN A CLOSED POSITION AND WHERE THE BOTTOM EXPOSED EDGE OF THE GLAZING IS LESS THAN 60" (1,525 MM) ABOVE THE WALKING
- G. GLAZING IN AN INDIVIDUAL FIXED OR OPERABLE PANEL, OTHER THAN DESCRIBED IN ITEMS E AND F THAT MEET ALL OF THE FOLLOWING CONDITIONS:
- EXPOSED AREA OF AN INDIVIDUAL PANE GREATER THAN 9 SQ. FT. (0.84 SQARE METERS) EXPOSED BOTTOM EDGE LESS THAN 18" (457 MM) ABOVE THE FLOOR.
- III. EXPOSED TOP EDGE GREATER THAN 36" (914 MM) ABOVE THE FLOOR. ONE OR MORE WALKING SURFACES WITHIN 36" (914 MM) HORIZONTALLY OF THE PLANE OF THE GLAZING.

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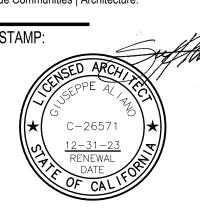
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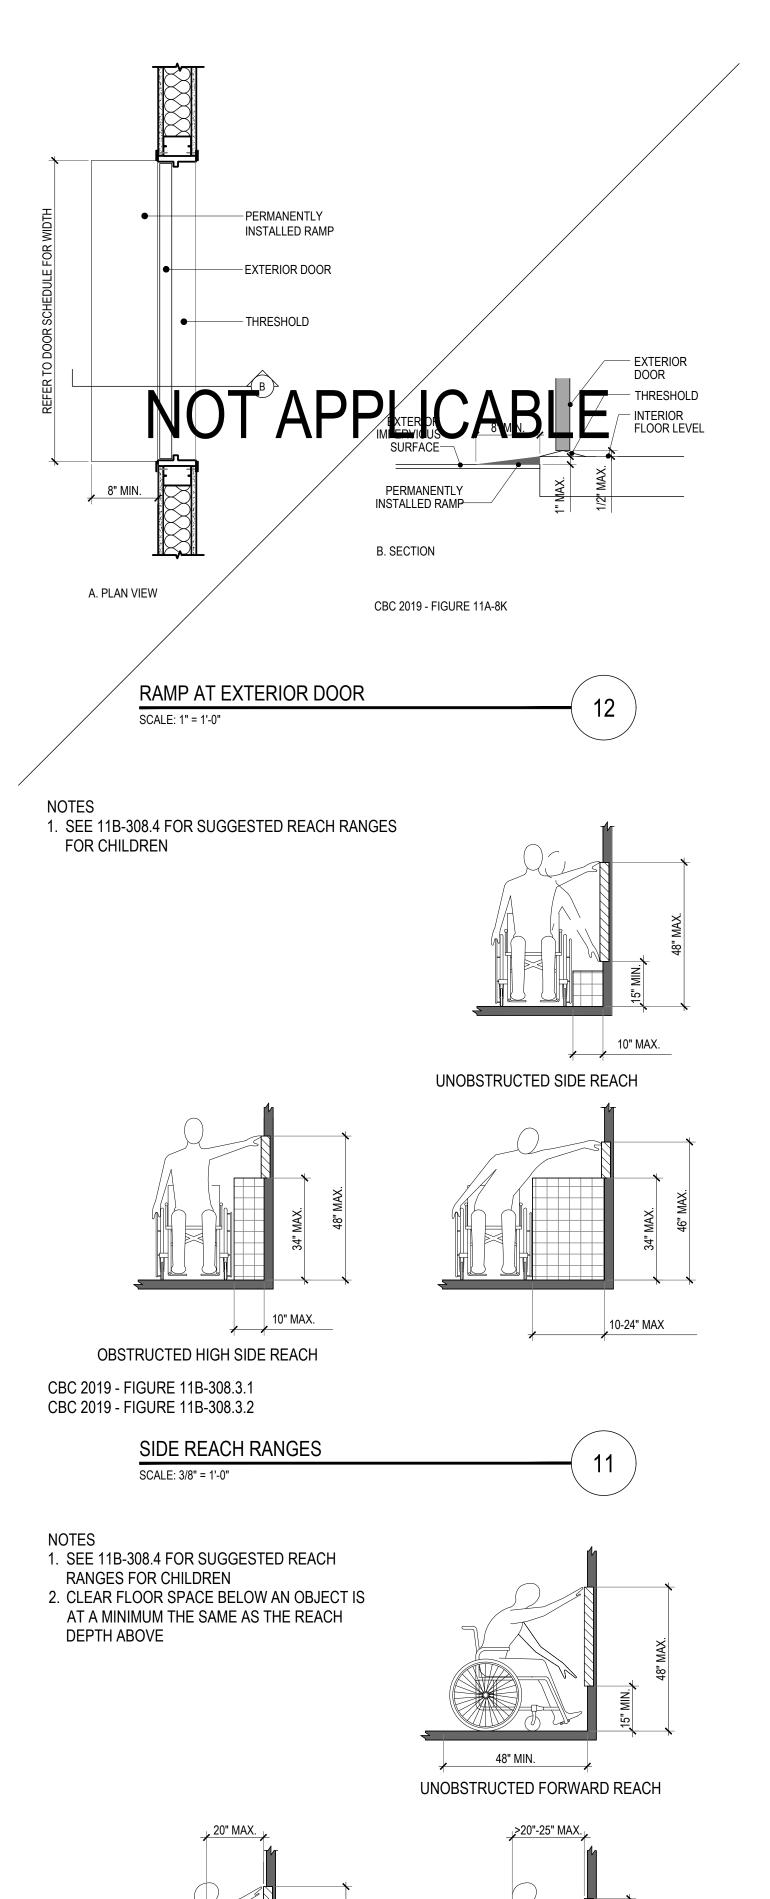
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SHEET NUMBER:



48" MIN.


SCALE: 3/8" = 1'-0"


CBC 2019 - FIGURE 11B-308.2.1

CBC 2019 - FIGURE 11B-308.2.2

OBSTRUCTED HIGH FORWARD REACH

FORWARD REACH RANGES

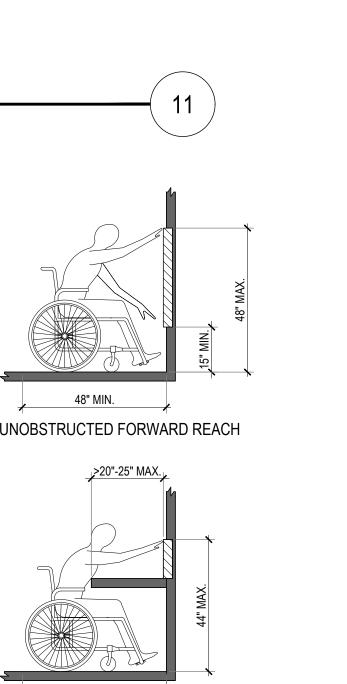

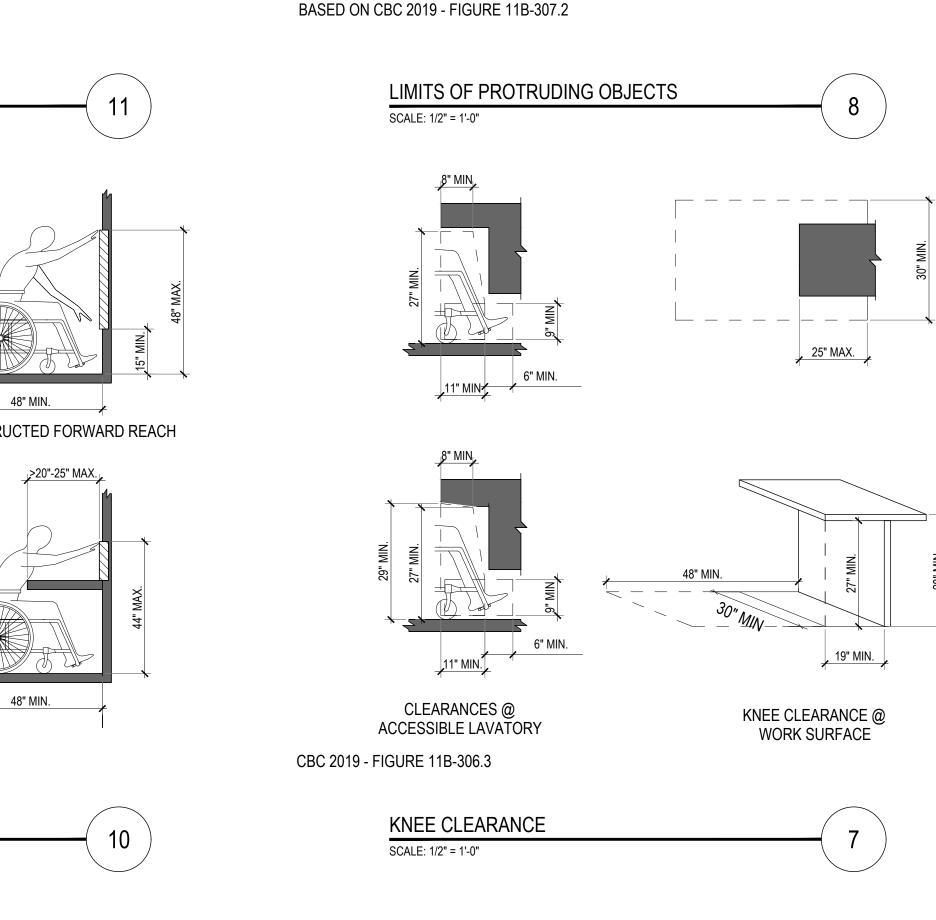

ხე 12" MAX


CBC 2019 - FIGURE 11B-307.3

SCALE: 3/8" = 1'-0"

POST-MOUNTED PROTRUDING OBJECTS

4" MAX INTO CIRCULATION PATH


 $4\frac{1}{2}$ " MAX FOR HANDRAILS

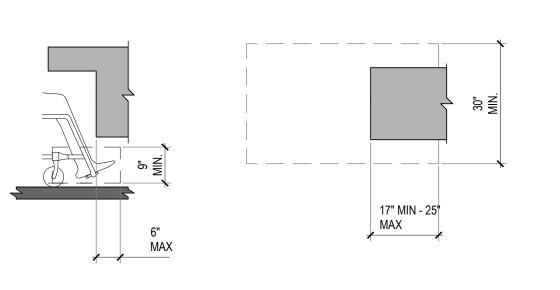


CBC 2019 - FIGURE 11B-306.2

X > 12"

X > 12"

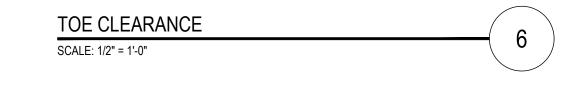

1. CENTERING CLEAR FLOOR SPACE IS REQUIRED ONLY AT DRINKING FOUNTAINS, KITCHEN WORK SURFACES, AND WASHERS AND DRYERS 36" MIN.

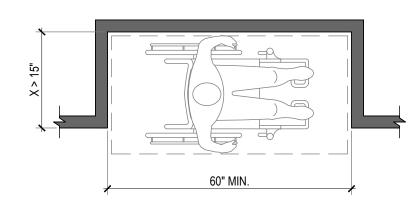


CBC 2019 - FIGURE 11B-305.7.1 (FORWARD) CBC 2019 - FIGURE 11B-305.7.2 (PARALLEL)

## MANEUVERING CLEARANCES IN ALCOVES SCALE: 1/2" = 1'-0"

1. CLEAR FLOOR OR GROUND SPACES SHALL BE STABLE, FIRM, SLIP RESISTANT, FREE OF LEVEL CHANGES, AND NOT SLOPE MORE THAN 1:48

2. CLEAR FLOOR SPACE IS A VOLUME TO A HEIGHT OF 80"

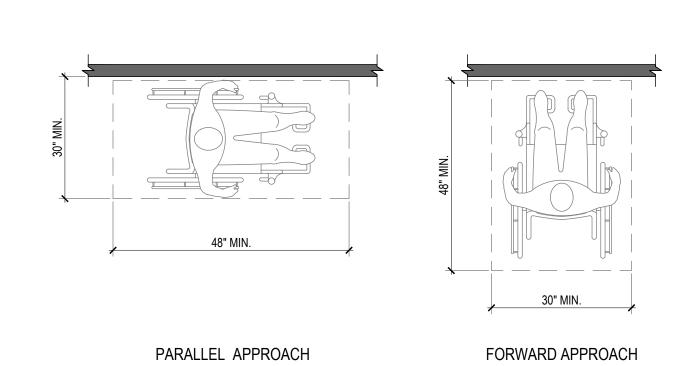



CBC 2019 - FIGURE 11B-305.5

**CLEAR FLOOR SPACE** SCALE: 1/2" = 1'-0"

- 1. SHALL BE LEVEL WITH A MAX. SLOPE OF 1:48 (2%) WITH NO HEIGHT CHANGES
- 2. REQUIRES FIRM, STABLE, AND SLIP RESISTANT SURFACE
- 3. CAN USE KNEE/TOE CLEARANCE WITH A CLR. HEIGHT OF 27" MIN UNDER OBJECTS 4. T-SHAPED TURNING SPACE CAN USE KNEE/TOE CLEARANCE AT ONE END ONLY
- 5. DOORS CAN SWING INTO TURNING SPACE
- 6. TURNING SPACE CAN OVERLAP OTHER SPACE REQUIREMENTS, INCLUDING CLEAR FLOOR SPACE REQUIRED AT ELEMENTS & FIXTURES

**TURNING SPACES** SCALE: 1/2" = 1'-0"

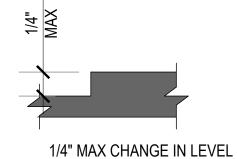

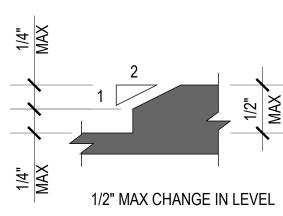

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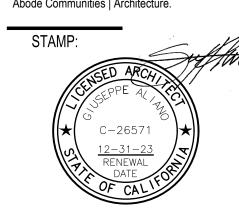
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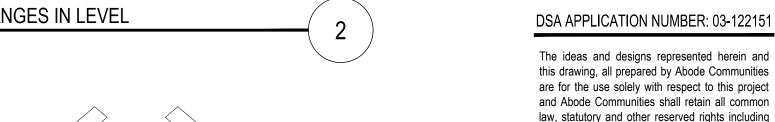



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SHEET NAME: ACCESSIBILITY -**BUILDING BLOCKS** 

SHEET NUMBER:

G3.01



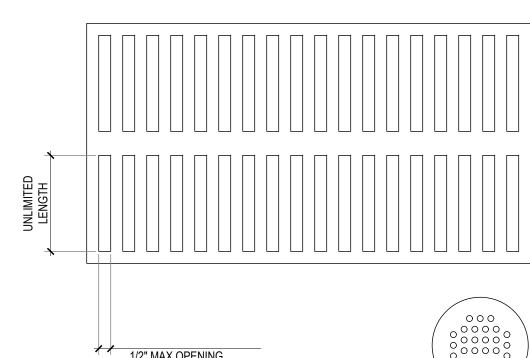



RESTROOM FLOOR DRAINS TO


CBC 2019 - FIGURE 11B-302.3

NOTE: IN LOCATIONS WHERE THERE IS NO DOMINANT FLOW PATTERN, OPENINGS SHOULD BE 1/2" MAX. IN ALL DIRECTIONS.

> **OPENINGS IN FLOOR** SCALE: 3" = 1'-0"

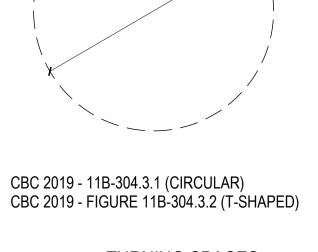

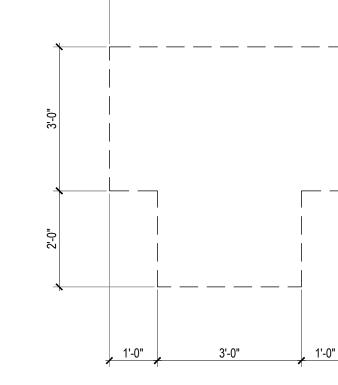

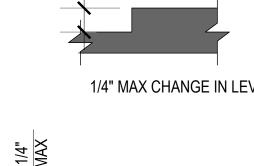


CBC 2019 - FIGURE 11B-303.2 (VERTICAL) CBC 2019 - FIGURE 11B-303.3 (BEVELED)

> MAXIMUM CHANGES IN LEVEL SCALE: 1'-0" = 1'-0"


DOMINANT DIRECTION OF TRAVEL 1/2" MAX OPENING


HAVE 1/4" MAX OPENING

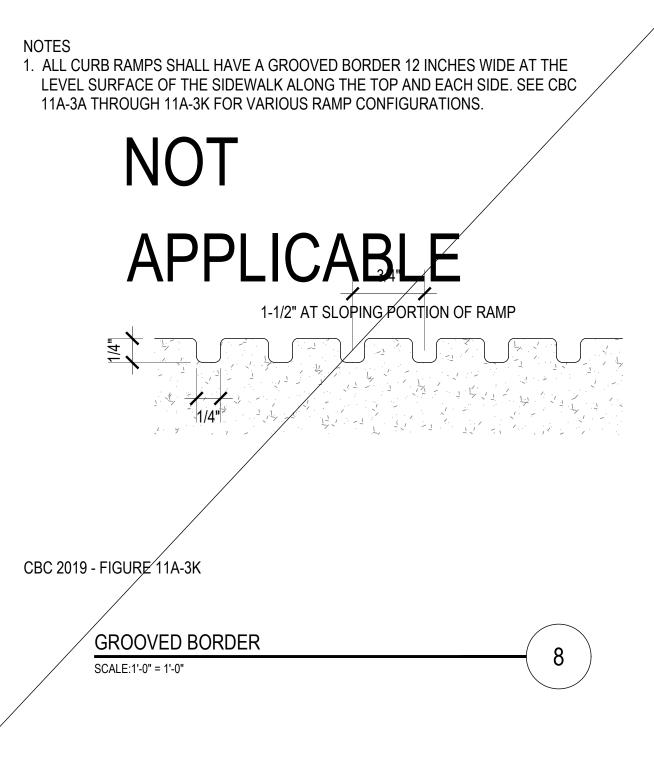

1. REFER TO ARCHITECTURAL DRAWINGS FOR RAMP DIMENSIONS


- 2. RAMP WIDTH TO BE A MIN OF 36" FOR GROUP OCCUPANCY SERVING AN OCCUPANT LOAD OF 50 OR LESS AND A MIN. OF 60" FOR 300 OR MORE. ALL OTHER PEDESTRIAN RAMPS ON ACCESSIBLE ROUTES SHALL BE A MIN. OF 48" IN WIDTH. HANDRAILS ARE ALLOWED TO PROJECT INTO THE REQUIRED CLEAR WIDTH AT EACH SIDE MAX 31/2".
- 3. DOORS, IN ANY POSITION, SHALL NOT REDUCE THE MINIMUM DIMENSION OF THE RAMP LANDING TO LESS THAN 42 INCHES.
- 4. RAMP RUNS SHALL HAVE A RUNNING SLOPE NOT STEEPER THAN 1:12 AND THE CROSS SLOPE OF RAMP RUNS SHALL NOT BE STEEPER THAN 1:48.
- 5. RISE FOR ANY RAMP RUN SHALL BE A MAXIMUM OF 30"
- 6. EXTERIOR LANDINGS TO BE SLOPED UP TO 1:48 TO PREVENT ACCUMULATION OF WATER

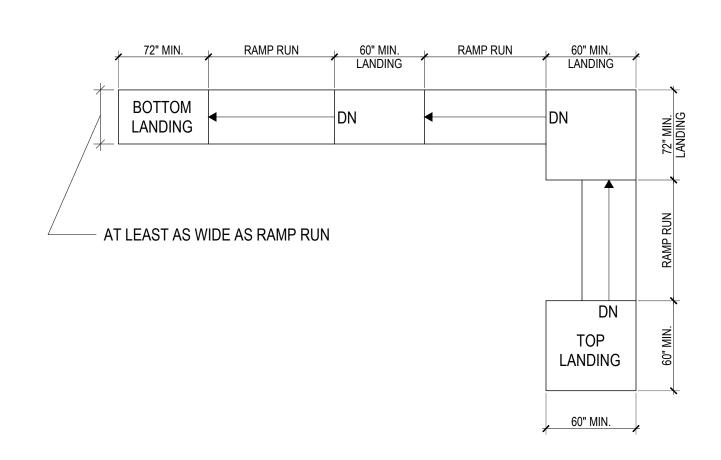

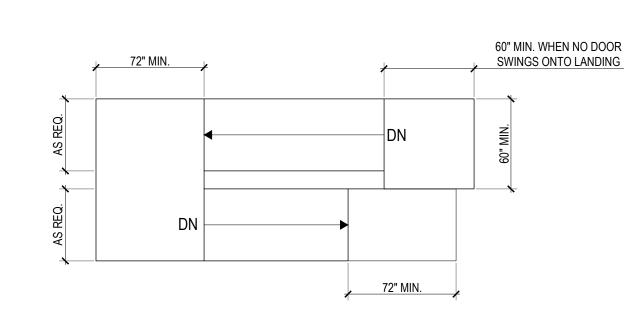

BASED ON CBC 2019 - FIGURE 11B-405.7 BASED ON CBC 2019 - FIGURE 11A-6D.A

> RAMP LANDINGS SCALE: 3/16" = 1'-0"

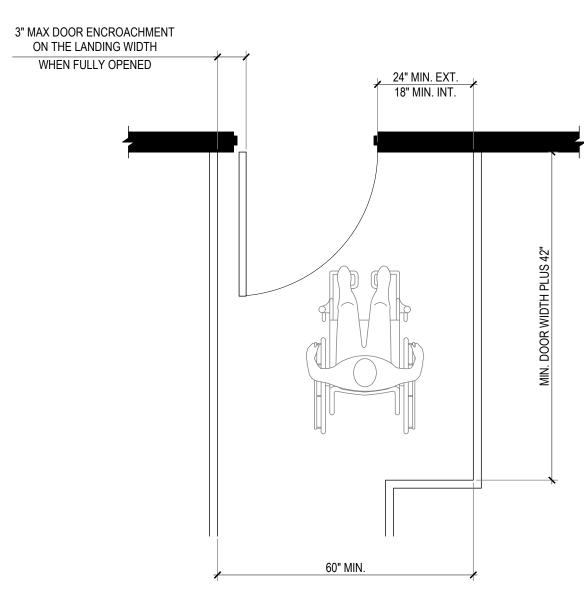

CBC 2019 - FIGURE 11A-6D.B RAMP LANDING AT DOORWAY -FRONT APPROACH SCALE: 1/2" = 1'-0"

1. DOOR HARDWARE MOUNTING HEIGHTS TO BE 34" MIN. AND 44" MAX. A.F.F.

(a) front approach, pull side

(d) hinge approach, pull side

(h) latch approach, pull side

48" MIN. CBC 2019 - FIGURE 11B-404.2.6

CBC 2019 - FIGURE 11A-8H.A DOORS AND GATES IN SERIES SCALE: 1/4" = 1'-0"

1. DOOR MANEUVERING CLEARANCES MAY OVERLAP

2. DOOR SWINGS MAY OVERLAP MANEUVERING CLEARANCES

3. WALLS AND OTHER OBSTRUCTIONS CAN OFFSET THE MANEUVERING CLEARANCE UP TO 8" FROM THE FACE OF THE DOOR. DOORS AT DEEPER RECESSED MUST PROVIDE A FORWARD APPROACH LOCATED 8" MAXIMUM FROM THE FACE OF THE DOOR.

CLEAR AT EXT.


CLEAR AT INT.

DOORS

36" MIN.

2. PUSH SIDE OF DOOR TO HAVE A SMOOTH FINISH UP TO A HEIGHT OF MIN. 10" A.F.F.


(c) front approach, push side, door provided with both closer and latch

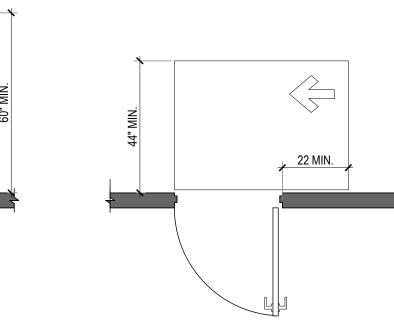


(f) hinge approach, push side

(j) latch approach, push side

(b) front approach, push side

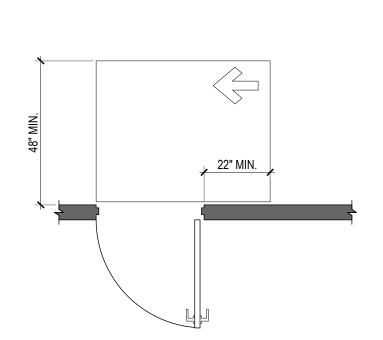

(g) hinge approach, push side, door provided with both closer and latch

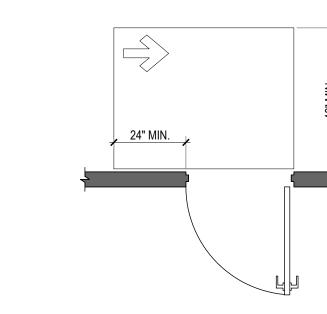

(k) latch approach, push side, door provided with closer

CBC 2019 - FIGURE 11B-404.2.4.1

MANEUVERING CLEARANCES AT MANUAL SWINGING DOORS AND GATES


SCALE: 3/8" = 1'-0"

32 MIN. HINGE DOOR SLIDING DOOR **FOLDING DOOR** 

CBC 2019 - FIGURE 11B-404.2.3

**CLEAR WIDTH OF DOORWAYS** SCALE: 3/8" = 1'-0"

EXCEPTION: WHERE THE CLEAR WIDTH AT THE TURN IS 60" MIN. COMPLIANCE WITH SECTION 11B-403.5.2 SHALL NOT BE REQUIRED

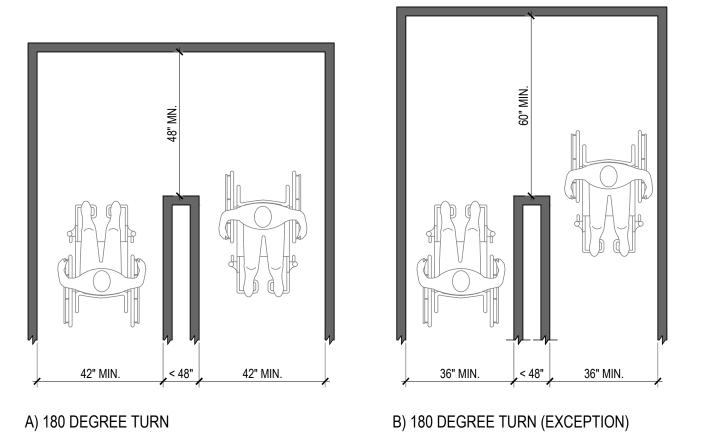


CBC 2019 - FIGURE 11B-403.5.2

CLEAR WIDTH AT TURN AT ACCESSIBLE ROUTE SCALE: 3/8" = 1'-0"

NOTES

1. PER CBC 2019 FIGURE 11A-1E, MIN. WIDTH REQUIRED FOR TWO WHEELCHAIRS SHALL BE 60" CLEAR FOR A MIN. LENGTH OF 60"

2. PER CBC 2019 FIGURE 11A-1L(a), MIN. CLEAR WIDTH OF CORRIDORS IS 44" CLEAR

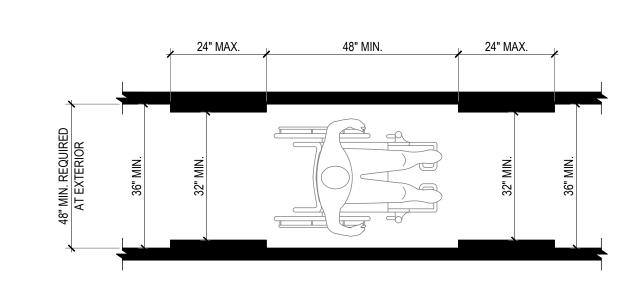

CBC 2019 - FIGURE 11B-403.5.1

CLEAR WIDTH AT ACCESSIBLE ROUTE SCALE: 1/2" = 1'-0"

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### abode communities architecture

PROJECT:

#### LAEP EARLY CHILDHOOD CENTER

13928 KORNBLUM AVE. HAWTHORNE, CA 90250

Los Angeles Education Partnership 1541 Wilshire Blvd., Suite 200 Los Angeles, CA 90017 T: 213.622.5237

ARCHITECT:

**Abode Communities** 1149 S. Hill Street, Suite 700 Los Angeles, CA 90015 T: 213.629.2702

CONSULTANTS:


**Breen Engineering** 1983 W. 190th St., Suite 200 Torrance, CA 90504 T: 310.464.8404

MECHANICAL/ **ELECTRICAL/ PLUMBING Breen Engineering** 1983 W. 190th St., Suite 200 Torrance, CA 90504 T: 310.464.8404

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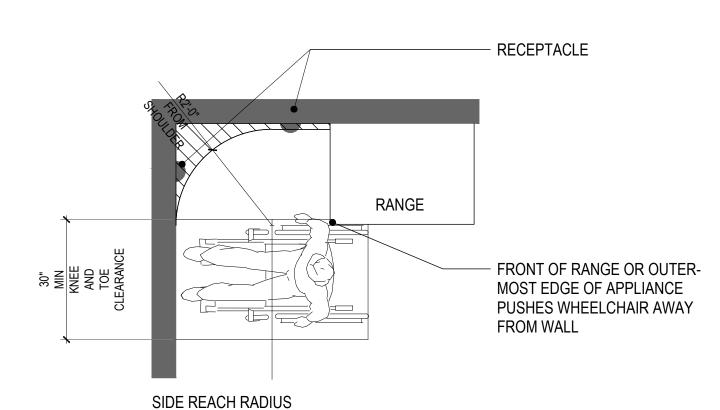



DATE REV PROGRESS SET 02.01.22 DSA PROGRESS SET 03.02.22 DSA APPLICATION SET 04.01.22 DSA BACK-CHECK SET 10.05.22 DSA BACK-CHECK SET 10.24.22 DSA BACK-CHECK SET 11.01.22

SHEET NAME: ACCESSIBILITY -ACCESSIBLE ROUTES

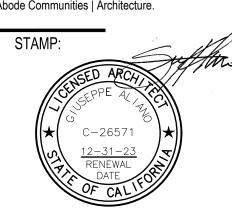
> SHEET NUMBER: G3.02

- 1. THE LOCATION REQUIREMENTS FOR ELECTRICAL OUTLETS BELOW ARE IN ADDITION TO
- ELECTRICAL CODE REQUIREMENTS
- 2. THE LOW REACH RANGE FOR ELECTRICAL OUTLETS SHALL BE MEASURED TO THE BOTTOM OF THE OUTLET BOX, AND THE HIGH REACH RANGE SHALL BE MEASURED TO THE TOP OF THE OUTLET BOX PER CBC 2019 11B-308.1.2
- 3. ONLY ONE CORNER OUTLET IS REQUIRED TO BE LOCATED MIN. 36" FROM THE CORNER PER
- CBC 2019 11B-205.1, EXCEPTION 9 4. ALL RECEPTACLE OUTLETS TO BE ACCESSIBLE PER CBC 11B-205.1
- 5. OUTLETS BEYOND A 24" RADIUS FROM THE CENTERLINE OF THE LONG EDGE OF A CLEAR FLOOR SPACE WILL NOT BE CONSIDERED TO BE ACCESSIBLE.




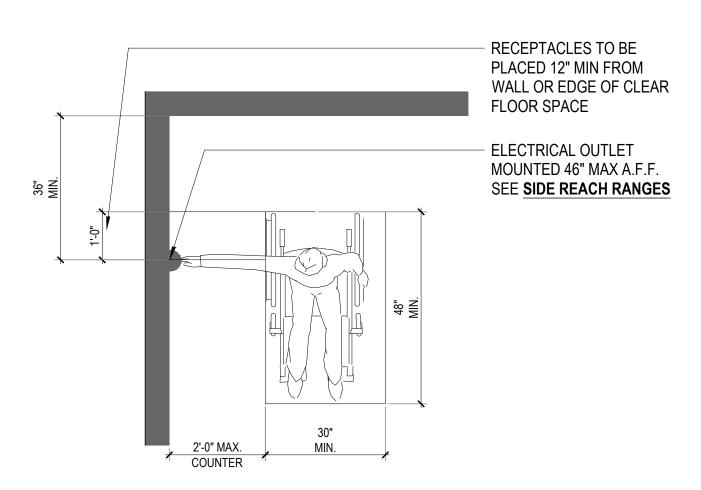

SIDE REACH AT CORNER

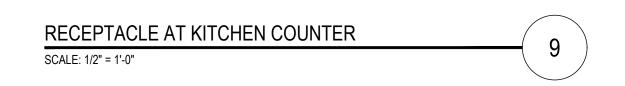


- 1. HANDRAIL TO RETURN TO WALL, GUARD OR THE LANDING SURFACE, OR SHALL BE CONTINUOUS TO THE HANDRAIL OF AN ADJACENT RAMP RUN.
- 2. WHERE THE RAMP SURFACE IS NOT BOUND BY A WALL OR FENCE, THE RAMP SHALL COMPLY WITH ONE OF THE FOLLOWING REQUIREMENTS:
- A. GUIDE CURB AT A MINIMUM OF 2" IN HEIGHT SHALL BE PROVIDED CONTINUOUS
- AND UNINTERRUPTED AT EACH SIDE OF THE RAMP
- B. WHEEL GUIDE RAIL SHALL BE PROVIDED, CENTERED 3" + 1" ABOVE THE SURFACE OF THE RAMP SO A 4" DIAMETER BALL CANNOT BE PLACED ANYWHERE WITHIN 4" OF THE RAMP SURFACE

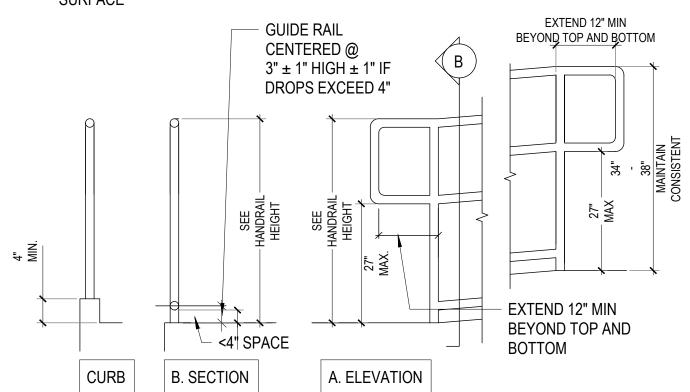

BASED ON CBC 2019 11B-510.1

RAMP HANDRAIL EXTENSION AND EDGE PROTECTION SCALE: 3/4" = 1'-0"

- 1. FLAT TRAVEL SURFACES THAT ADJOIN VEHICULAR TRAFFICWAYS REQUIRE A 36" SECTION OF TRUNCATED DOME DETECTABLE WARNING SURFACE 2. ALL CURB RAMPS SHALL HAVE A GROOVED BORDER 12" WIDE AT THE LEVEL SURFACE OF THE SIDEWALK ALONG THE TOP AND EACH SIDE
- 3. CROSS SLOPE OF LANDING AREAS SHALL HAVE A MAX. SLOPE OF 2% IN ALL DIRECTIONS
- 4. MAX. SLOPES OF ADJOINING GUTTERS, ROAD SURFACE IMMEDIATELY ADJACENT TO THE CURB RAMP, OR ACCESSIBLE ROUTE, SHALL NOT EXCEED 1:20 WITHIN 48" OF THE TOP AND BOTTOM OF THE CURB RAMP

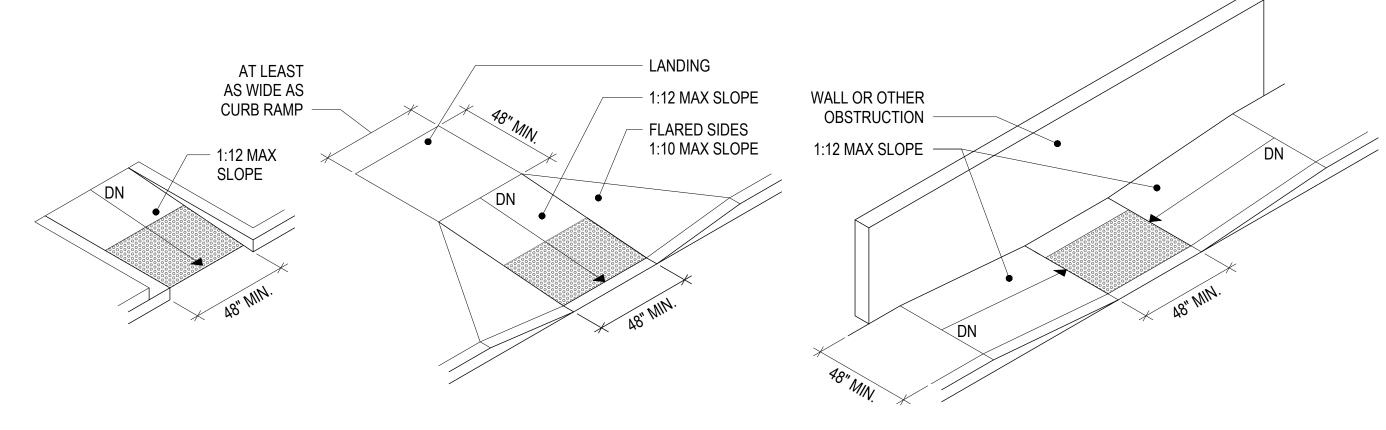


BASED ON CBC 2019 - FIGURE 11B-406.2.2 BASED ON CBC 2019 - FIGURE 11B-406.3.2 BASED ON CBC 2019 - FIGURE 11B-406.5.3


**CURB RAMPS** 

SCALE: 1/4" = 1'-0"

#### **NOTES**

- 1. VERIFY RECLAIM LOCATION AND PHONE NUMBER WITH OWNER PRIOR TO FABRICATION
- 2. LOCATE AT EACH VEHICULAR ENTRY OR VISIBLE AND ADJACENT TO EACH ACCESSIBLE STALL

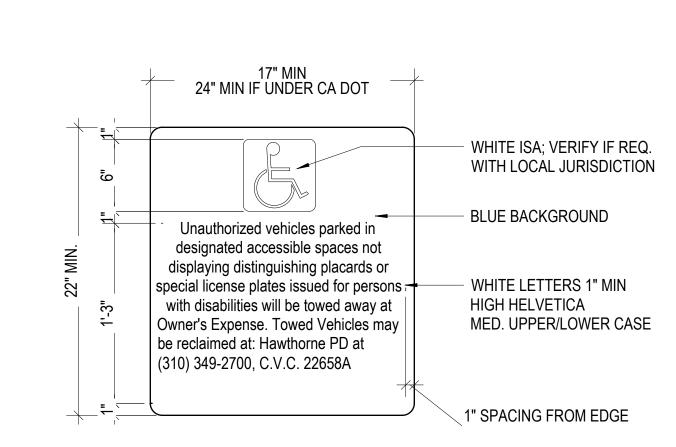

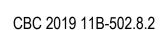


**TOW AWAY SIGN** 


CBC 2019 - FIGURE 11B-502.3.3

SCALE: 1/4" = 1'-0"

ACCESSIBLE VEHICLE PARKING SPACES

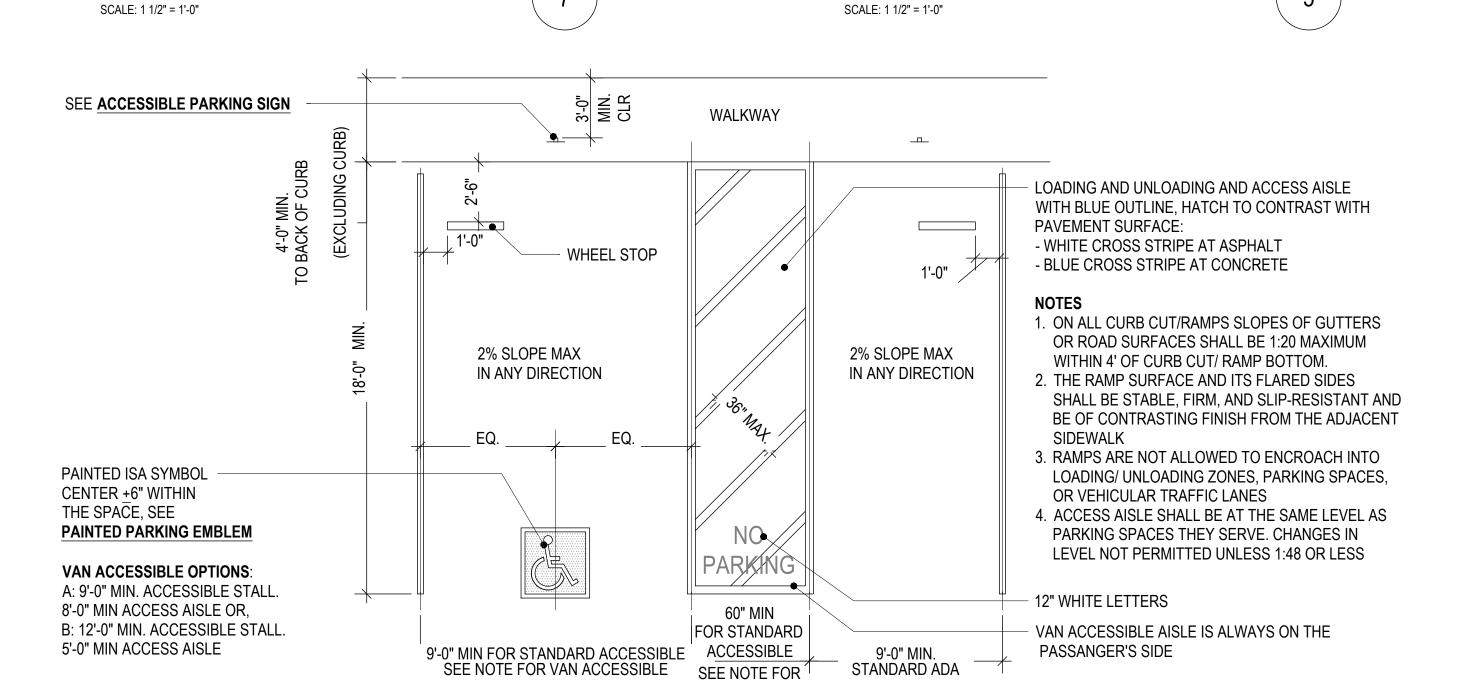

**VAN ACCESSIBLE** 

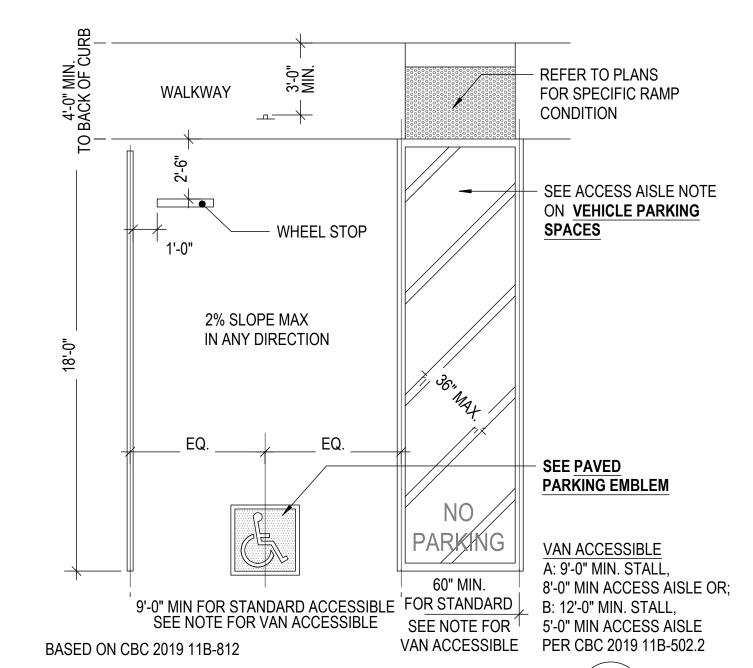

SINGLE ACCESSIBLE STALL

SCALE: 1/4" = 1'-0"

1/2" RADIUS (TYP.)

PARKING

MINIMUM FINE \$250

VAN ACCESSIBLE

ACCESSIBLE PARKING SIGN

WEST SIGN TION PATH ON WALL AT

MIN. TO LOV.
IN CIRCULATION CONTED O

A.F. A.F. 60" I

CBC 2019 11B-502.6

BLUE (COL. NO. 15090 IN FEDERAL STANDARD

595B) REFLECTORIZED SIGN CONSTRUCTED

OF PORCELAIN STEEL WITH BEADED TEXT OR

ACCESSIBILITY AND LETTERS TO BE WHITE

**EQUAL. INTERNATIONAL SYMBOL OF** 

AREA OF SIGN TO BE MIN. 70 SQ. IN.

DESIGNATE FOR "VAN ACCESSIBLE"

STEEL POST WHERE REQUIRED

FOR WALKWAY CLEARANCES

SLOPE AWAY FROM STEEL POST

3/4" LETTERS, 1/2" SPACE BETWEEN EDGE

SEE SITE AND FLOOR PLANS FOR LOCATIONS

SEE ACCESSIBLE VEHICLE PARKING SPACES

SIGN TO BE EITHER POST OR WALL MOUNTED

CONCRETE FILL DRYPACK, FILL TO TOP AND


IMMEDIATELY ADJACENT OR DIRECTLY IN


WHERE APPROPRIATE

OF SIGN AND TEXT

FRONT OF THE STALL

CONCRETE FOOTING

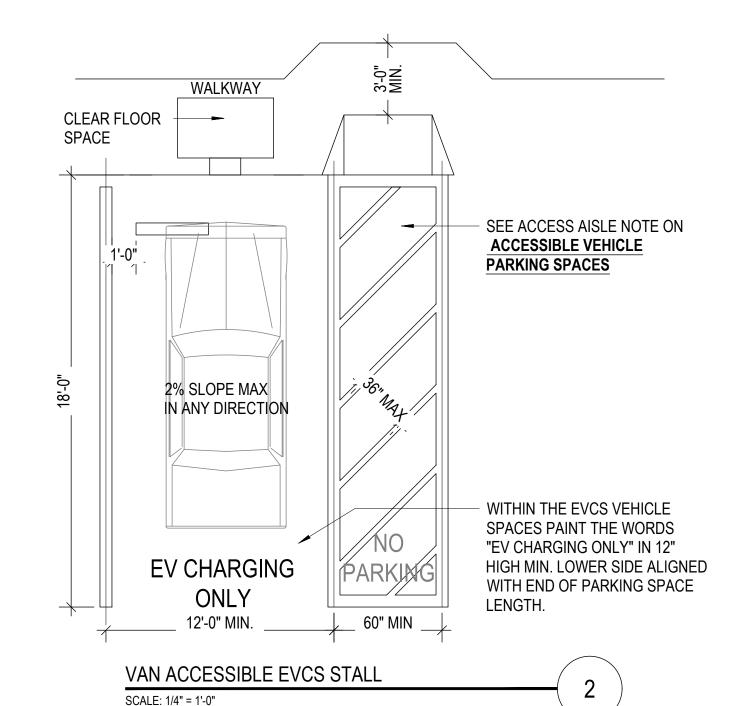

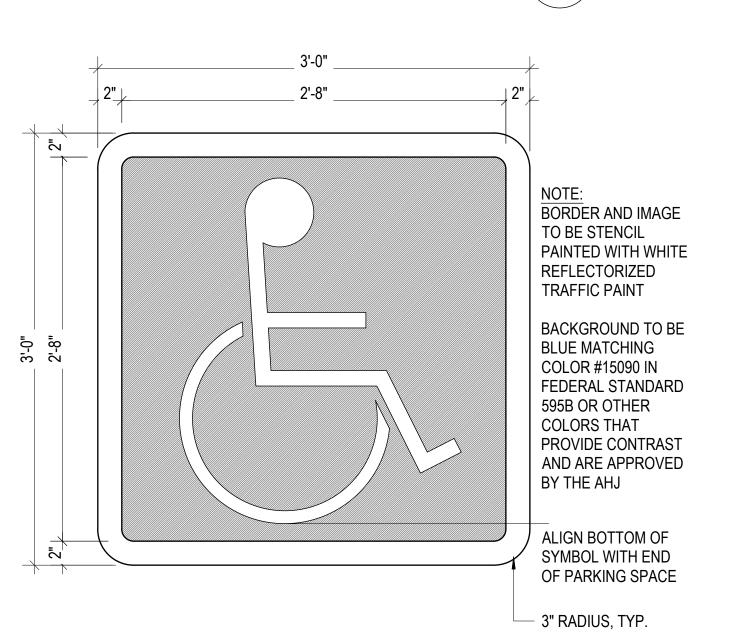

CBC 2019 - FIGURE 11B-502.6.4

PAINTED PAVEMENT EMBLEM SCALE: 1 1/2" = 1'-0"

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**CONSULTANTS:** 


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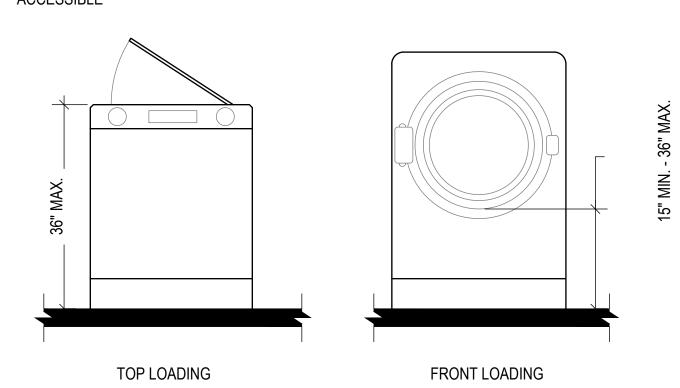
SHEET NAME: ACCESSIBILITY - SITE & BUILDING ELEMENTS

SHEET NUMBER:


G3.03

#### **NOTES**


- 1. A 30" X 48" CLEAR FLOOR SPACE COMPLYING WITH 11B-305 AND CENTERED ON THE APPLIANCE SHALL BE PROVIDED FOR PARALLEL APPROACH
- 2. OPERABLE PARTS SHALL NOT REQUIRE TIGHT GRASPING, PINCHING OR TWISTING OF THE WRIST OR REQUIRE MORE THAN 5 LBS OF FORCE TO ACTIVATE
- 3. WHERE THREE OR FEWER WASHING MACHINES ARE PROVIDED, AT LEAST ONE SHALL BE ACCESSIBLE WHERE MORE THAN THREE ARE PROVIDED AT LEAST TWO SHALL BE **ACCESSIBLE**

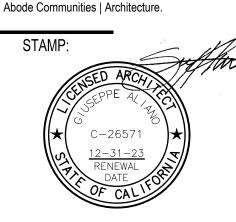


#### CBC 2019 - FIGURE 11B-611.4

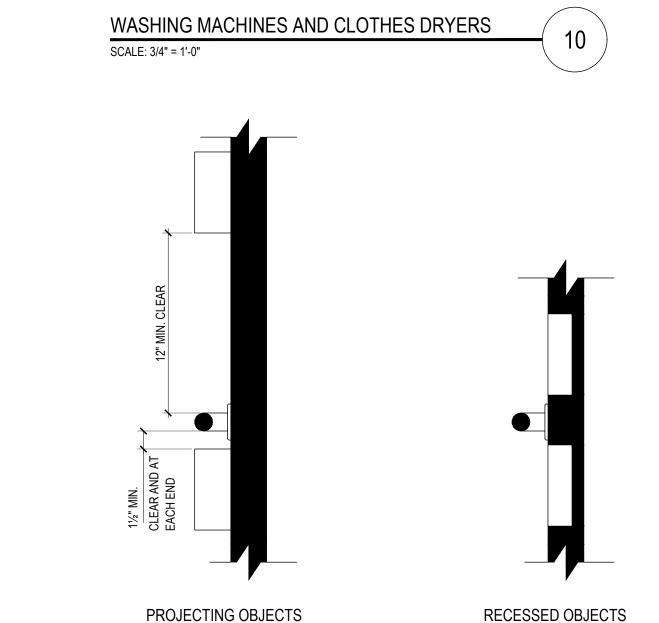

CBC 2019 - FIGURE 11B-609.3

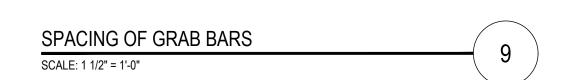

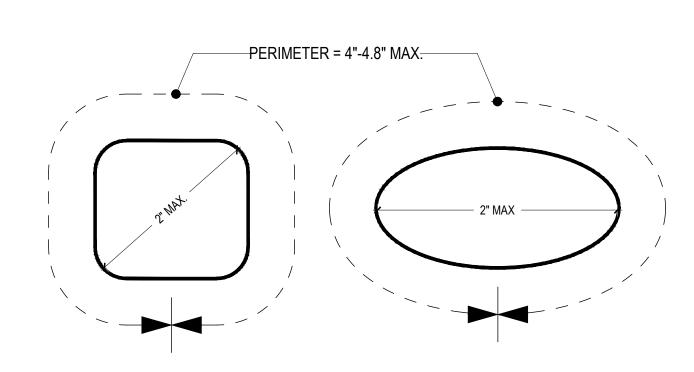

CBC 2019 - FIGURE 11B-609.2.2


GRAB BAR NON-CIRCULAR CROSS SECTIONS SCALE: 3/4" = 1'-0"

- 1. GRAB BAR TO HAVE 12" MIN CLEAR ABOVE AND 1-1/2" MIN CLEAR BELOW AND AT EACH END
- 2. ANY SURFACES ADJACENT TO HANDRAILS SHALL BE FREE OF SHARP OR ABRASIVE ELEMENTS (11B-505.8)
- 3. SEE GRAB BAR NON-CIRCULAR CROSS SECTIONS

GRAB BAR DETAIL AT WALL

MAX.

SCALE: 3" = 1'-0"

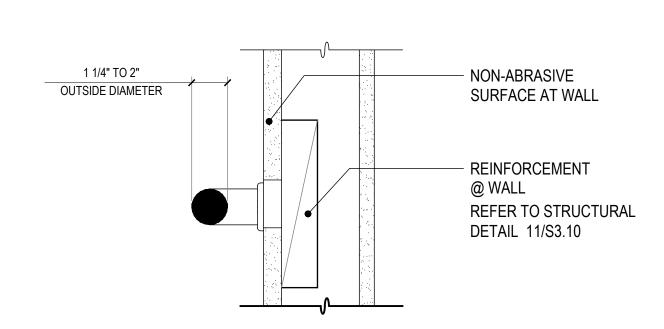

- SANITARY NAPKIN

DISPOSAL UNIT

TOILET PAPER

STAFF RESTROOM

CBC 2019 - FIGURE 11B-604.5.1 (SIDE WALL GRAB BAR)

CBC 2019 - FIGURE 11B-604.7.1 (DISPENSER OUTLET)

CBC 2019 - FIGURE 11B-604.7.2 (DISPOSAL UNIT)

CBC 2019 - FIGURE 11B-604.5.2 (REAR WALL GRAB BAR)


# 12" MAX. \_ 40" MIN. \_

1. HATCHED AREAS REPRESENT LOCATION FOR FUTURE INSTALLATION OF GRAB BARS


4. DOCUMENT FULL BLOCKING INSTALLATION AT ROUGH CARPENTRY FOR FINAL INSPECTION

2. REFER TO GRAB BAR MOUNTING DETAIL FOR PHYSICAL REQUIREMENTS


3. COORDINATE BLOCKING WITH ALL IMPACTED TRADES

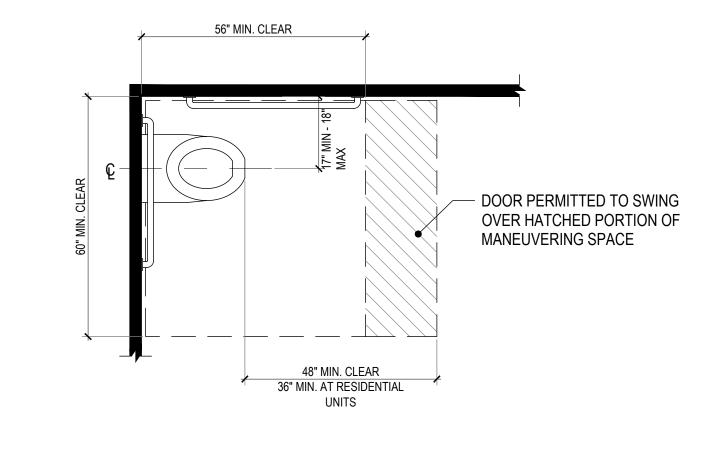





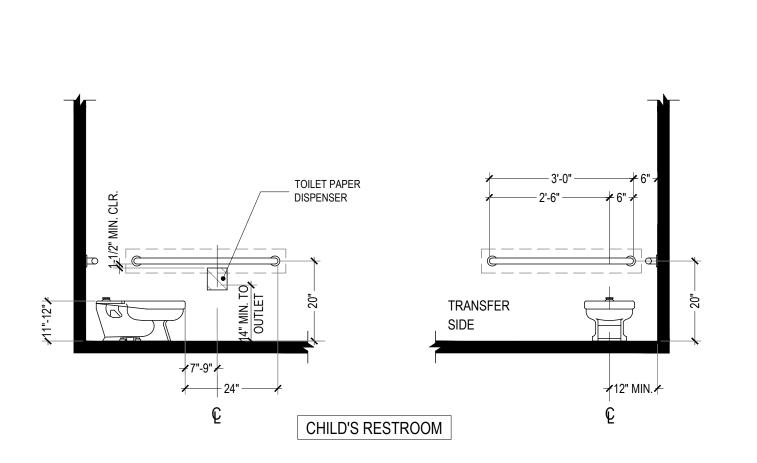




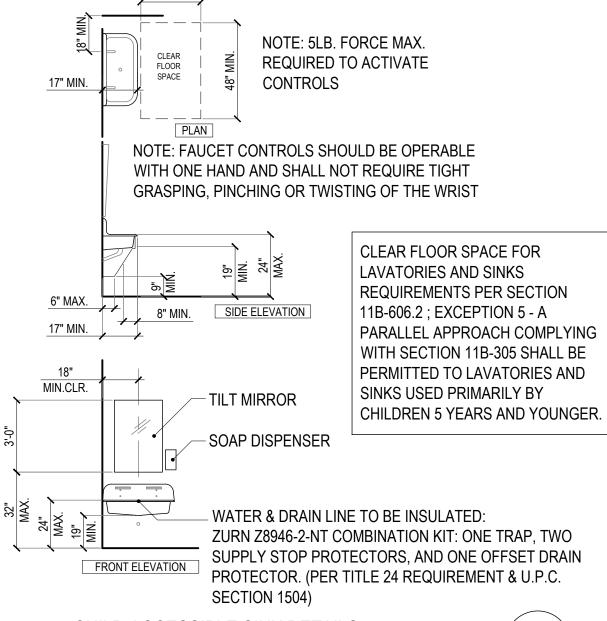

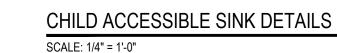

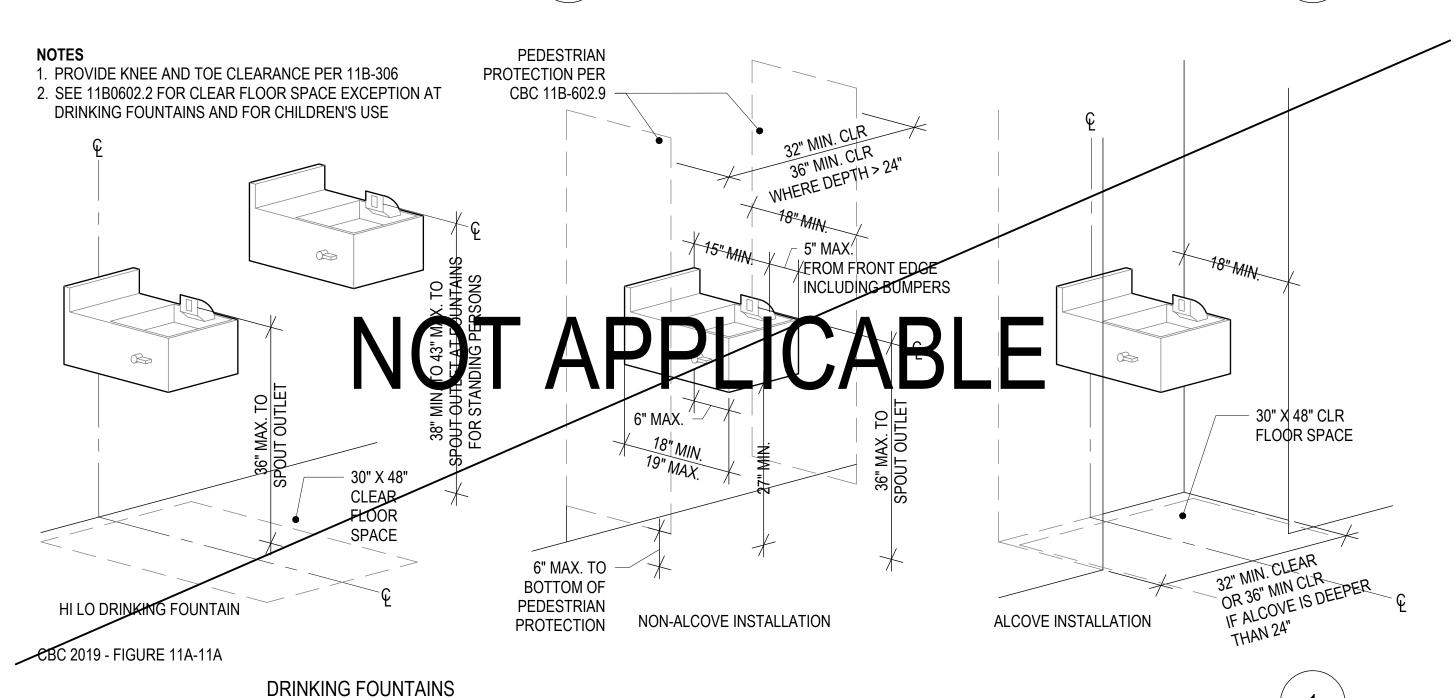

BASED ON CBC 2019 - FIGURE 11B-604.2(a)

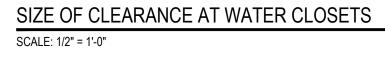

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CONSULTANTS:

Los Angeles, CA 90017

Partnership


T: 213.622.5237

ARCHITECT:

communities

**CHILDHOOD CENTER** 

architecture

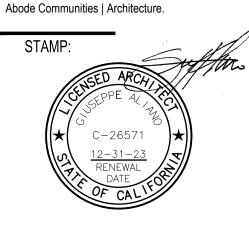

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DSA PROGRESS SET	03.02.22	
DSA APPLICATION SET	04.01.22	
DSA BACK-CHECK SET	10.05.22	
DSA BACK-CHECK SET	10.24.22	
DSA BACK-CHECK SET	11.01.22	

SHEET NAME: ACCESSIBILITY -PLUMBING ELEMENTS & FACILITIES

SHEET NUMBER: G3.04

GRAB BAR REINFORCEMENT FOR ADULT ADAPTABLE WATER CLOSETS

CBC 2019 - TABLE 11B-604.9



SCALE: 3/4" = 1'-0"

TOILET COMPARTMENT MOUNTING HEIGHTS SCALE: 1/2" = 1'-0"

——— 24" MIN. ———

**TRANSFER** 

SIDE

12" MIN

1'-6"

TABLE 11B-604.9 SUGGESTED DIMENSIONS FOR CHILDREN'S USE

SUGGESTED DIMENSIONS FOR WATER CLOSETS SERVING CHILDREN AGES 3 THROUGH 12			
	Ages 3 and 4	Ages 5 through 8	Ages 9 through 12
Water Closet Centerline	12 inches	12 to 15 inches	15 to 18 inches
	(305 mm)	(305 to 381 mm)	(381 to 457 mm)
Toilet Seat Height	11 to 12 inches	12 to 15 inches	15 to 17 inches
	(279 to 305 mm)	(305 to 381 mm)	(381 to 432 mm)
Grab Bar Height	18 to 20 inches	20 to 25 inches	25 to 27 inches
	(457 to 508 mm)	(508 to 635 mm)	(635 to 686 mm)
Dispenser Height	14 inches	14 to 17 inches	17 to 19 inches
	(356 mm)	(356 to 432 mm)	(432 to 483 mm)

SUGGESTED DIMENSIONS FOR CHILDREN'S USE NOT TO SCALE




(1) INTERNATIONAL SYMBOL OF ACCESSIBILITY



(2) INTERNATIONAL SYMBOL OF TTY



(3) VOLUME CONTROL TELEPHONE

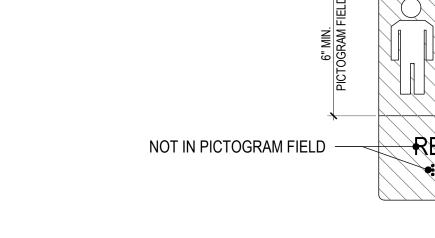


**NOTES** 

(4) INTERNATIONAL SYMBOL OF **ACCESS FOR HEARING LOSS** 


#### CBC 2019 - FIGURE 11B-703.7.2.1-4

#### SYMBOLS OF ACCESSIBILITY SCALE: N.T.S.

DETECTABLE WARNING SURFACES TO BE YELLOW AND APPROXIMATE FS 33538 OF FEDERAL STANDARD 595C PER 11B-705.1.1.3.1 AND PROVIDE 70% MINIMUM VISUAL CONTRAST WITH ADJACENT WALKING SURFACES PER 11B-705.1.1.3.2

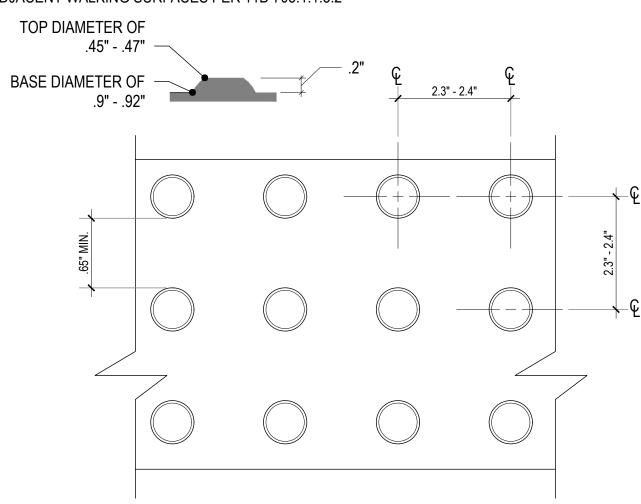

CBC 2019 - FIGURE 11B-705.1

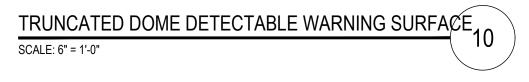

ON THE PULL SIDE OF DOOR PROVIDE

OF ANY DOOR SWING BETWEEN THE

18" X 18" CLEAR SPACE OUTSIDE OF ARC

CLOSED POSITION AND 45 DEGREES OPEN

ON THE PULL SIDE OF DOORS WITH TWO

ACTIVE LEAFS, PROVIDE 18" X 18" CLEAR

SPACE ON THE RIGHT SIDE OF THE RIGHT


SWING BETWEEN THE CLOSED POSITION

LEAF OUTSIDE THE ARC OF ANY DOOR

AND 45 DEGREES OPEN

DOORS AND GATES IN SEIRES

SCALE: 3/8" = 1'-0"

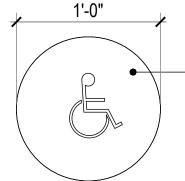

1/4" THICK ACRYLIC, **COLOR TO CONTRAST** DOOR COLOR AND BE SELECTED BY ARCHITECT, TYP.

AT WOMEN'S RESTROOM




1/8" MIN, 1/4" MAX. RADIUS



SCALE: N.T.S.


1/4" THICK ACRYLIC, TRIANGLE SUPERIMPOSED ON 1/4" THICK ACRYLIC CIRCLE. TRIANGLE SHALL CONTRAST WITH CIRCLE, CIRCLE TO CONTRAST DOOR COLOR. ALL COLORS

TO BE SELECTED BY ARCHITECT, TYP.

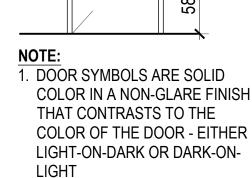

2. MOUNT SIGNS WITHIN 1" OF DOOR SIDE-TO-SIDE ON DOOR, CENTER @ 4'-10" TO 5'-0" A.F.F. 3. EDGES OF ALL SIGNS SHALL BE EASED OR ROUNDED 1/16" MIN OR CHAMFERED AT 1/8" MAX.

#### RESTROOM DOOR SYMBOL

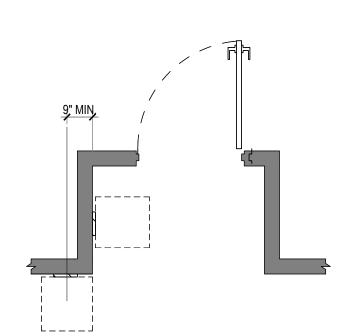


ON THE PUSH SIDE OF DOOR, THE 18" X 18" CLEAR SPACE MAY OVERLAP THE DOOR

WHERE WALL SPACE IS NOT PROVIDED NEXT TO THE LATCH SIDE OF DOOR, PROVIDE 18" X 18" CLEAR SPACE ON NEAREST WALL

WHILE THIS LOCATION IS TECHNICALLY COMPLIANT, THE BEST PRACTICE WOULD BE TO LOCATE THE SIGN IN THE CORRIDOR SO THAT IT CAN BE SEEN/ DETECTED AS ONE TRAVELS DOWN THE CORRIDOR IN EITHER DIRECTION

1. CHARACTERS AND BACKGROUND OF THE SIGN ARE EGGSHELL, MATTE, OR OTHER NON-GLARE FINISH. COLOR AND CONTRAST SHALL BE DIFFERENT FROM COLOR AND CONTRAST OF WALL, TYP, EITHER DARK ON LIGHT OR LIGHT ON DARK.

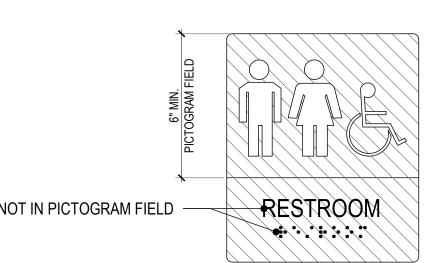

BASED ON CBC 2019 - FIGURE 11B-703.6.1


**PICTOGRAMS** SCALE: 3" = 1'-0"

- 1. FINISH AND CONTRAST: NON-GLARE FINISH, AND CONTRAST WITH BACKGROUND WITH EITHER LIGHT CHARACTERS ON DARK BACKGROUND OR VICE VERSA
- 2. CASE: UPPERCASE OR LOWERCASE OR COMBINATION OF BOTH 3. **STYLE**: CONVENTIONAL IN FORM. NOT ITALIC, OBLIQUE, SCRIPT, HIGHLY DECORATIVE, OR OTHER UNUSUAL FORMS
- 4. CHARACTER PROPORTIONS: WIDTH OF UPPERCASE "O" IS 60% MIN. AND 110% MAX. OF THE HEIGHT OF THE UPPERCASE LETTER "I"
- 5. CHARACTER HEIGHT: COMPLY WITH TABLE 11B-703.5.5. BASED ON UPPERCASE LETTER "I" AND VARIES ACCORDING TO HEIGHT AFF AND THE HORIZONTAL VIEWING DISTANCE. THE
- MIN. HEIGHT IS 5/8" FOR HORIZONTAL VIEWING DISTANCE LESS THAN 72" 6. HEIGHT FROM FINISH FLOOR OR GROUND: 40" MIN. AFF FROM BASELINE OF CHARACTER 7. STROKE THICKNESS: 10% MIN. TO 20% MAX. OF THE HEIGHT OF THE UPPERCASE LETTER " 8. CHARACTER SPACING: 10% MIN. TO 35% MAX. OF THE HEIGHT OF THE UPPERCASE LETTER
- "I", EXCLUDING WORD SPACES 9. LINE SPACING: BETWEEN BASELINES OF SEPARATE LINES, 135% MIN. AND 170% MAX. OF
- THE RAISED CHARACTER HEIGHT 10. **FORMAT**: HORIZONTAL


#### APPLIES TO THE FOLLOWING SIGNAGE TYPES:

- 1. DIRECTIONAL
- 2. INFORMATIONAL
- 3. IN AREAS OF REFUGE
- 4. ENTRANCES 5. ASSISTIVE LISTENING DEVICES

#### NON-TACTILE VISUAL CHARACTER SIGNAGE NOTES SCALE: N.T.S.

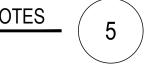

- 1. LOCATE SIGNS FOR PERMANENT ROOMS AT THE ENTRANCE TO, AND OUTSIDE OF THE ROOM OR SPACE.
- 2. LOCATE EXIT SIGNS AT THE EXIT DOOR WHEN APPROACHED IN THE DIRECTION OF TRAVEL. 3. AT DOUBLE DOORS WITH ONE ACTIVE LEAF, LOCATE ON INACTIVE LEAF; WITH TWO ACTIVE LEAVES, LOCATE TO THE RIGHT OF THE RIGHT HAND DOOR.

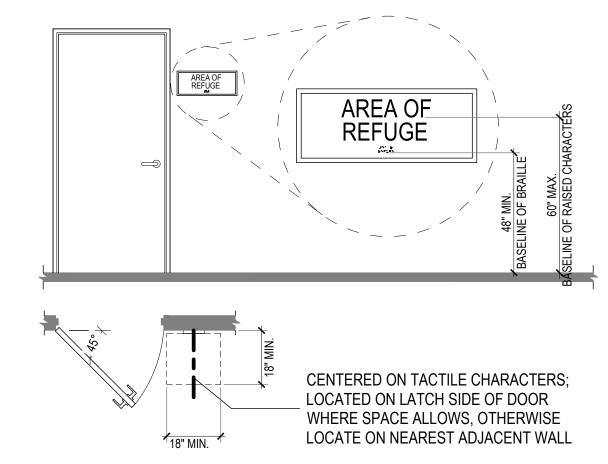


CBC 2019 - FIGURE 11B-703.4.1 (HEIGHT) CBC 2019 - FIGURE 11B-703.4.2 (LOCATION)

SCALE: N.T.S.

#### HEIGHT AND LOCATION OF TACTILE SIGNS

- 1. PROVIDE CONTRACTED (GRADE 2) BRAILLE WITH SPACING OF DOTS IN AND WITHIN ADJACENT CELLS PER CALIFORNIA BRAILLE STANDARDS
- 2. BRAILLE DIMENSIONS PROVIDED IN CBC 2019 TABLE 11B-703.3.1

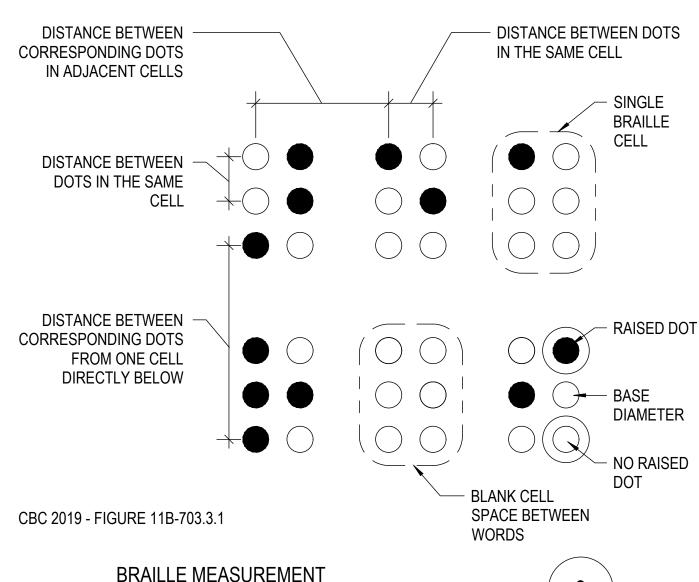


#### **NOTES**

- 1. POSITION BELOW THE ENTIRE CORRESPONDING TEXT (SINGLE OR MULTILINE) IN A
- HORIZONTAL FORMAT, FLUSH LEFT OR CENTERED. 2. APPLIES TO THE FOLLOWING SIGNAGE TYPES

SCALE: N.T.S.


- A. PERMANENT ROOMS AND SPACES
- B. EXIT DOORS
- C. DOORS TO AREAS OF REFUGE
- D. DELAYED EGRESS LOCKS E. ASSISTIVE LISTENING SYSTEMS AVAILABILITY

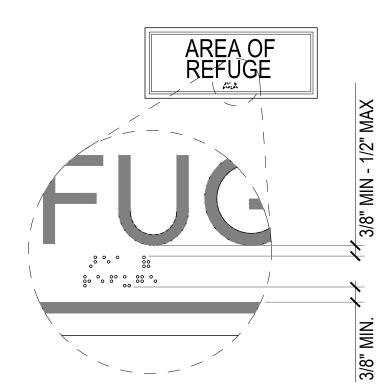

CBC 2019 - FIGURE 11B-703.3.2

### POSITION OF BRAILLE SCALE: N.T.S.

- 1. **DEPTH**: 1/32" MIN. ABOVE BACKGROUND
- 2. CASE: UPPERCASE
- 3. STYLE: SAN SERIF. NOT ITALIC, OBLIQUE, SCRIPT, HIGHLY DECORATIVE, OR OTHER UNUSUAL
- 4. THICKNESS: 15% MAX. OF THE HEIGHT OF UPPERCASE LETTER "I" 5. LINE SPACING: BETWEEN BASELINES OF SEPARATE LINES < 135% MIN. AND 170% MAX. OF THE
- RAISED CHARACTER HEIGHT
- 6. **FORMAT**: HORIZONTAL 7. APPLIES TO THE FOLLOWING SIGNAGE TYPES
- A. PERMANENT ROOMS AND SPACES
- B. EXIT DOORS C. DOOR TO AREAS OF REFUGE
- D. DELAYED EGRESS LOCKS E. ASSISTIVE LISTENING SYSTEMS AVAILABILITY

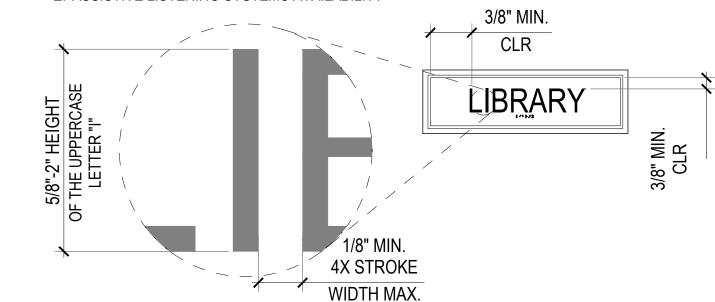

BASED ON CBC 2019 - FIGURE 11B-703.2.5

#### RAISED CHARACTERS SCALE: N.T.S.

**IDENTIFICATION STAMP** DIV. OF THE STATE ARCHITEC APP: 03-122151 INC: REVIEWED FOR SS 🗹 FLS 🗹 ACS 🗹 DATE: 11/02/2022

### abode communities architecture

PROJECT:

#### **LAEP EARLY CHILDHOOD CENTER**

13928 KORNBLUM AVE. HAWTHORNE, CA 90250

CLIENT:

Los Angeles Education **Partnership** 1541 Wilshire Blvd., Suite 200

Los Angeles, CA 90017 T: 213.622.5237 ARCHITECT: **Abode Communities** 

1149 S. Hill Street, Suite 700

Los Angeles, CA 90015

T: 213.629.2702 **CONSULTANTS: Breen Engineering** 


1983 W. 190th St., Suite 200 Torrance, CA 90504 T: 310.464.8404

MECHANICAL/ **ELECTRICAL/ PLUMBING** Breen Engineering 1983 W. 190th St., Suite 200 Torrance, CA 90504 T: 310.464.8404

STRUCTURAL **Breen Engineering** 1983 W. 190th St., Suite 200 Torrance, CA 90504 T: 310.464.8404

### DSA APPLICATION NUMBER: 03-122151

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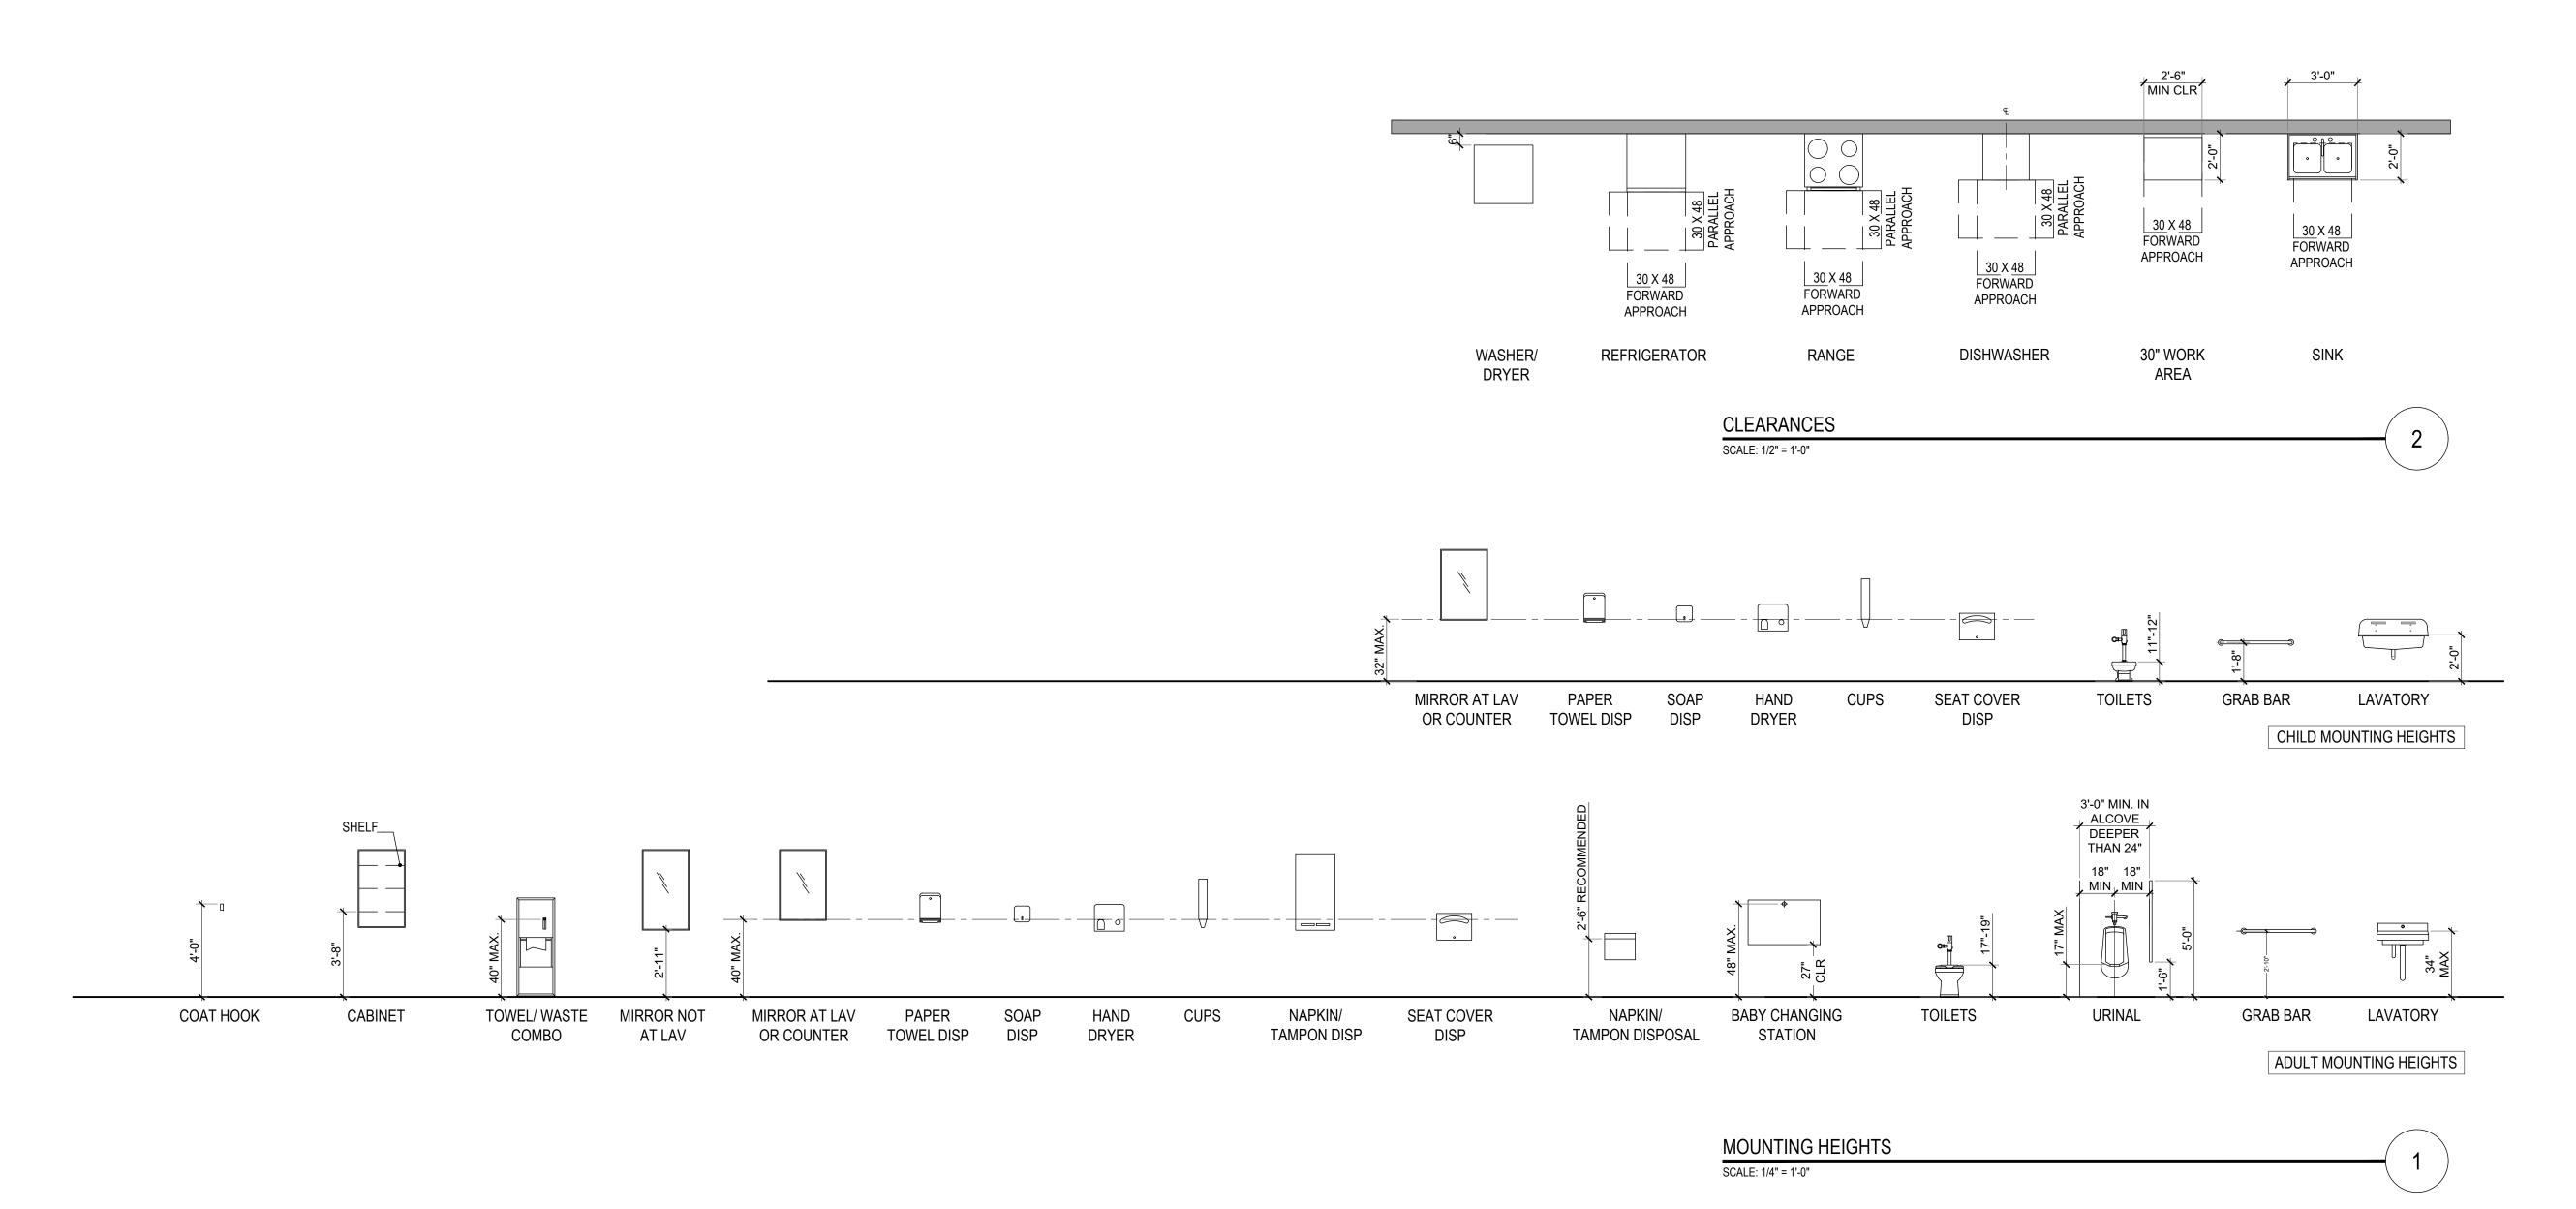


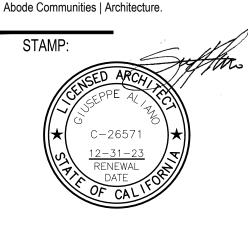DATE REV 02.01.22 PROGRESS SET DSA PROGRESS SET 03.02.22 DSA APPLICATION SET 04.01.22 DSA BACK-CHECK SET 10.05.22 DSA BACK-CHECK SET 10.24.22 DSA BACK-CHECK SET 11.01.22

SHEET NAME: ACCESSIBILITY -COMMUNICATION **ELEMENTS & FEATURES** 

SHEET NUMBER:

G3.05



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ARCHITECT:

Abode Communities 1149 S. Hill Street, Suite 700 Los Angeles, CA 90015 T: 213.629.2702

CONSULTANTS:

CIVIL


Breen Engineering
1983 W. 190th St., Suite 200 Torrance, CA 90504 T: 310.464.8404 MECHANICAL/

ELECTRICAL/ PLUMBING Breen Engineering 1983 W. 190th St., Suite 200 Torrance, CA 90504 T: 310.464.8404

<u>STRUCTURAL</u> Breen Engineering 1983 W. 190th St., Suite 200 Torrance, CA 90504 T: 310.464.8404

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DSA APPLICATION SET	04.01.22	
DSA BACK-CHECK SET	10.05.22	
DSA BACK-CHECK SET	10.24.22	
DSA BACK-CHECK SET	11.01.22	
·	-	

SHEET NAME:

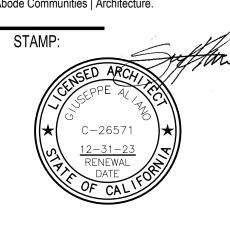
ACCESSIBILITY -MOUNTING HEIGHTS & ACCESSORIES


SHEET NUMBER:

G3.06

# TOPOGRAPHIC SURVEY

13928 KORNBLUM AVE., HAWTHORNE, CA 90250

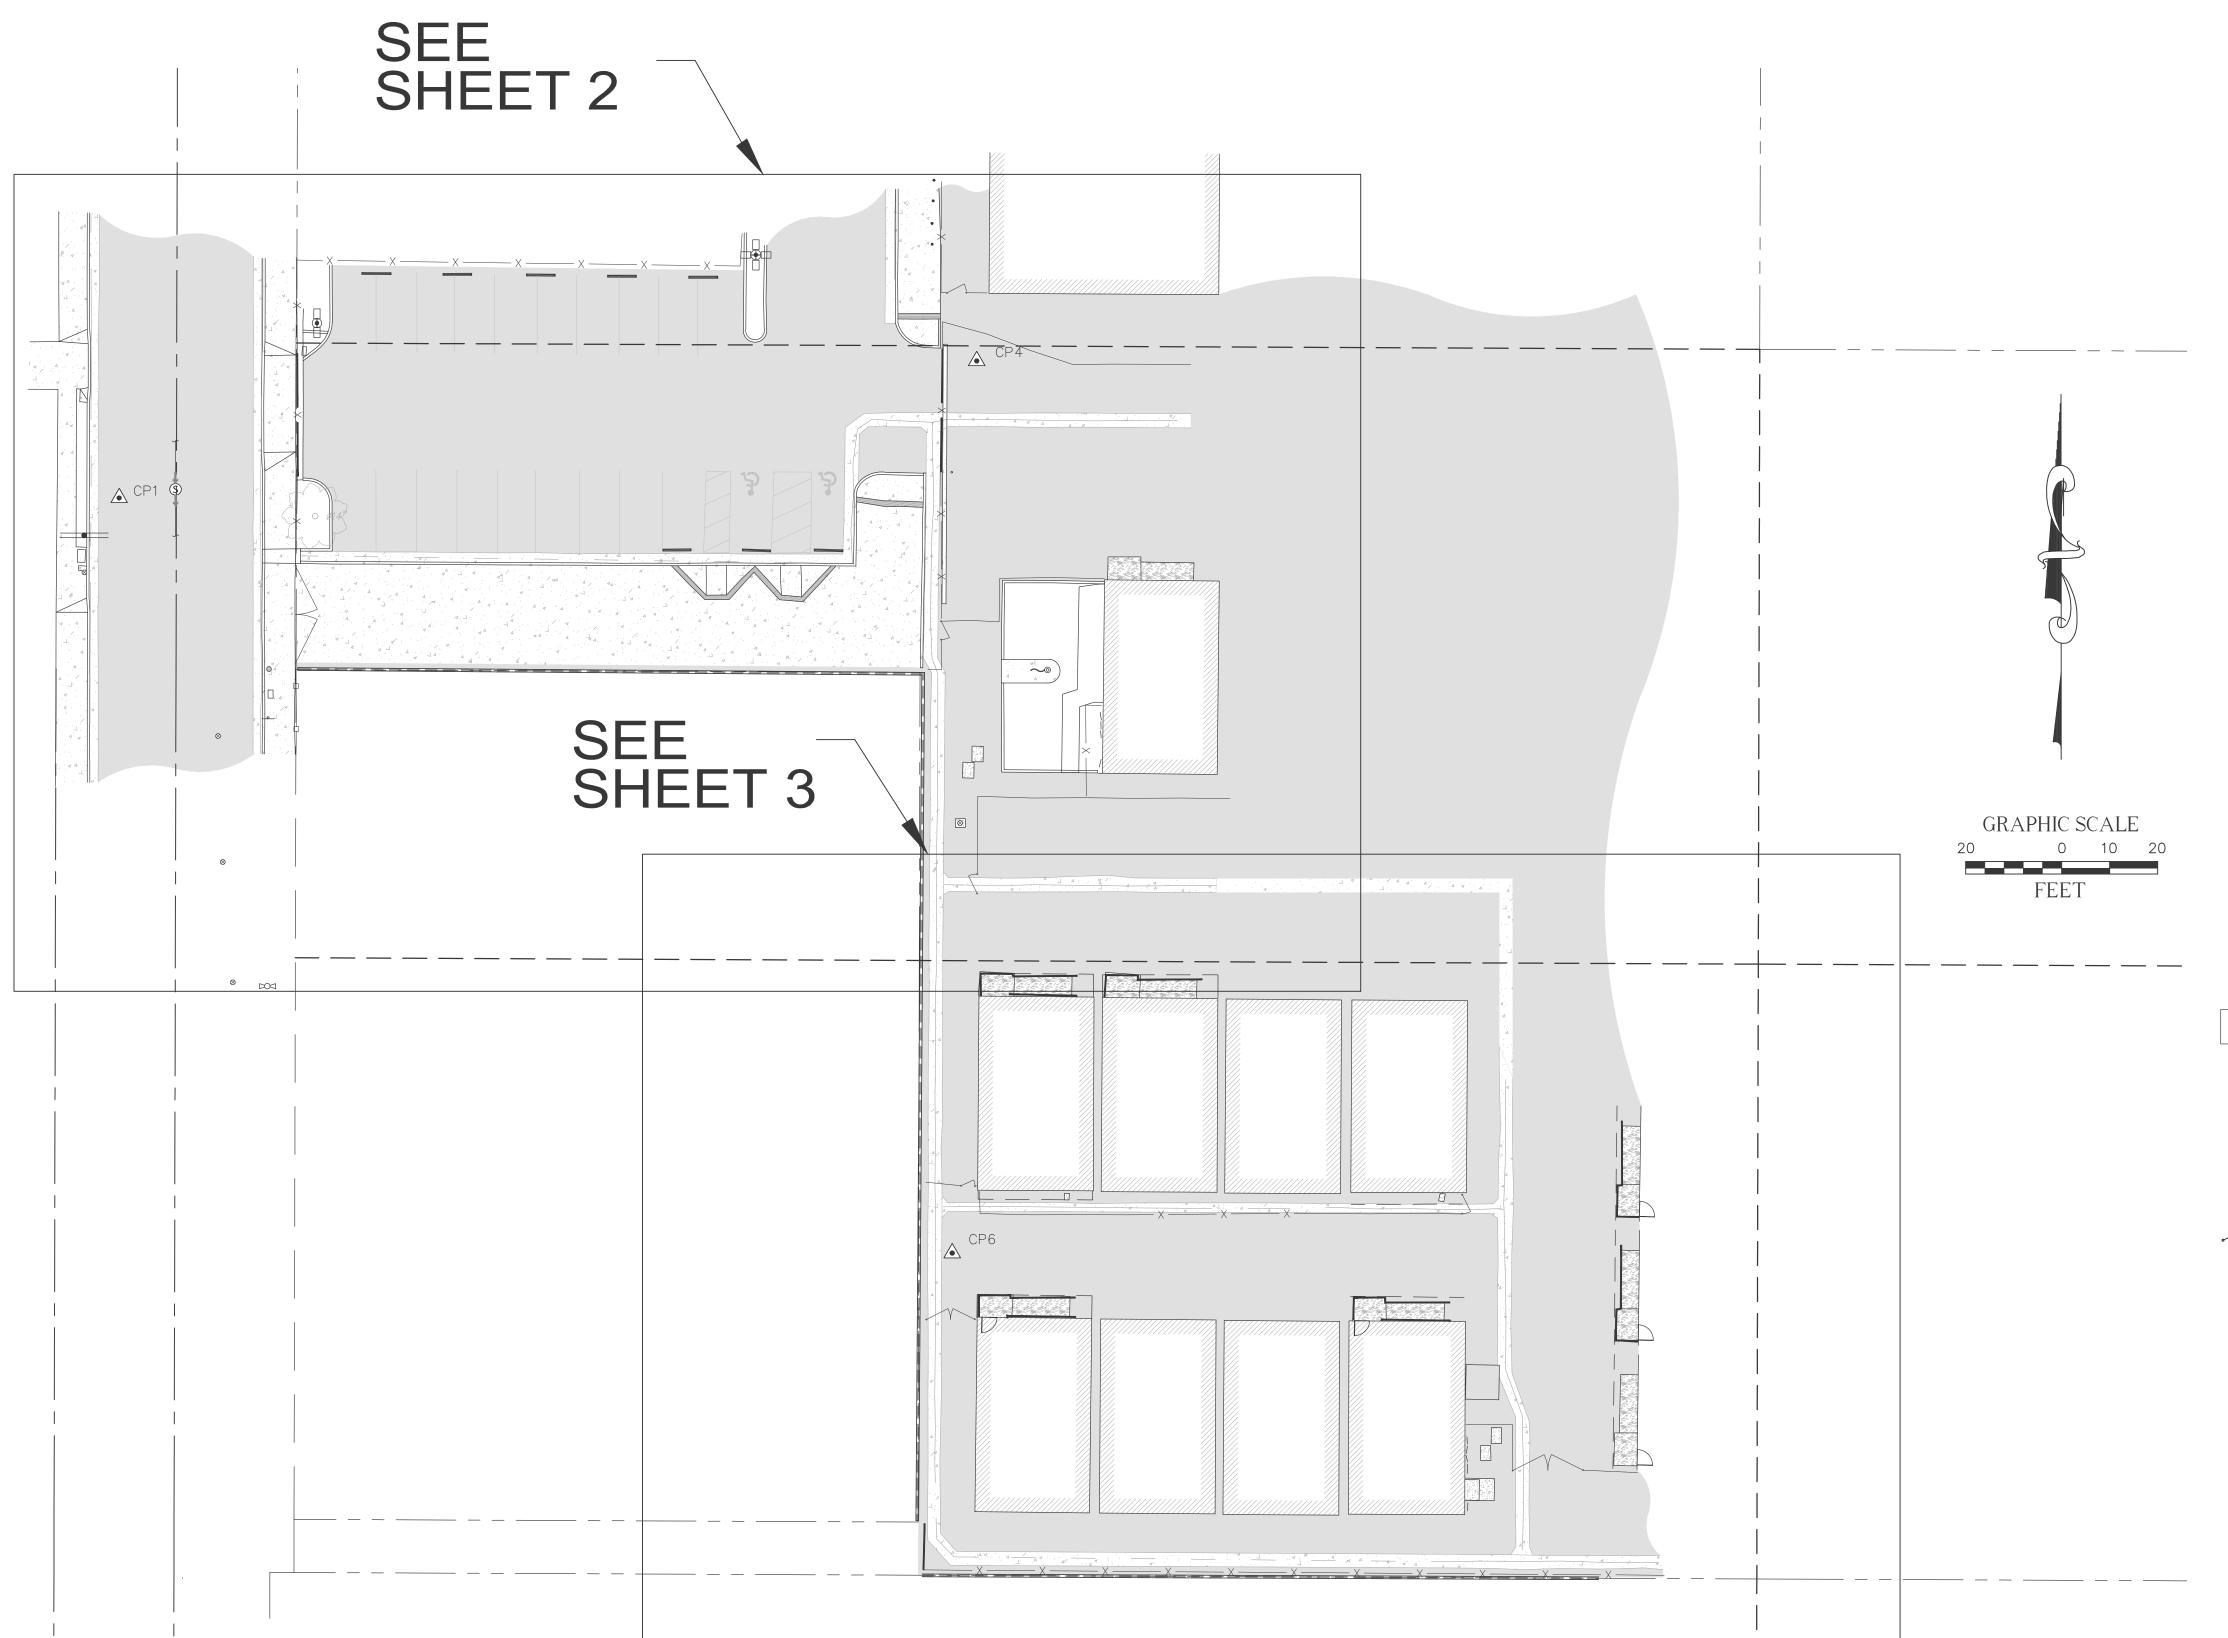

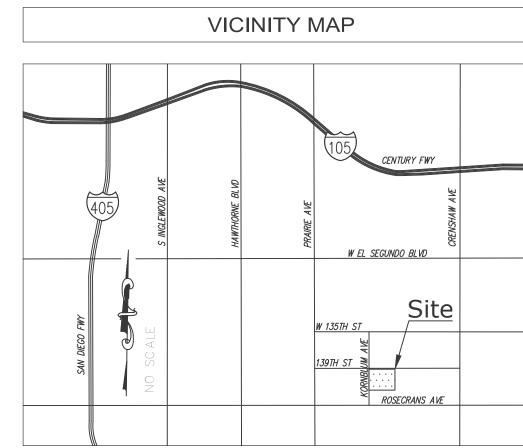

#### LEGAL DESCRIPTION

NOTE: THIS SURVEY WAS PREPARED WITHOUT THE BENEFIT OF A TITLE REPORT. LOT 258 OF TRACT MAP NO. 874, IN THE CITY OF HAWTHORNE, COUNTY OF LOS ANGELES, STATE OF CALIFORNIA, FILED IN BOOK 120, PAGES 43, IN THE OFFICE OF THE COUNTY RECORDER OF SAID COUNTY.

	MONUMENT NOTES
MON.#	DESCRIPTION
M10024	FD. NAIL WITH TAG "RCE-1670", PER TRACT MAP NO.874, R-S 120/43

		CONT	ROL POI	NTS
CP#	NORTHING	EASTING	ELEVATION	DESCRIPTION
CP1	1787872.75	6459291.35	53.71'	SET MAGNETIC NAIL & SHINNER
CP4	1787901.28	6459470.00'	54.32'	SET MAGNETIC NAIL & SHINNER
CP6	1787715.41'	6459464.90'	55.18'	SET MAGNETIC NAIL & SHINNER

	LE	EGEND		
	ASPHALT PAVEMENT		EP	ELECTRIC PANEL
	CAR STOP		EV	ELECTRIC VAULT
	CONCRETE PAVEMENT		FS	FINISH SURFACE
	CONTROL POINT		FL	FLOW LINE
$\Box$	DOOR		HCR	HANDICAP RAMP
DOJ	FIRE HYDRANT		/NV	INVERT
$\odot$	FLAG POST		NG	NATURAL GROUND
$\rightarrow$	FLOW DIRECTION		P	PROPERTY LINE
	FOUND MONUMENT AS NOTED		R/W	RIGHT OF WAY
$\sim$	GATE		TV	TELCO VAULT
•	GUARD POST		TC	TOP OF CURB
Ĕ.	HANDICAP		WM	WATER METER
	LIGHT STANDARD			BLOCK WALL
•	POWER POLE			CENTERLINE
S	SEWER MANHOLE	xxx	x	CHAIN LINK FENCE
-0	SIGN			EDGE OF PAVEMENT
	TREE (TYPICAL)			FLOW LINE
0	UTILITY POLE		— —	OVERHANG
$\otimes$	WATER VALVE			PROPERTY LINE
$\mathcal{Q}$	CENTERLINE			RIGHT-OF-WAY
Ø	DIAMETER OF EXISTING TREE	SS _		SANITARY SEWER LINE
EC	ELECTRIC CABINET			WOOD FENCE

#### BASIS OF BEARINGS

THE BEARINGS SHOWN HEREON ARE BASED UPON THE CALIFORNIA COORDINATE SYSTEM OF 1983, CCS83, ZONE 5, (2022.25) IN ACCORDANCE TO THE CALIFORNIA PUBLIC RESOURCES CODE SECTIONS 8801-8819; SAID BEARINGS ARE DETERMINED LOCALLY UPON FIELD-OBSERVED TIES TO THE FOLLOWING LEICA SMARTNET NORTH AMERICA (S.N.N.A.) CONTINUOUSLY OPERATING REFERENCE STATIONS (C.O.R.S.):

S.N.N.A. CASM: NORTHING = 1829162.57' EASTING = 6418730.63' S.N.N.A. CAPE: NORTHING = 1730270.48' EASTING = 6476524.11'


RE\	/ISIONS			UTILITY STATEMENT
NO.	DATE	REVISIONS	BY	BURIED UTILITIES AND/OR PIPELINES SHOWN HEREON ARE PER VISIBLE AND APPARENT SURFACE EVIDENCE, RECORD
0	09/19/22	SUBMITTAL	SR	DRAWINGS OF THE CONSTRUCTED UTILITY LINES OBTAINED FROM RELIABLE AND RESPONSIBLE SOURCES NOT
				CONNECTED WITH CALVADA SURVEYING, INC. OR MARKINGS PROVIDED BY AN INDEPENDENT LOCATING CONTRACTOR. NO GUARANTEE OR WARRANTY, EITHER EXPRESSED OR IMPLIED,
				IS MADE AS TO THE ACCURACY OR THOROUGHNESS OF SUCH INFORMATION. IF MORE ACCURATE LOCATIONS OF
				UNDERGROUND UTILITIES OR PIPE LINES ARE REQUIRED, THE UTILITY OR PIPELINE WILL HAVE TO BE VERIFIED BY FIELD
				POTHOLING. CALVADA SURVEYING, INC. AND THE SURVEYOR OF RECORD SHALL NOT BE HELD LIABLE FOR THE LOCATION OF OR THE FAILURE TO NOTE THE LOCATION OF
				NON-VISIBLE UTILITIES OR PIPELINES.

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KINGS R. NO PLIED, SUCH OF ), THE FIELD VEYOR	THE FORE TO SEE	Call: TOLL FRE 1-800 227-260
CATION I OF		BEFORE YOU DIG

	BENCHMARK
t	ELEVATIONS SHOWN HEREON ARE BASED UP ANGELES COUNTY BENCHMARK 8Y556A, ELI 53.60 FEET (NAVD 88).
-	DESCRIPTION: RDBM TAG IN W CB 1FT N/O BCR @ N ROSECRANS AVE & KORNBLUM AVE.
)	

PREPARED FOR PON LOS LOS ANGELES LEVATION EDUCATION PARTNERSHIP 1541 WILSHIRE BOULEVARD, SUITE 200 LOS ANGELES, CA 90017 PHONE: (213) 622-5237

SITE INFORMATION PRAIRIE VISTA SOUTH SCHOOL 13928 KORNBLUM AVE., HAWTHORNE, CA 90250 ASSESSOR'S PARCEL NO.: 4051-020-900, 4051-020-901 & 4051-020-902

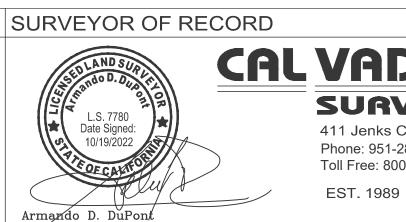

## FIELD COMPLETION DATE: SEP 1, 2022 **CAL VADA** SURVEYING, INC.

411 Jenks Cir., Suite 205, Corona, CA 92878 Phone: 951-280-9960 Fax: 951-280-9746 Toll Free: 800-CALVADA www.calvada.com

JOB NO. 22653

## abode communities architecture

**IDENTIFICATION STAME** DIV. OF THE STATE ARCHITE

REVIEWED FOR SS 🗹 FLS 🗹 ACS 🗹

APP: 03-122151 INC:

PROJECT:

#### LAEP EARLY CHILDHOOD CENTER

13928 KORNBLUM AVE. HAWTHORNE, CA 90250

Los Angeles Education **Partnership** 1541 Wilshire Blvd., Suite 200 Los Angeles, CA 90017 T: 213.622.5237

**Abode Communities** 1149 S. Hill Street, Suite 700 Los Angeles, CA 90015 T: 213.629.2702

CONSULTANTS:

**Breen Engineering** 1983 W. 190th St., Suite 200 Torrance, CA 90504 T: 310.464.8404

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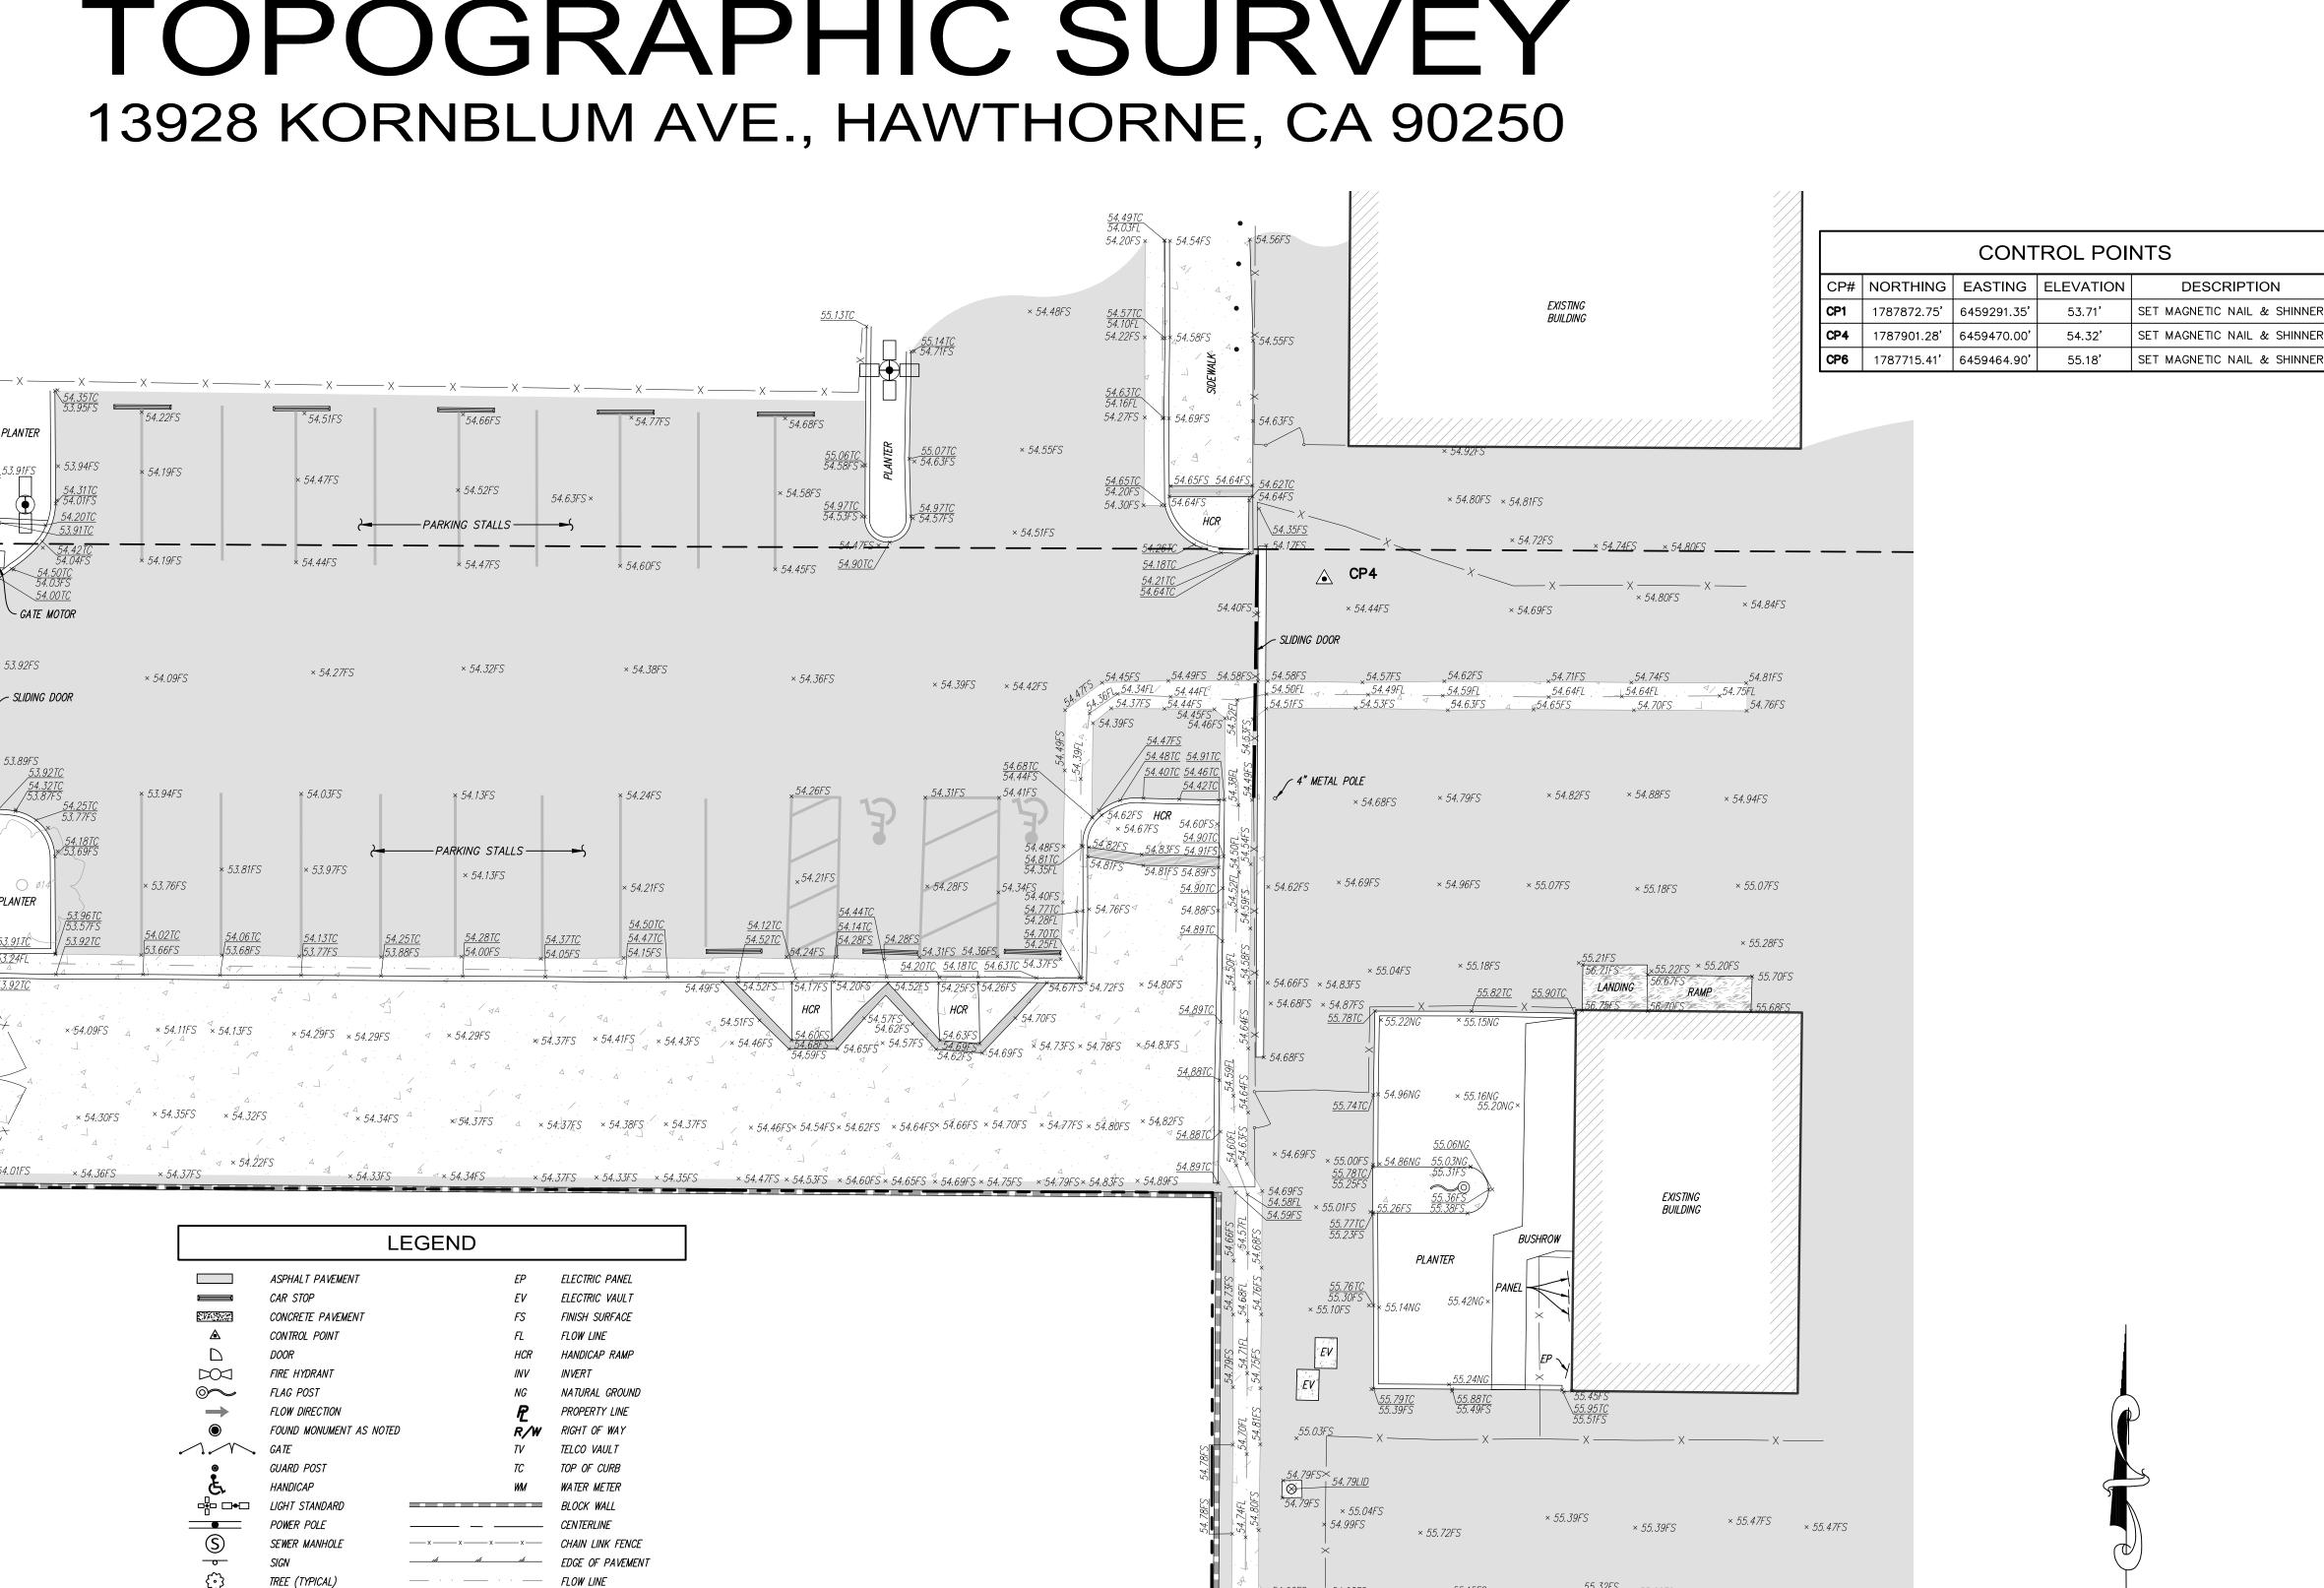
	DATE	REV
PROGRESS SET	02.01.22	
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DSA BACK-CHECK SET	10.24.22	

SHEET NAME:

**TOPOGRAPHIC** SURVEY

SHEET NUMBER:

# TOPOGRAPHIC SURVEY



GRAPHIC SCALE

FEET

FIELD COMPLETION DATE: SEP 1, 2022

RE'	VISIONS			UTILITY STATEMENT
NO.	DATE	REVISIONS	BY	BURIED UTILITIES AND/OR PIPELINES SHOWN HEREON ARE PER VISIBLE AND APPARENT SURFACE EVIDENCE, RECORD
0	09/19/22	SUBMITTAL	SR	DRAWINGS OF THE CONSTRUCTED UTILITY LINES OBTAINED FROM RELIABLE AND RESPONSIBLE SOURCES NOT
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53.24FS>

53.75TC 53.07FL

*53.25FS*×

53.14TC 53.06FL

*53.26FS* ×

*53.21FS* ×

*53.20FS* ×

*53.24FS* ×

*53.29FS* ×

<u>53.72TC</u>

53.72TC 53.06FL

53.67TC 53.08FL

*53.27FS* ×

53.93LID

53.77TC 53.15FL

*53.34FS* ×

<u>53.88LID</u>

53.66LID

53.70TC 53.06FL × 53.23FS

× 53.42FS

53.86TC 53.20FL \* × 53.41FS

\* *53.39FS* 

\* *53.42FS* 

× 53.39FS

54.14FS >



ELECTRIC CABINET


BENCHMARK ELEVATIONS SHOWN HEREON ARE BASED UPON LOS LOS ANGELES ANGELES COUNTY BENCHMARK 8Y556A, ELEVATION EDUCATION PARTNERSHIP 53.60 FEET (NAVD 88). Call: TOLL FREE ROBM TAG IN W CB 1FT N/O BCR @ NW COR ROSECRANS AVE & KORNBLUM AVE.

PREPARED FOR 1541 WILSHIRE BOULEVARD, SUITE 200 LOS ANGELES, CA 90017 PHONE: (213) 622-5237

LOT 258 RECORD OF SURVEY R.S.B. 120/43

A.P.N. 4051-020-900

SITE INFORMATION PRAIRIE VISTA SOUTH SCHOOL 13928 KORNBLUM AVE., HAWTHORNE, CA 90250 SSESSOR'S PARCEL NO.: 4051-020-900, 4051-020-901 & 4051-020-902

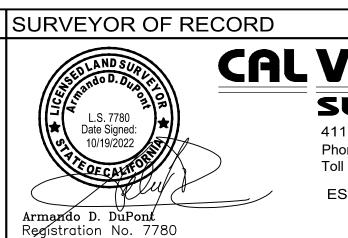

× 55.26FS × 55.22FS

× 54.91FS × 55.06FS

SEE SHEET 3

**CAL VADA** 

SURVEYING, INC. 411 Jenks Cir., Suite 205, Corona, CA 92878 Phone: 951-280-9960

Fax: 951-280-9746 Toll Free: 800-CALVADA www.calvada.com EST. 1989 JOB NO. 22653

APP: 03-122151 INC: REVIEWED FOR SS 🗹 FLS 🗹 ACS 🗹

**IDENTIFICATION STAME** DIV. OF THE STATE ARCHITE

## abode communities architecture

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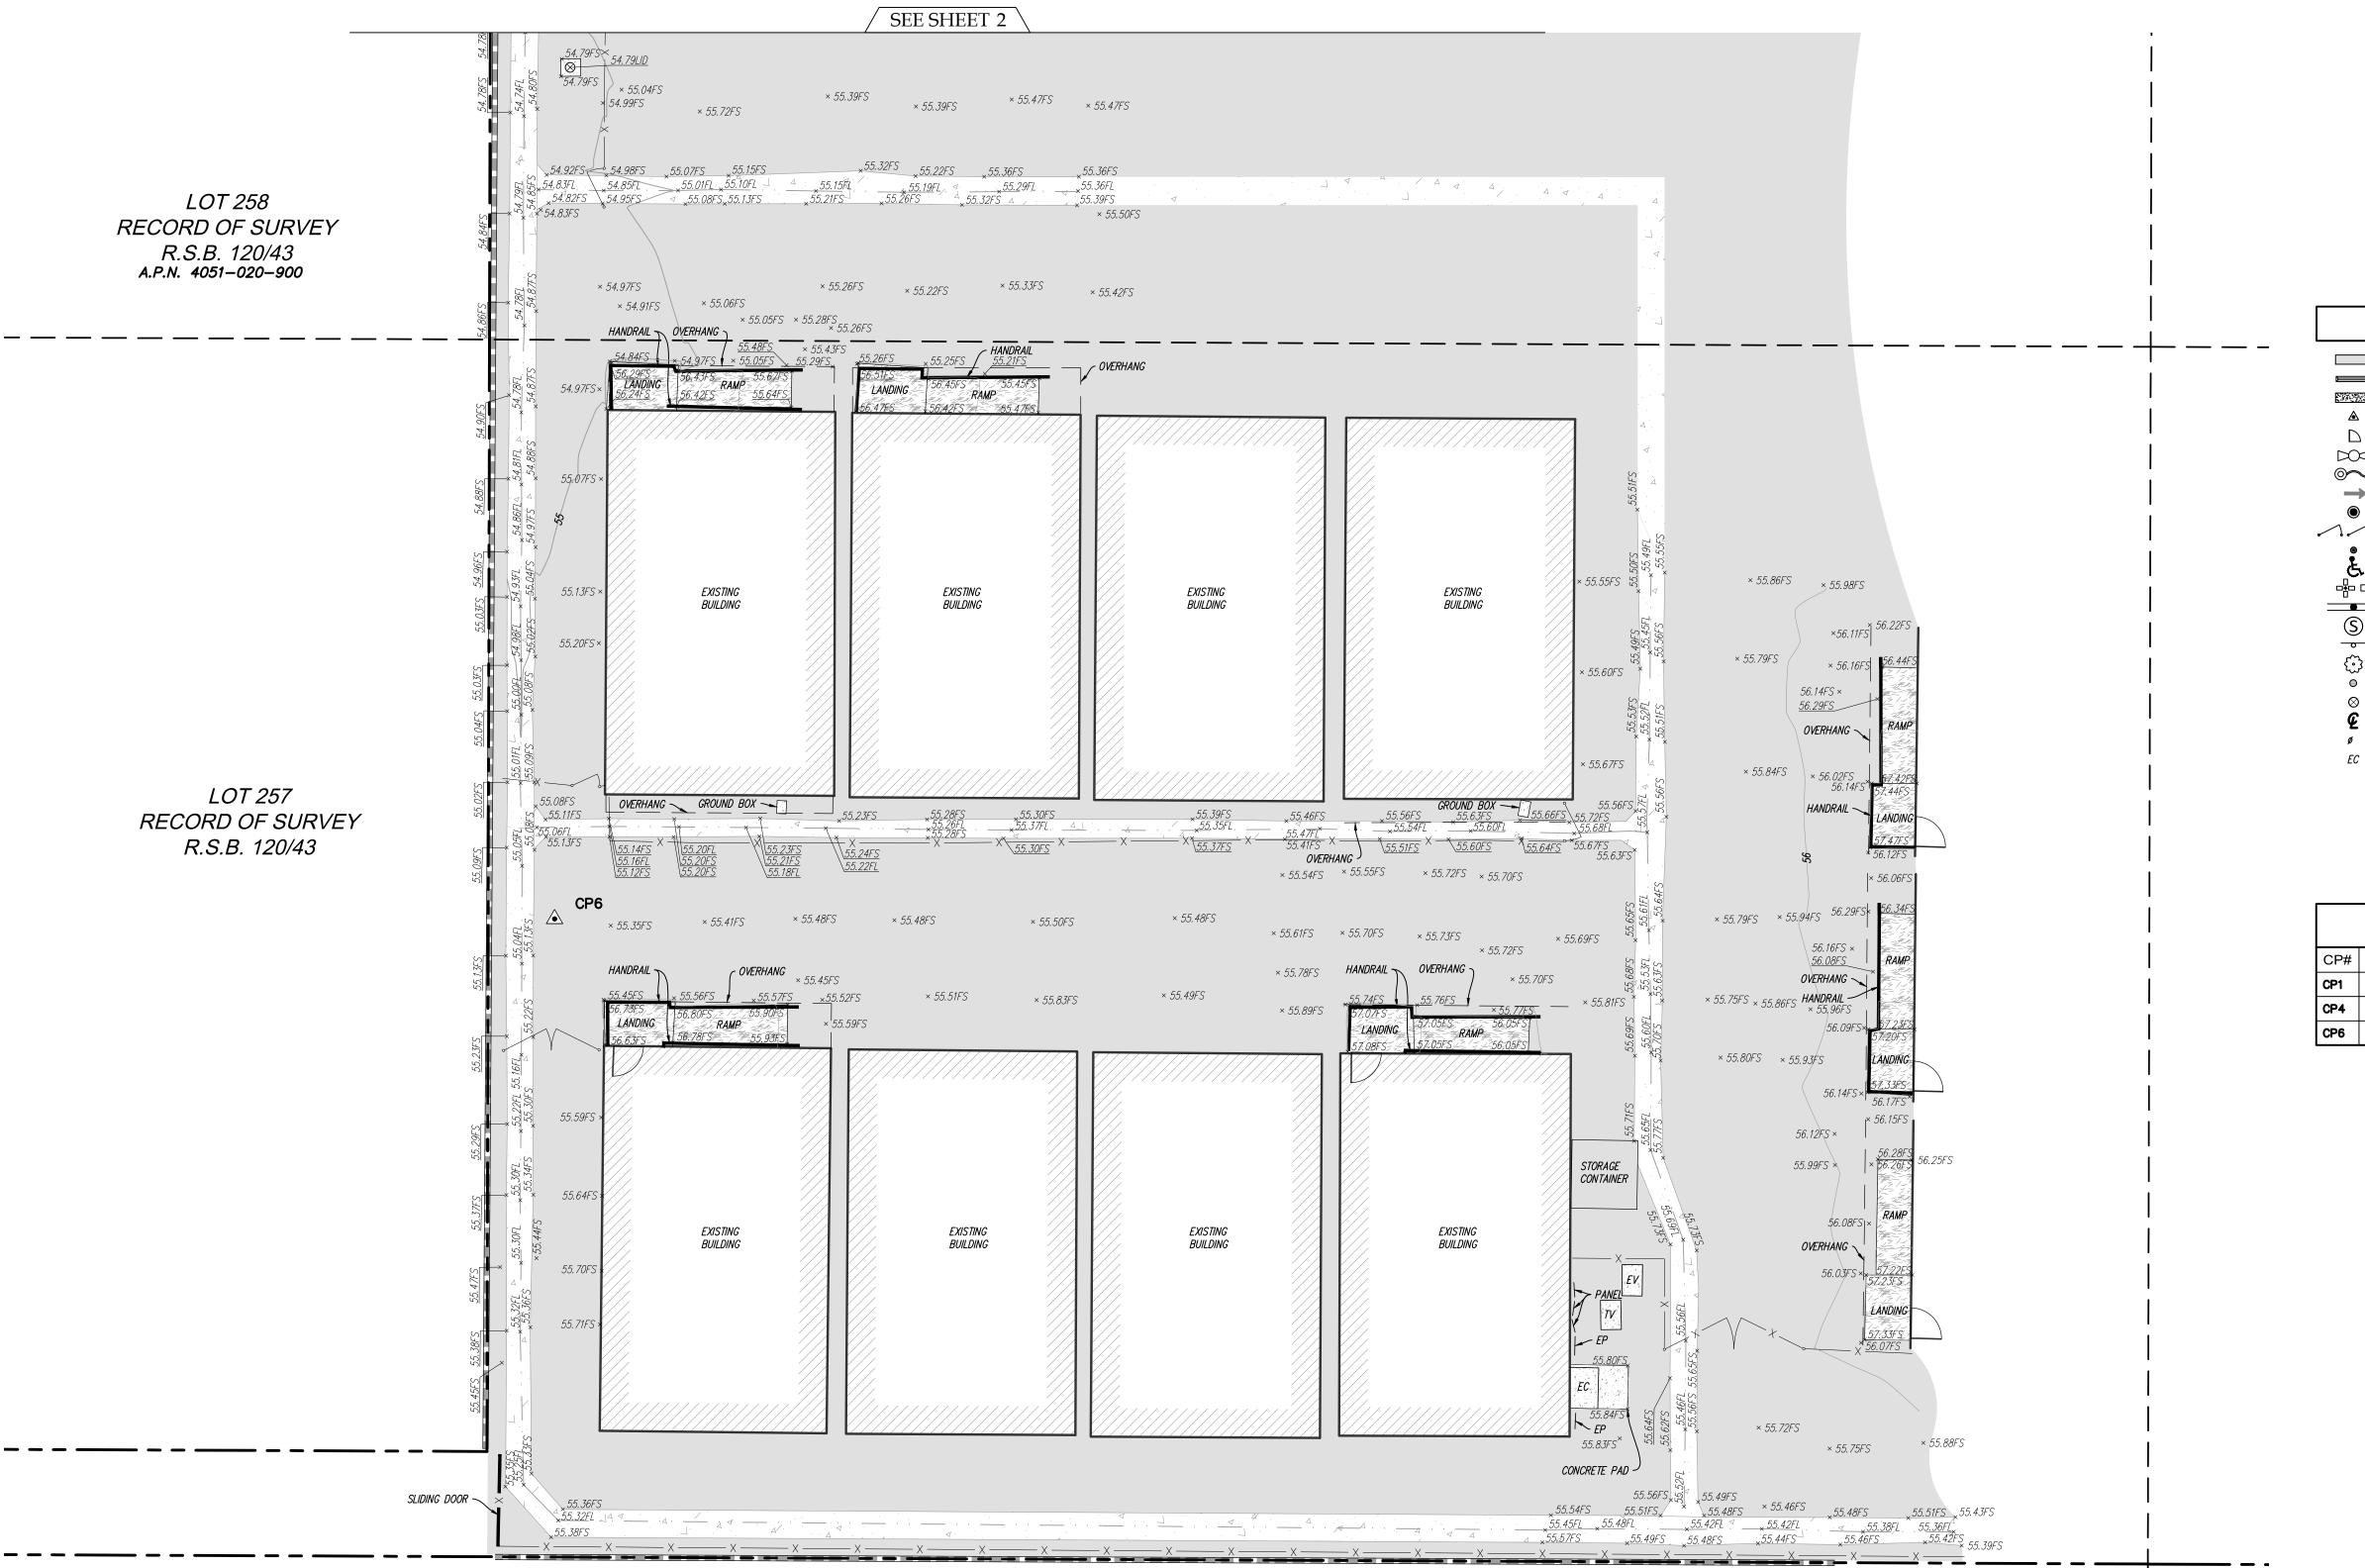
SHEET NAME:

**TOPOGRAPHIC** SURVEY

SHEET NUMBER: 2 OF 3


# TOPOGRAPHIC SURVEY

13928 KORNBLUM AVE., HAWTHORNE, CA 90250



LEGEND							
	ASPHALT PAVEMENT	EP	ELECTRIC PANEL				
	CAR STOP	EV	ELECTRIC VAULT				
	CONCRETE PAVEMENT	FS	FINISH SURFACE				
▲	CONTROL POINT	FL	FLOW LINE				
$\Box$	DOOR	HCR	HANDICAP RAMP				
DOJ	FIRE HYDRANT	/NV	INVERT				
$\odot$	FLAG POST	NG	NATURAL GROUND				
$\rightarrow$	FLOW DIRECTION	P	PROPERTY LINE				
	FOUND MONUMENT AS NOTED	R_/W	RIGHT OF WAY				
\\\\\\\\\\\\\\\\\\\\\\\\\\\\\\\\\\\\\\	GATE	ΤV	TELCO VAULT				
•	GUARD POST	TC	TOP OF CURB				
Ĕ.	HANDICAP	WM	WATER METER				
♣ □•□	LIGHT STANDARD		BLOCK WALL				
	POWER POLE		CENTERLINE				
(S)	SEWER MANHOLE×	xx	CHAIN LINK FENCE				
<del>-</del>	SIGN ———		EDGE OF PAVEMENT				
(C)	TREE (TYPICAL)	· ·	FLOW LINE				
e e	UTILITY POLE — — —		OVERHANG				
$\otimes$	WATER VALVE		PROPERTY LINE				
Œ	CENTERLINE		RIGHT-OF-WAY				
ø	DIAMETER OF EXISTING TREE	- ss	SANITARY SEWER LINE				
EC	ELECTRIC CABINET	-0	WOOD FENCE				

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GRAPHIC SCALE

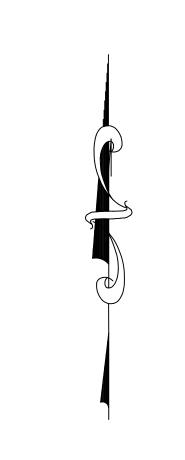FEET

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**CAL VADA** 

Phone: 951-280-9960

EST. 1989

Toll Free: 800-CALVADA

FIELD COMPLETION DATE: SEP 1, 2022

Fax: 951-280-9746

JOB NO. 22653

www.calvada.com

NO. DATE REVISIONS BY BURIED UTILITIES AND/OR PIPELINES SHOWN HEREON ARE PER VISIBLE AND APPARENT SURFACE EVIDENCE, RECORD NOT CONCRETE WITH CALVADA SURFYVIN, II.O. OR MARKINGS CONTROLETO UTILITY LINES OBTAINED FROM RELIABLE AND RESPONSIBLE SOURCES NOT CONCRETE WITH CALVADA SURFYVIN, CONTROLETOR CONTROLETOR WITH CALVADA SURFYVIN, CONTROLET	REVISIONS	UTILITY STATEMENT	BENCHMARK PREPARED FOR	SITE INFORMATION	SURVEYOR OF RECORD
UNDERGROUND UTILITIES OR PIPE LINES ARE REQUIRED BY FIELD POTHOLING. CALVADA SURVEYING, ID. CALVADA SURVEYING, ID. CALVADA SURVEYING, ID. CALVADA SURVEYING, ID. CALVADA SURVEYING DAYS BEFORE YOU DIG  OF OR THE FAILURE TO NOTE THE LOCATION OF  Armardo D. DuPont	NO. DATE REVISIONS B	BURIED UTILITIES AND/OR PIPELINES SHOWN HEREON ARE PER VISIBLE AND APPARENT SURFACE EVIDENCE, RECORD DRAWINGS OF THE CONSTRUCTED UTILITY LINES OBTAINED FROM RELIABLE AND RESPONSIBLE SOURCES NOT CONNECTED WITH CALVADA SURVEYING, INC. OR MARKINGS PROVIDED BY AN INDEPENDENT LOCATING CONTRACTOR. NO GUARANTEE OR WARRANTY, EITHER EXPRESSED OR IMPLIED, IS MADE AS TO THE ACCURACY OR THOROUGHNESS OF SUCH INFORMATION. IF MORE ACCURATE LOCATIONS OF UNDERGROUND UTILITIES OR PIPE LINES ARE REQUIRED, THE UTILITY OR PIPELINE WILL HAVE TO BE VERIFIED BY FIELD POTHOLING. CALVADA SURVEYING, INC. AND THE SURVEYOR OF RECORD SHALL NOT BE HELD LIABLE FOR THE LOCATION	Alert  ELEVATIONS SHOWN HEREON ARE BASED UPON LOS ANGELES ANGELES COUNTY BENCHMARK 8Y556A, ELEVATION 53.60 FEET (NAVD 88).  DESCRIPTION: RDBM TAG IN W CB 1FT N/O BCR ® NW COR ROSECRANS AVE & KORNBLUM AVE.  PHONE: (213) 622-5237	SITE NAME: PRAIRIE VISTA SOUTH SCHOOL  SITE ADDRESS: 13928 KORNBLUM AVE., HAWTHORNE, CA 90250	L.S. 7780 Date Signed: 10/19/2022

IDENTIFICATION STAMP DIV. OF THE STATE ARCHITECT APP: 03-122151 INC:

REVIEWED FOR

SS FLS ACS D

DATE: 11/02/2022

# abode communities architecture

PROJECT:

# LAEP EARLY CHILDHOOD CENTER

13928 KORNBLUM AVE. HAWTHORNE, CA 90250

~LIFNIT∙

Los Angeles Education Partnership 1541 Wilshire Blvd., Suite 200 Los Angeles, CA 90017

ARCHITEC<sup>\*</sup>

T: 213.622.5237

Abode Communities 1149 S. Hill Street, Suite 700 Los Angeles, CA 90015 T: 213.629.2702

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#### DSA APPLICATION NUMBER: 03-122151

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STAMP:

	DATE	REV
PROGRESS SET	02.01.22	
DSA PROGRESS SET	03.02.22	
DSA APPLICATION SET	04.01.22	
DSA BACK-CHECK SET	10.05.22	
DSA BACK-CHECK SET	10.24.22	

SHEET NAME:

TOPOGRAPHIC SURVEY

SHEET NUMBER: 3 OF 3

SHEET 3 OF 3

### **GENERAL NOTES** 1. CONSTRUCT OFF SITE WORK TO COMPLY WITH THE REQUIREMENTS OF THE CITY OF HAWTHORN. SECURE AND PAY FOR REQUIRED CONSTRUCTION PERMITS. 2. CONSTRUCT STRAIGHT GRADES BETWEEN ELEVATIONS SHOWN ON PLAN UNLESS INTERRUPTED BY A GRADE CHANGE LINE. ANY DEVIATION FROM THE GRADING PLAN MUST HAVE PRIOR APPROVAL FROM THE ENGINEER. 3. GRADE LAWN, TURF, PLANTING AND AGRICULTURAL AREA 1 ½" BELOW DESIGN GRADES INDICATED. 4. ADJUST TO DESIGN GRADE TOP OF EXISTING VALVE BOXES WITHIN AREAS TO BE REGRADED. 5. MAINTAIN A RECORD OF LOCATION OF UTILITY MARKERS ON THE AS-BUILT PLAN AND REINSTALL THEM AFTER PAVING. REPLACE BENT OR UNUSABLE MARKERS. FOR ALL UTILITY LINES DISCOVERED WITHIN THE WORK AREA, INSTALL BRASS UTILITY MARKERS INDICATING DIRECTIONS OF LINES AT ALL CHANGES IN DIRECTIONS AFTER PAVING. INFORM THE SURVEYOR TO LOCATE AND RECORD ACTUAL LOCATIONS. 6. UNCLOG, CLEAN AND FLUSH THE WORK AREA DRAINAGE SYSTEM AFTER PAVING AND IMMEDIATELY BEFORE A RAIN FORECAST. 7. ALL EXCAVATIONS, BACKFILLING AND COMPACTION SHALL BE CONTINUOUSLY INSPECTED BY THE GEOTECHNICAL ENGINEER. 8. LIMITS OF SITE - REVIEW ENTIRE SET FOR SCOPES OF WORK BEYOND LIMITS OF SITE, INCLUDING CONSTRUCTION AND PHASING/STAGING. COORDINATE WITH OWNER REPRESENTATIVE FOR SCOPES OF WORK THAT OCCURS OUTSIDE LIMITS OF SITE

BATTER 1 TO 12

SAWCUT EX. CONC. WHERE

REMOVAL IS INDICATED.
GRIND EX. CONC. EDGE TO

MATCH TO CONC. TOOLED EDGE

EX. CONC. PVMT WHERE OCCURS\

NATIVE SUBGRADE

SLOPE

NOTES:

- DIMENSION LINE

- BATTER 1 TO 12

SHOWN ON PLAN

PAVEMENT PER PLAN

#4 x 18" REBAR @ 24" O.C.

GREASED AT NEW

RECOMPACTED SUB GRADE

AGGREGATE BASE ON

COMPACTED SUBGRADE

PER CONC. PVMT DETAIL HEREON.

DRILL/DRYPACK AT EX. CONC.

AC PVMT (TYP)

PER PLAN

- 4" THICK COMPACTED

AGGREGATE BASE ON

**CONCRETE CURB** 

**CONCRETE JOIN TO EX. CONCRETE** 

WIDTH (W) PER PLAN

- 2-#4 CONT.

CONCRETE GUTTER IN AREAS OF ACCESS GATE CLEARANCES SHALL MAINTAIN SLOPE AT 2% MAX.

**CONCRETE GUTTER** 

ELEV. PER PLAN

3" WIDE METAL

TROWEL FINISH

COMPACTED SUBGRADE

- 6" MAX. UNLESS OTHERWISE

BASE COURSE

SUB GRADE:

SUB GRADE:

SEALANT RESERVOIR

EX PAVEMENT: DRILL HOLE AND

ANCHOR DOWEL WITH EPOXY.

OTHERWISE HAVE BEEN REQUIRED.

4. STOP SLAB REINFORCING AT CONSTRUCTION JOINTS.

JOINT FILLER

1/4" RADIUS

JOINT FILLER

JOINT FILLER:

**OVER 3" THICK** 

3" THICK OR LESS

SECOND POUR

- 1/4" RAD. OR SAWED

1/2" DIA. SMOOTH DOWEL BAR

LUBRICATED

PREVENT BOND

18" LONG @ 24" O.C. - ONE SIDE

1/8"-1/4"

1-1/4" MIN.

**ASPHALT PAVEMENT** 

1. USE SMOOTH BARS FOR DOWELS COATED TO PREVENT BOND, OR GREASE ONE END PRIOR TO

2. CONSTRUCTION JOINTS SHALL ONLY BE LOCATED WHERE A CONTRACTION OR OTHER JOINT WOULD

3. PROVIDE ADEQUATE SUPPORT FOR DOWELS TO ENSURE THEY REMAIN LEVEL WITH FINISH SURFACE.

**CONSTRUCTION JOINT** 

PER ASTM D1751; ASPHALT IMPREGNATED FIBERBOARD OR FELT, 0.25-INCH THICK; TONGUE AND GROOVE PROFILE,

PER ASTM D1752; PREMOLDED SPONGE RUBBER FULLY COMPRESSIBLE WITH RECOVERY RATE OF MIN. 95 PERCENT.

**ISOLATION JOINT** 

ASTM C309, ACRYLIC COPOLYMER, HIGH SOLID CURING AND SEALING COMPOUND.

1/4"

FIRST POUR

SCARIFY AND RECOMPAC

95% RELATIVE COMPACTION

ASHALT SURFACE COURSE


SCARIFY AND RECOMPACT


95% RELATIVE COMPACTION


NATIVE SUBGRADE


AND SEAL

NATIVE SUBGRADE

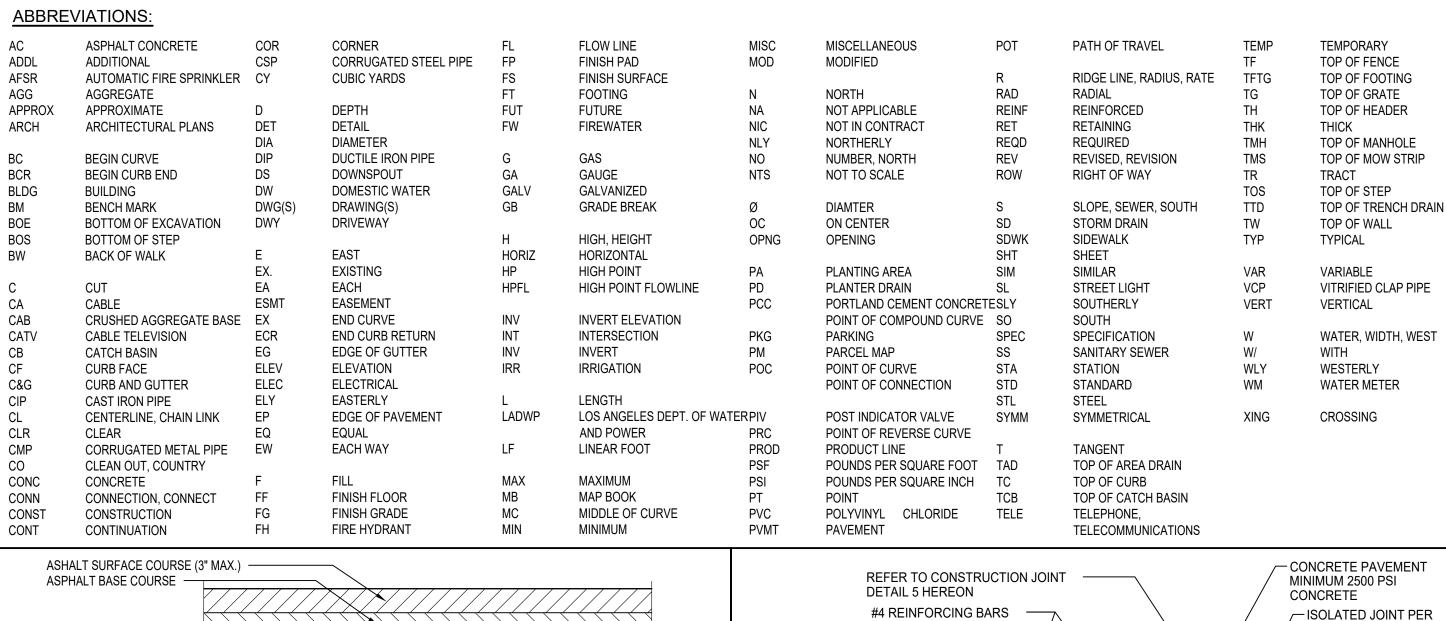

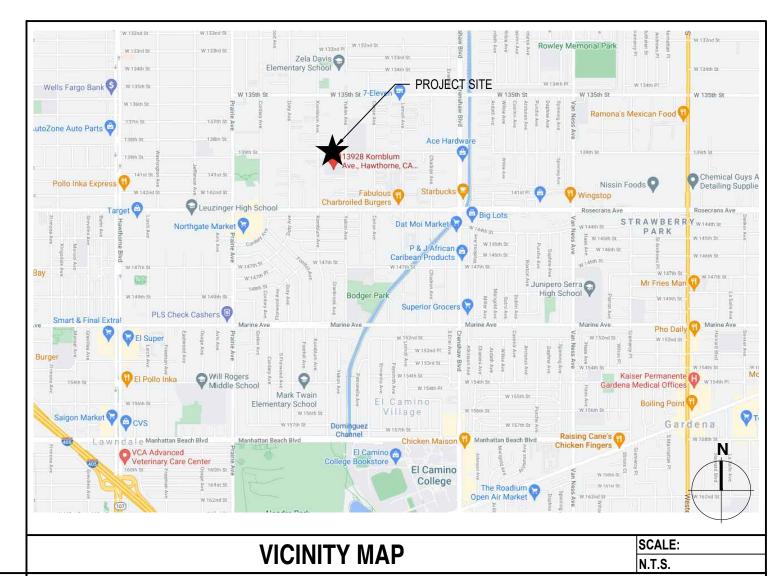

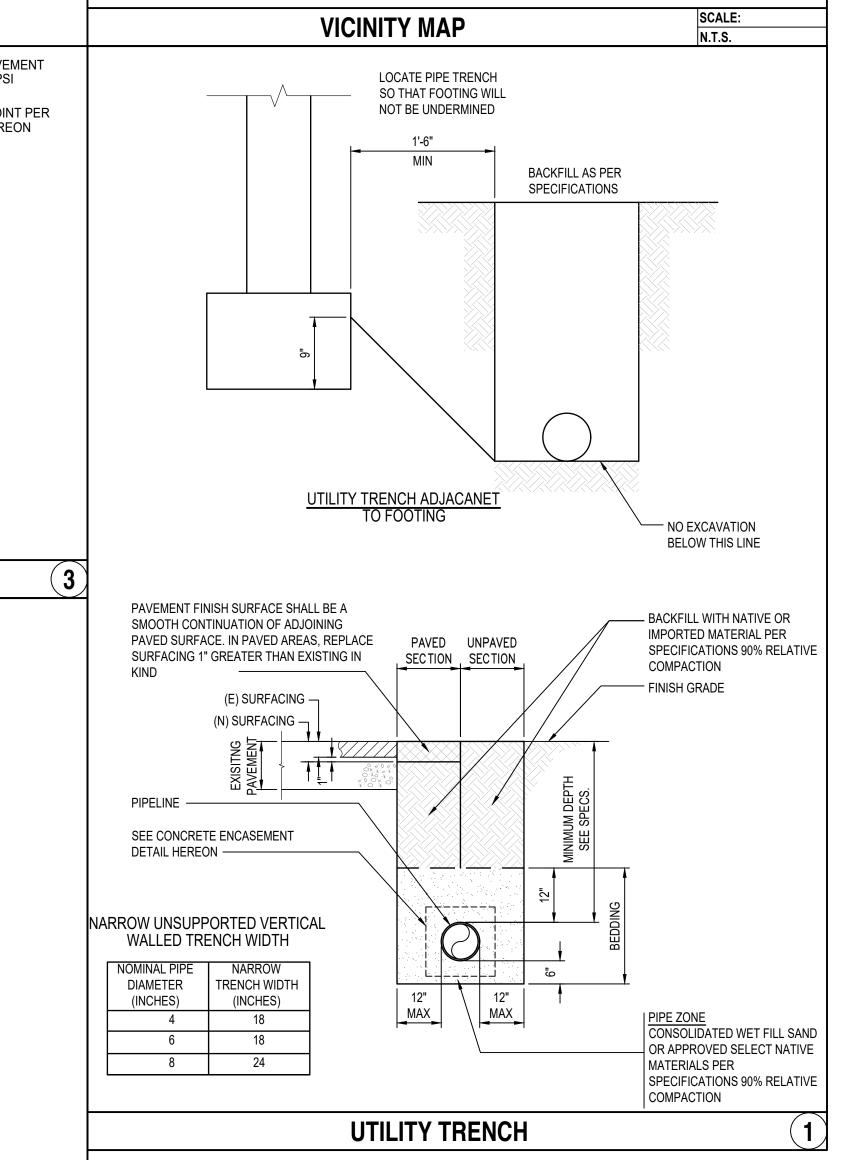

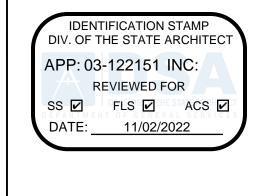

## abode communities architecture

PROJECT:

#### LAEP EARLY **CHILDHOOD CENTER**

13928 KORNBLUM AVE. HAWTHORNE, CA 90250

CLIENT:

**Los Angeles Education** Partnership

1541 Wilshire Blvd., Suite 200 Los Angeles, CA 90017 T: 213.622.5237

ARCHITECT:

**Abode Communities** 1149 S. Hill Street, Suite 700 Los Angeles, CA 90015 T: 213.629.2702

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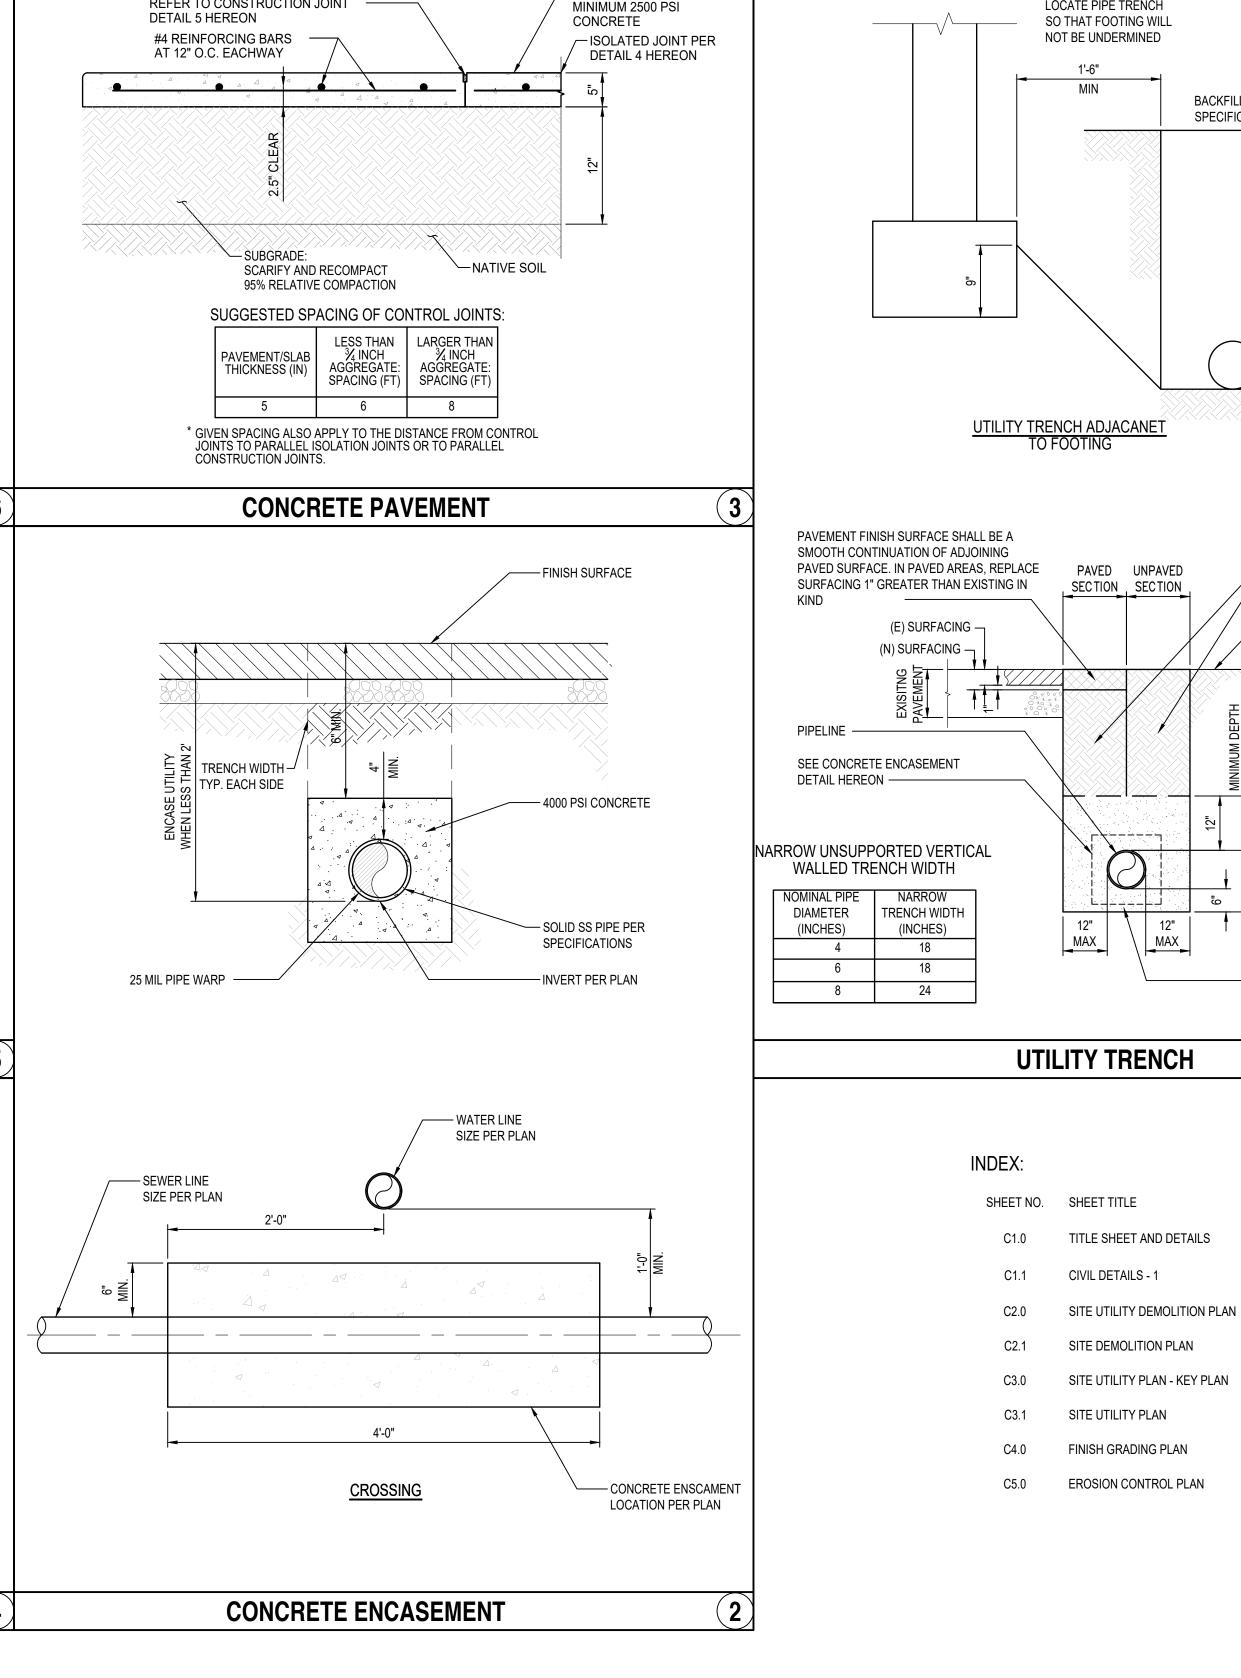
DATE REV PROGRESS SET 02.01.22 DSA PROGRESS SET 03.02.22 DSA APPLICATION SET 04.01.22

DSA BACK-CHECK SET 10.05.22

TITLE SHEET AND DETAILS

SHEET NUMBER: C1.0

SHEET NAME:




ITEM	HEIGHT	WIDTH	NOMINAL OUTSIDE PIPE SIZE DIAMETER			AND DEPTH EDMENT*
			(INCHES)	(INCHES)	DIAMETER (INCHES)	DEPTH (INCHES)
	UP TO 6'-0"	UP TO 4'-0"	2	2.375	12	36
CATE	UP TO 6'-0"	4'-0" TO 10'-0"	2.5	2.875	14	42
GATE POSTS-SINGLE AND	UP TO 6'-0"	10'-0" TO 18'-0"	3.5	4	16	72
DOUBLE LEAF	OVER 6'-0"	UP TO 6'-0"	2.5	2.875	14	42
SWING GATES	OVER 6'-0"	6'-0" TO 12'-0"	3.5	4	16	72
	OVER 6'-0"	12'-0" TO 18'-0"	6	6.625	18	84
	OVER 6'-0"	18'-0" TO 24'-0"	8	8.625	20	96
	21'-0" MAX.	16'-0" MAX. (8' EA. GATE)	8(8x-STRONG)	8.625	18	81
GATE FRAME MEMBERS	UP TO 16'-0"	N/A	1.5	1.9	N/A	N/A
WEWBERO	16'-1" TO 24'-0"	N/A	2	2.375	N/A	N/A
TOP RAIL, BRACE	UP TO 10'-0"	N/A	1.25	1.66	N/A	N/A
RAILS AND	10'-1" TO 16'-0"	N/A	1.5	1.9	N/A	N/A
TRANSOM RAILS	16'-1" TO 24'	N/A	2	2.375	N/A	N/A
LINE POOTS	UP TO 6'-0"	N/A	2	2.375	12	36
LINE POSTS	6'-1" TO 8'-0"	N/A	3	3.5	14	48
	8'-1" TO 10'-0"	N/A	3	3.5	14	48
	10'-1" TO 16'-0"	N/A	3	3.5	14	60
	UP TO 8'-0"	N/A	3	3.5	12	36
TERMINAL,	8'-1" TO 10'-0"	N/A	2.5	2.875	14	42
CORNER, ANGLE	10'-1" TO 16'-0"	N/A	3	3.5	14	60
& PULL POSTS	16'-1" TO 19'	N/A	4	4	16	72
	19'-1" TO 24'	N/A	6.5	6.625	18	84


\* EMBED POSTS INTO FOOTING 6 INCHES LESS THAN THE DEPTH OF THE FOOTING. DEVIATIONS FROM FOOTING SCHEDULE WILL REQUIRE SOIL TEST AND CALCULATIONS BY A CALIFORNIA LICENSED CIVIL OR STRUCTURAL ENGINEER.

TEST/SPECIAL INSPECTION EXEMPT PER FORM 103

#### **POSTS, RAILS & FOOTING SCHEDULE** REFER TO DETAIL 3 HEREON FOR POSTS, FOOTING, AND RAIL SCHEDULE \*\*BRACE RAIL / SEE DETAIL 3 HEREON FOR SIZE FENCE FABRIC PROVIDE 11GA. TENSION BAND <sup>/</sup> 12" O.C. MALLEABLE IRON BRACE BAND $ROD \frac{3}{8}$ " DIAMETER BRACE RAIL SEE SPEC SECTION 323113 FOR SIZE AND DETAIL 3 HEREON TRUSS ROD ADJUSTING UNIT 10' MAX\*\*\* \* CONCRETE FOOTING TENSION WIRE OR BRACE RAIL VARIABLE DEPTH REFER TO SPEC SECTION 323113 FOR SIZE AND DETAIL 3 HEREON \* REFER TO DETAIL 3 HEREON FOR SCHEDULE OF FOOTINGS \*\* BRACE RAIL REQUIRED FOR EACH ADDITIONAL 10 FEET OF FENCE HEIGHT. \*\*\* FOR EVERY 10' HORIZONTAL DISTANCE EXCEEDED, ADD AN ADDITIONAL VERTICAL MEMBER, AND FOOTING, UNLESS OTHERWISE STATED. \*\*\*\* GAPS AT STATIONARY FENCE CONDITIONS TO GRADE WILL BE 1" MAXIMUM, OTHERWISE GAPS WILL BE 2" AT MAXIMUM FOR ALL CHAIN LINK FENCING CONDITIONS AND TRANSITIONS TO ADJACENT CONSTRUCTIONS. TEST/SPECIAL INSPECTION **EXEMPT PER FORM 103**

**CHAIN LINK FENCE** 

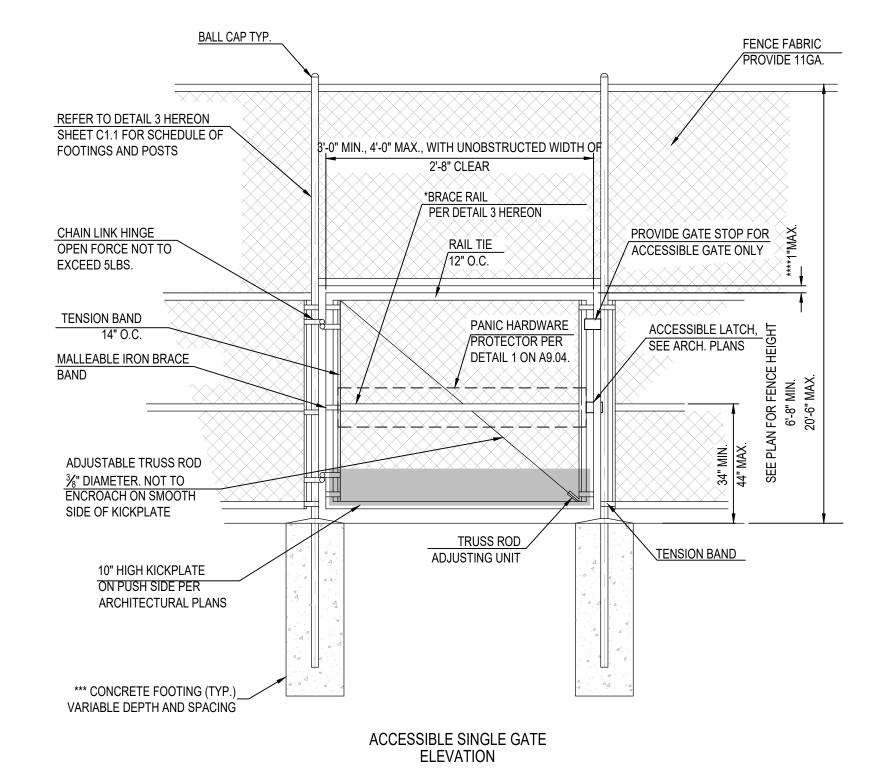

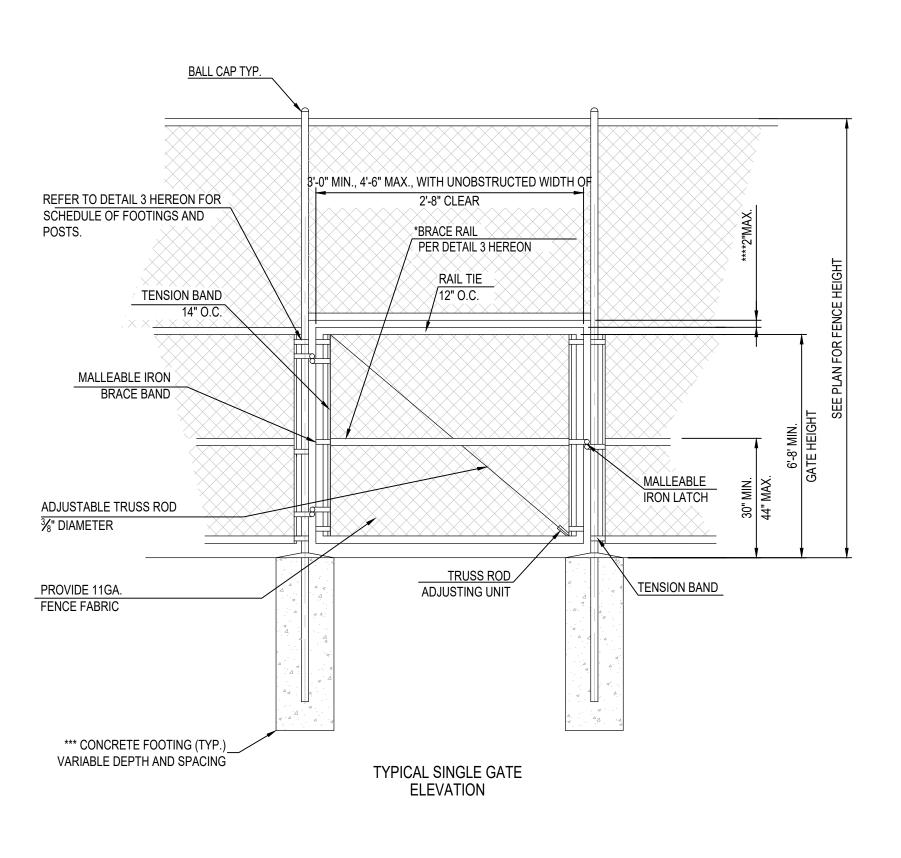

NOTES:

- \* BRACE RAIL REQUIRED FOR EVERY ADDITIONAL 8' OF FENCE HEIGHT.
- \*\* FOR EVERY 8' HORIZONTAL DISTANCE EXCEEDED, ADD AN ADDITIONAL VERTICAL MEMBER, UNLESS OTHERWISE STATED.
- \*\*\* REFER TO DETAIL 3 HEREON FOR SCHEDULE OF FOOTINGS AND POSTS.
- \*\*\*\* GAPS WILL BE 1" AT MAXIMUM FOR ALL CHAIN LINK FENCING CONDITIONS AND TRANSITIONS TO ADJACENT CONSTRUCTION.

**CHAIN LINK GATE** 

TEST/SPECIAL INSPECTION EXEMPT PER FORM 103

IDENTIFICATION STAMP DIV. OF THE STATE ARCHITECT APP: 03-122151 INC:

REVIEWED FOR
SS FLS ACS D

DATE: 11/02/2022

## abode communities architecture

PROJEC

# LAEP EARLY CHILDHOOD CENTER

13928 KORNBLUM AVE. HAWTHORNE, CA 90250

CLIENT:

Los Angeles Education Partnership 1541 Wilshire Blvd., Suite 200

Los Angeles, CA 90017

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PROGRESS SET 02.01.22

DSA PROGRESS SET 03.02.22

DSA APPLICATION SET 04.01.22

DSA BACK-CHECK SET 10.05.22


DSA BACK-CHECK SET 10.24.22

SHEET NAME:

**CIVIL DETAILS -1** 

SHEET NUMBER:

C1.1

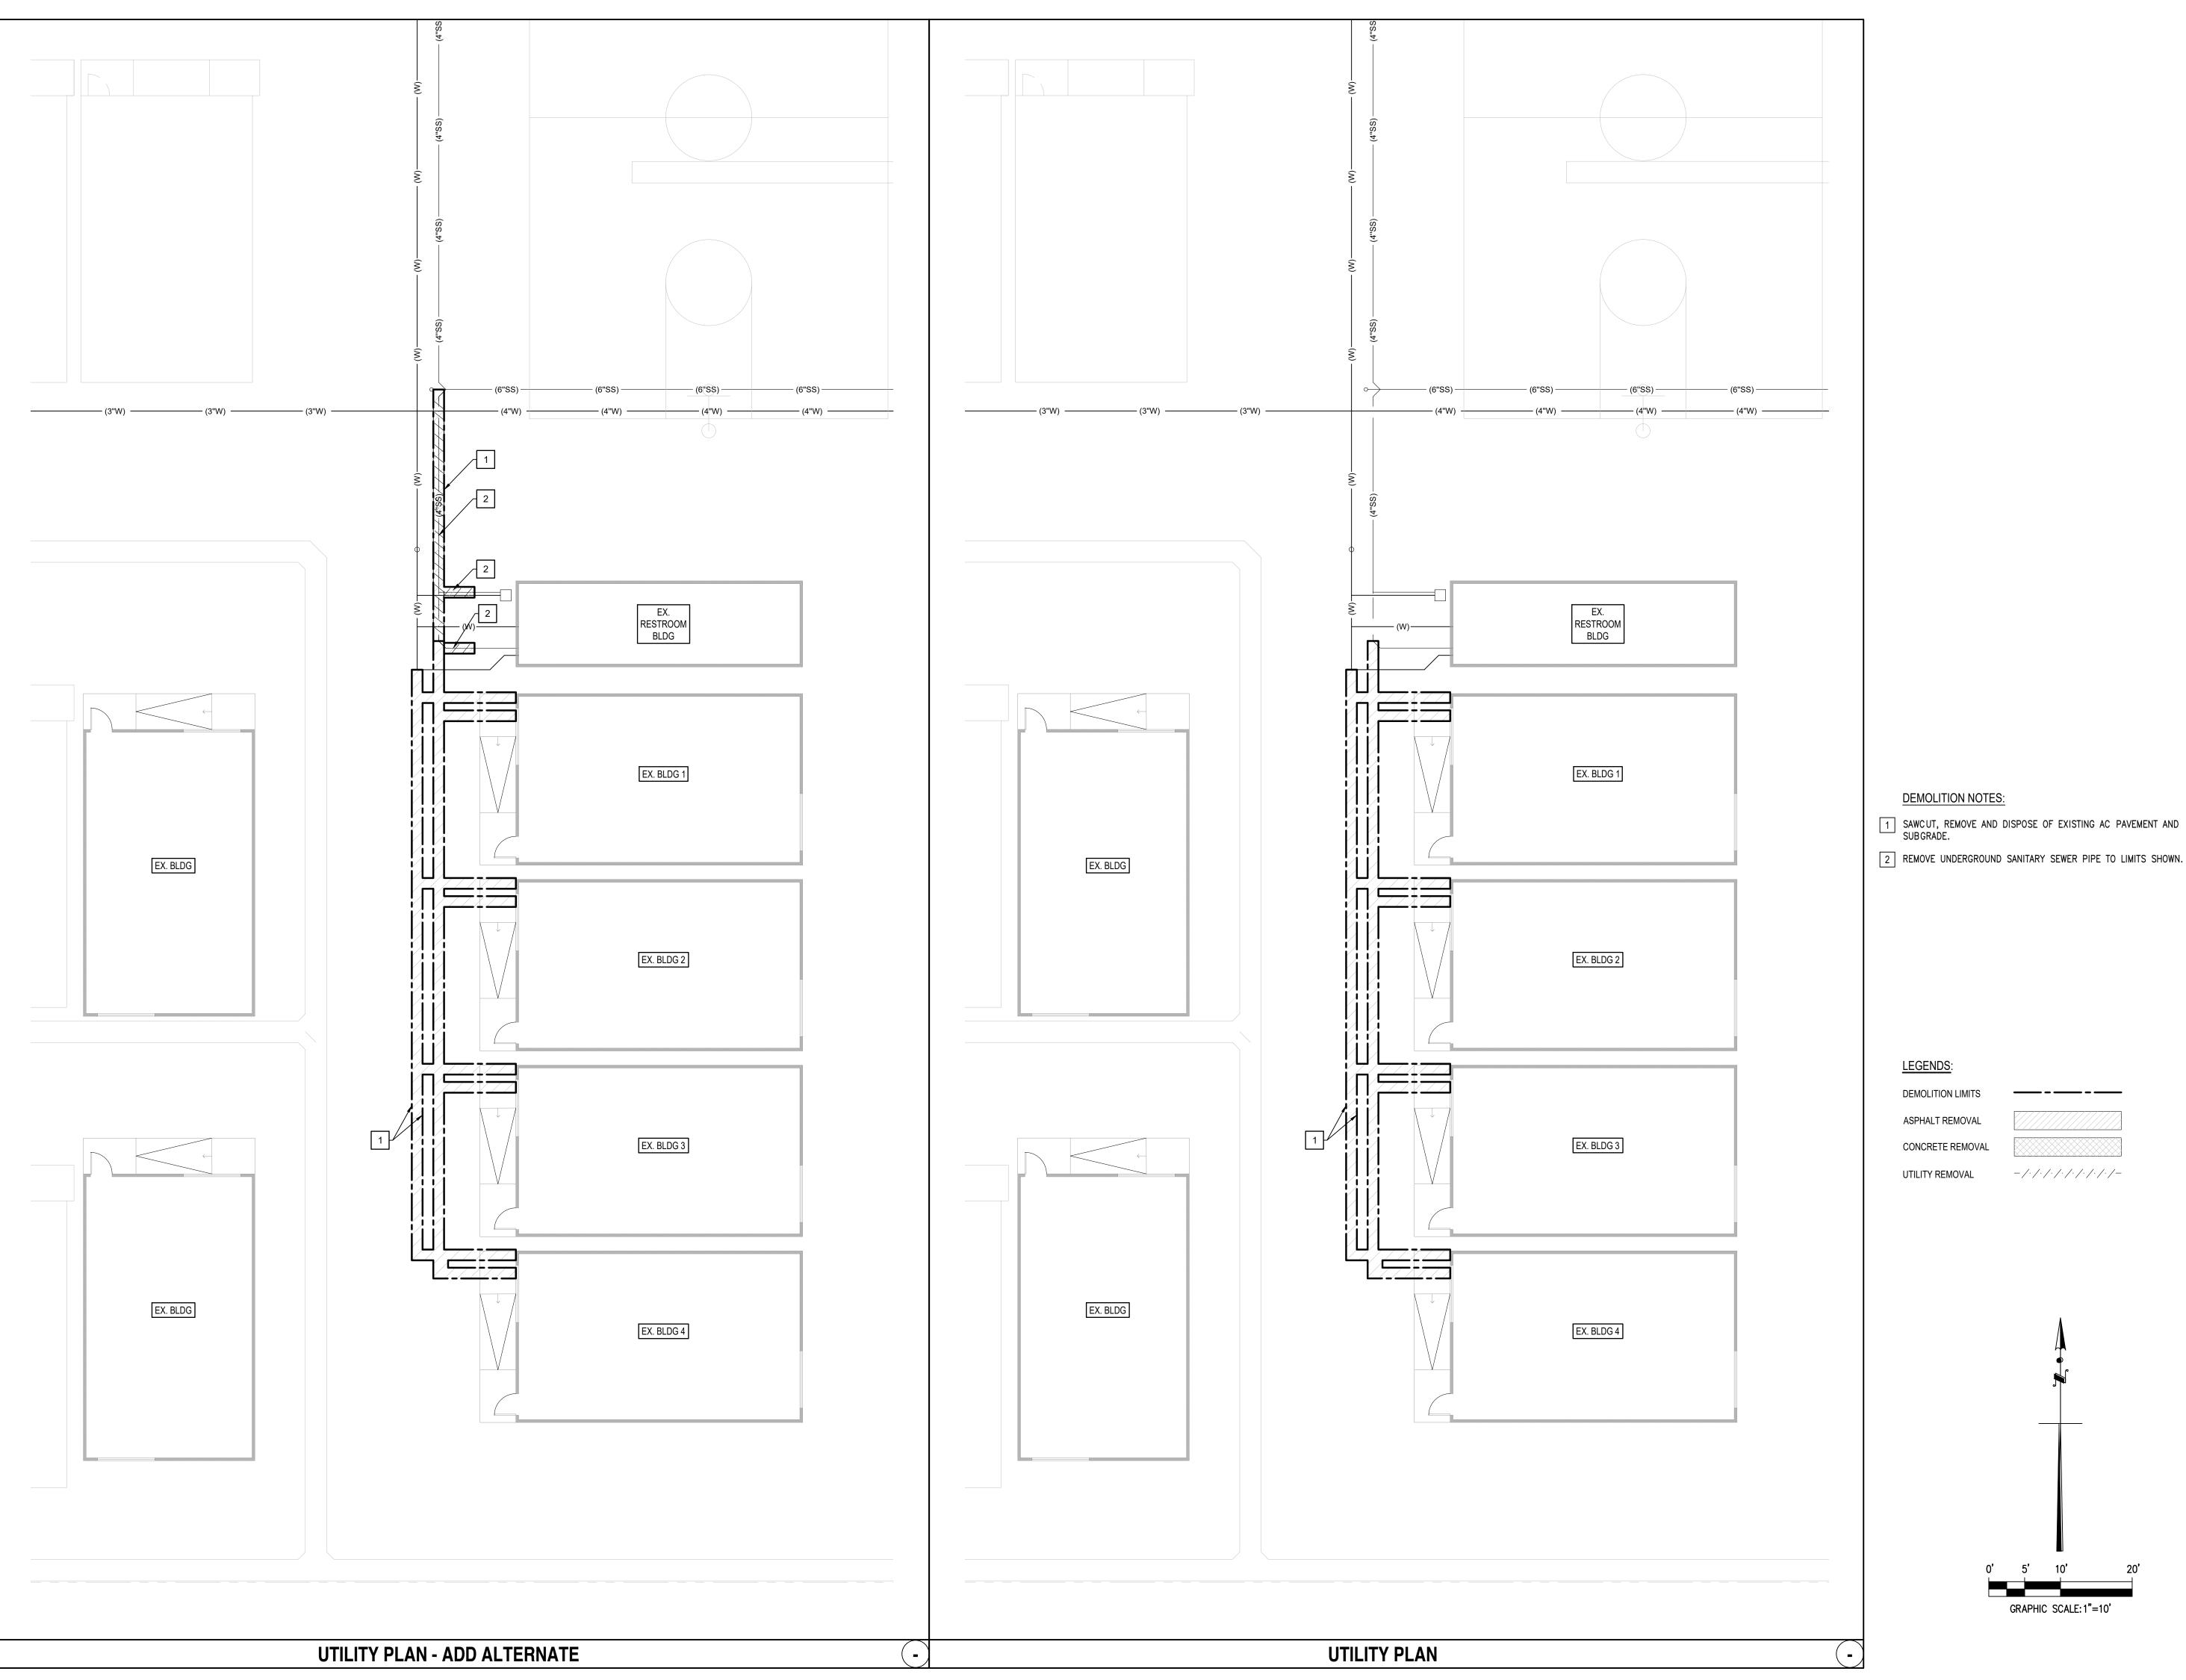

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**STRUCTURAL Breen Engineering** 1983 W. 190th St., Suite 200 Torrance, CA 90504

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### <u>LEGENDS</u>:

DEMOLITION LIMITS ASPHALT REMOVAL CONCRETE REMOVAL -/-/-/-/-/-/-/-/-UTILITY REMOVAL

GRAPHIC SCALE: 1"=10'

#### DSA APPLICATION NUMBER: 03-122151

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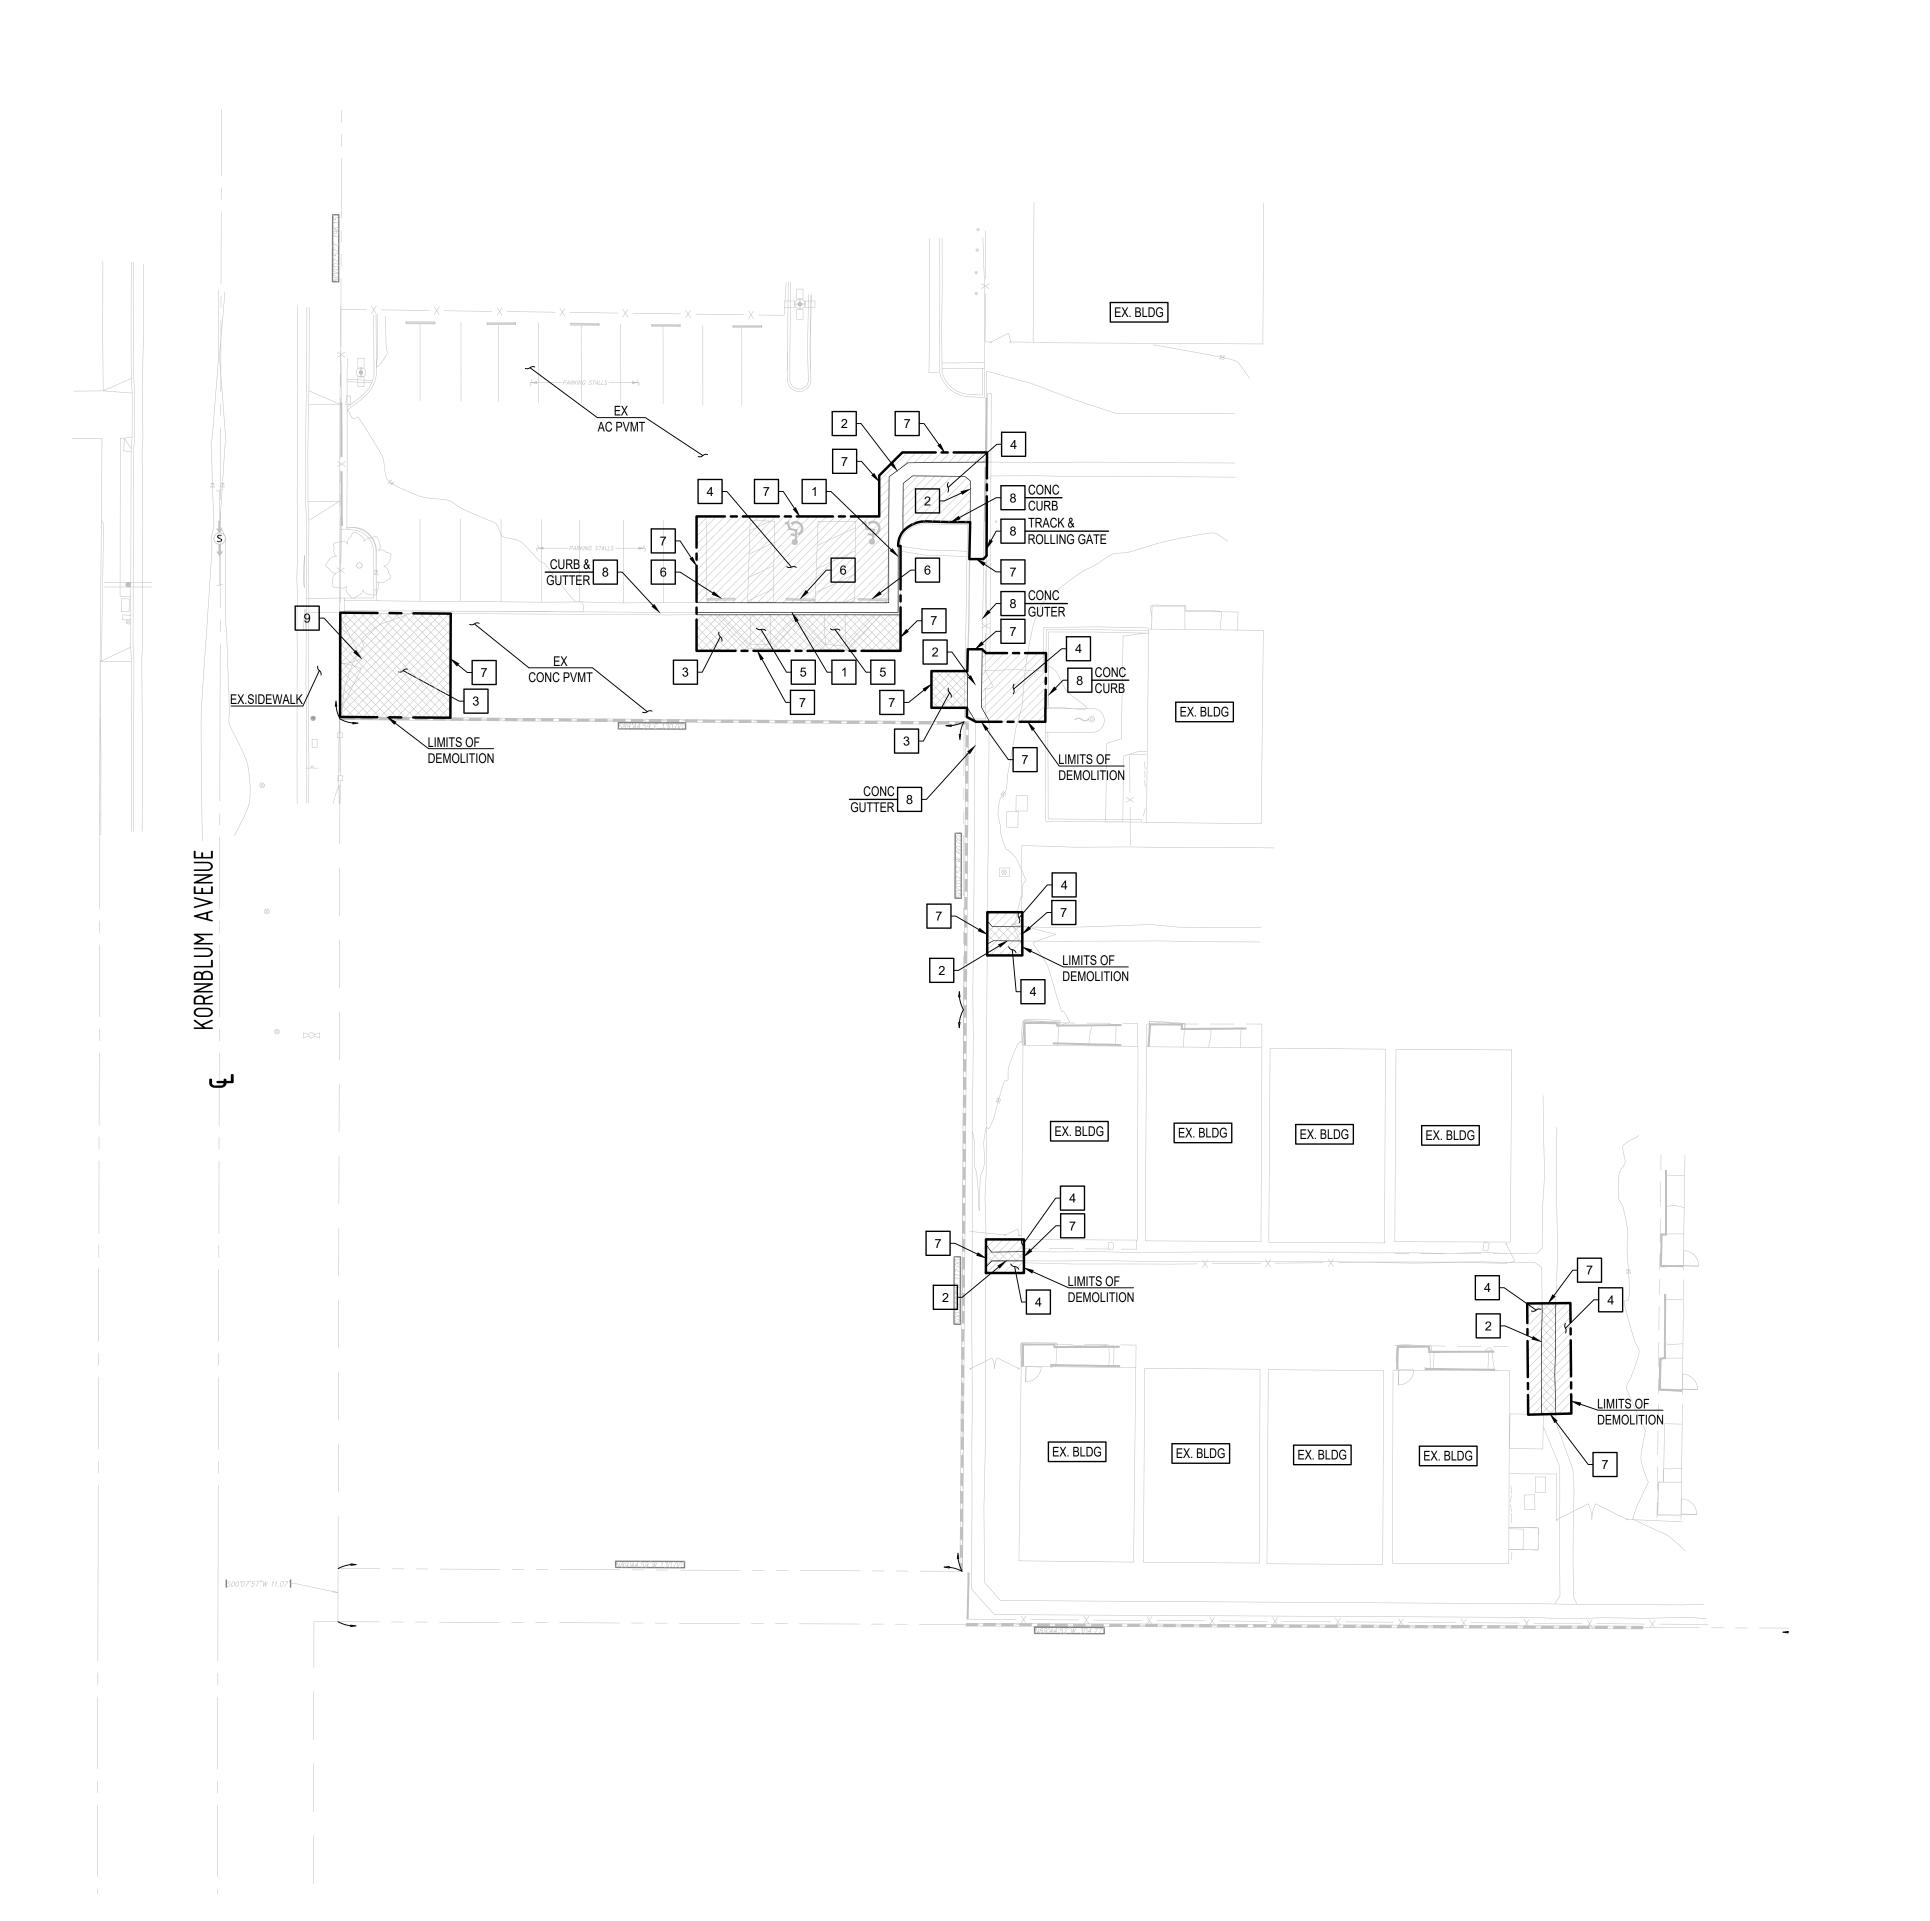
DATE REV PROGRESS SET 02.01.22 DSA PROGRESS SET 03.02.22 DSA APPLICATION SET 04.01.22 DSA BACK-CHECK SET 10.05.22

SHEET NAME:

SITE UTILITY **DEMOLITION PLAN** 

SHEET NUMBER:

C2.0



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## abode communities architecture

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### LEGENDS: DEMOLITION LIMITS ASPHALT REMOVAL

DEMOLITION NOTES:

2 REMOVE CONCRETE GUTTER.

3 REMOVE CONCRETE PAVEMENT.

5 REMOVE CONCRETE CURB RAMP.

7 SAWCUT LINE.

8 PROTECT IN PLACE.

1 REMOVE CONCRETE CURB AND GUTTER.

4 REMOVE ASPHALT CONCRETE CONCRETE PAVEMENT AND BASE.

9 REMOVE GATE AND FENCING. SEE ARCHITECTURAL DRAWINGS FOR PROPOSED LIMITS.

6 REMOVE AND REINSTALL CONCRETE WHEEL STOPS.

CONCRETE REMOVAL UTILITY REMOVAL

-/-/-/-/-/-/-/-/-

GRAPHIC SCALE:1"=20'

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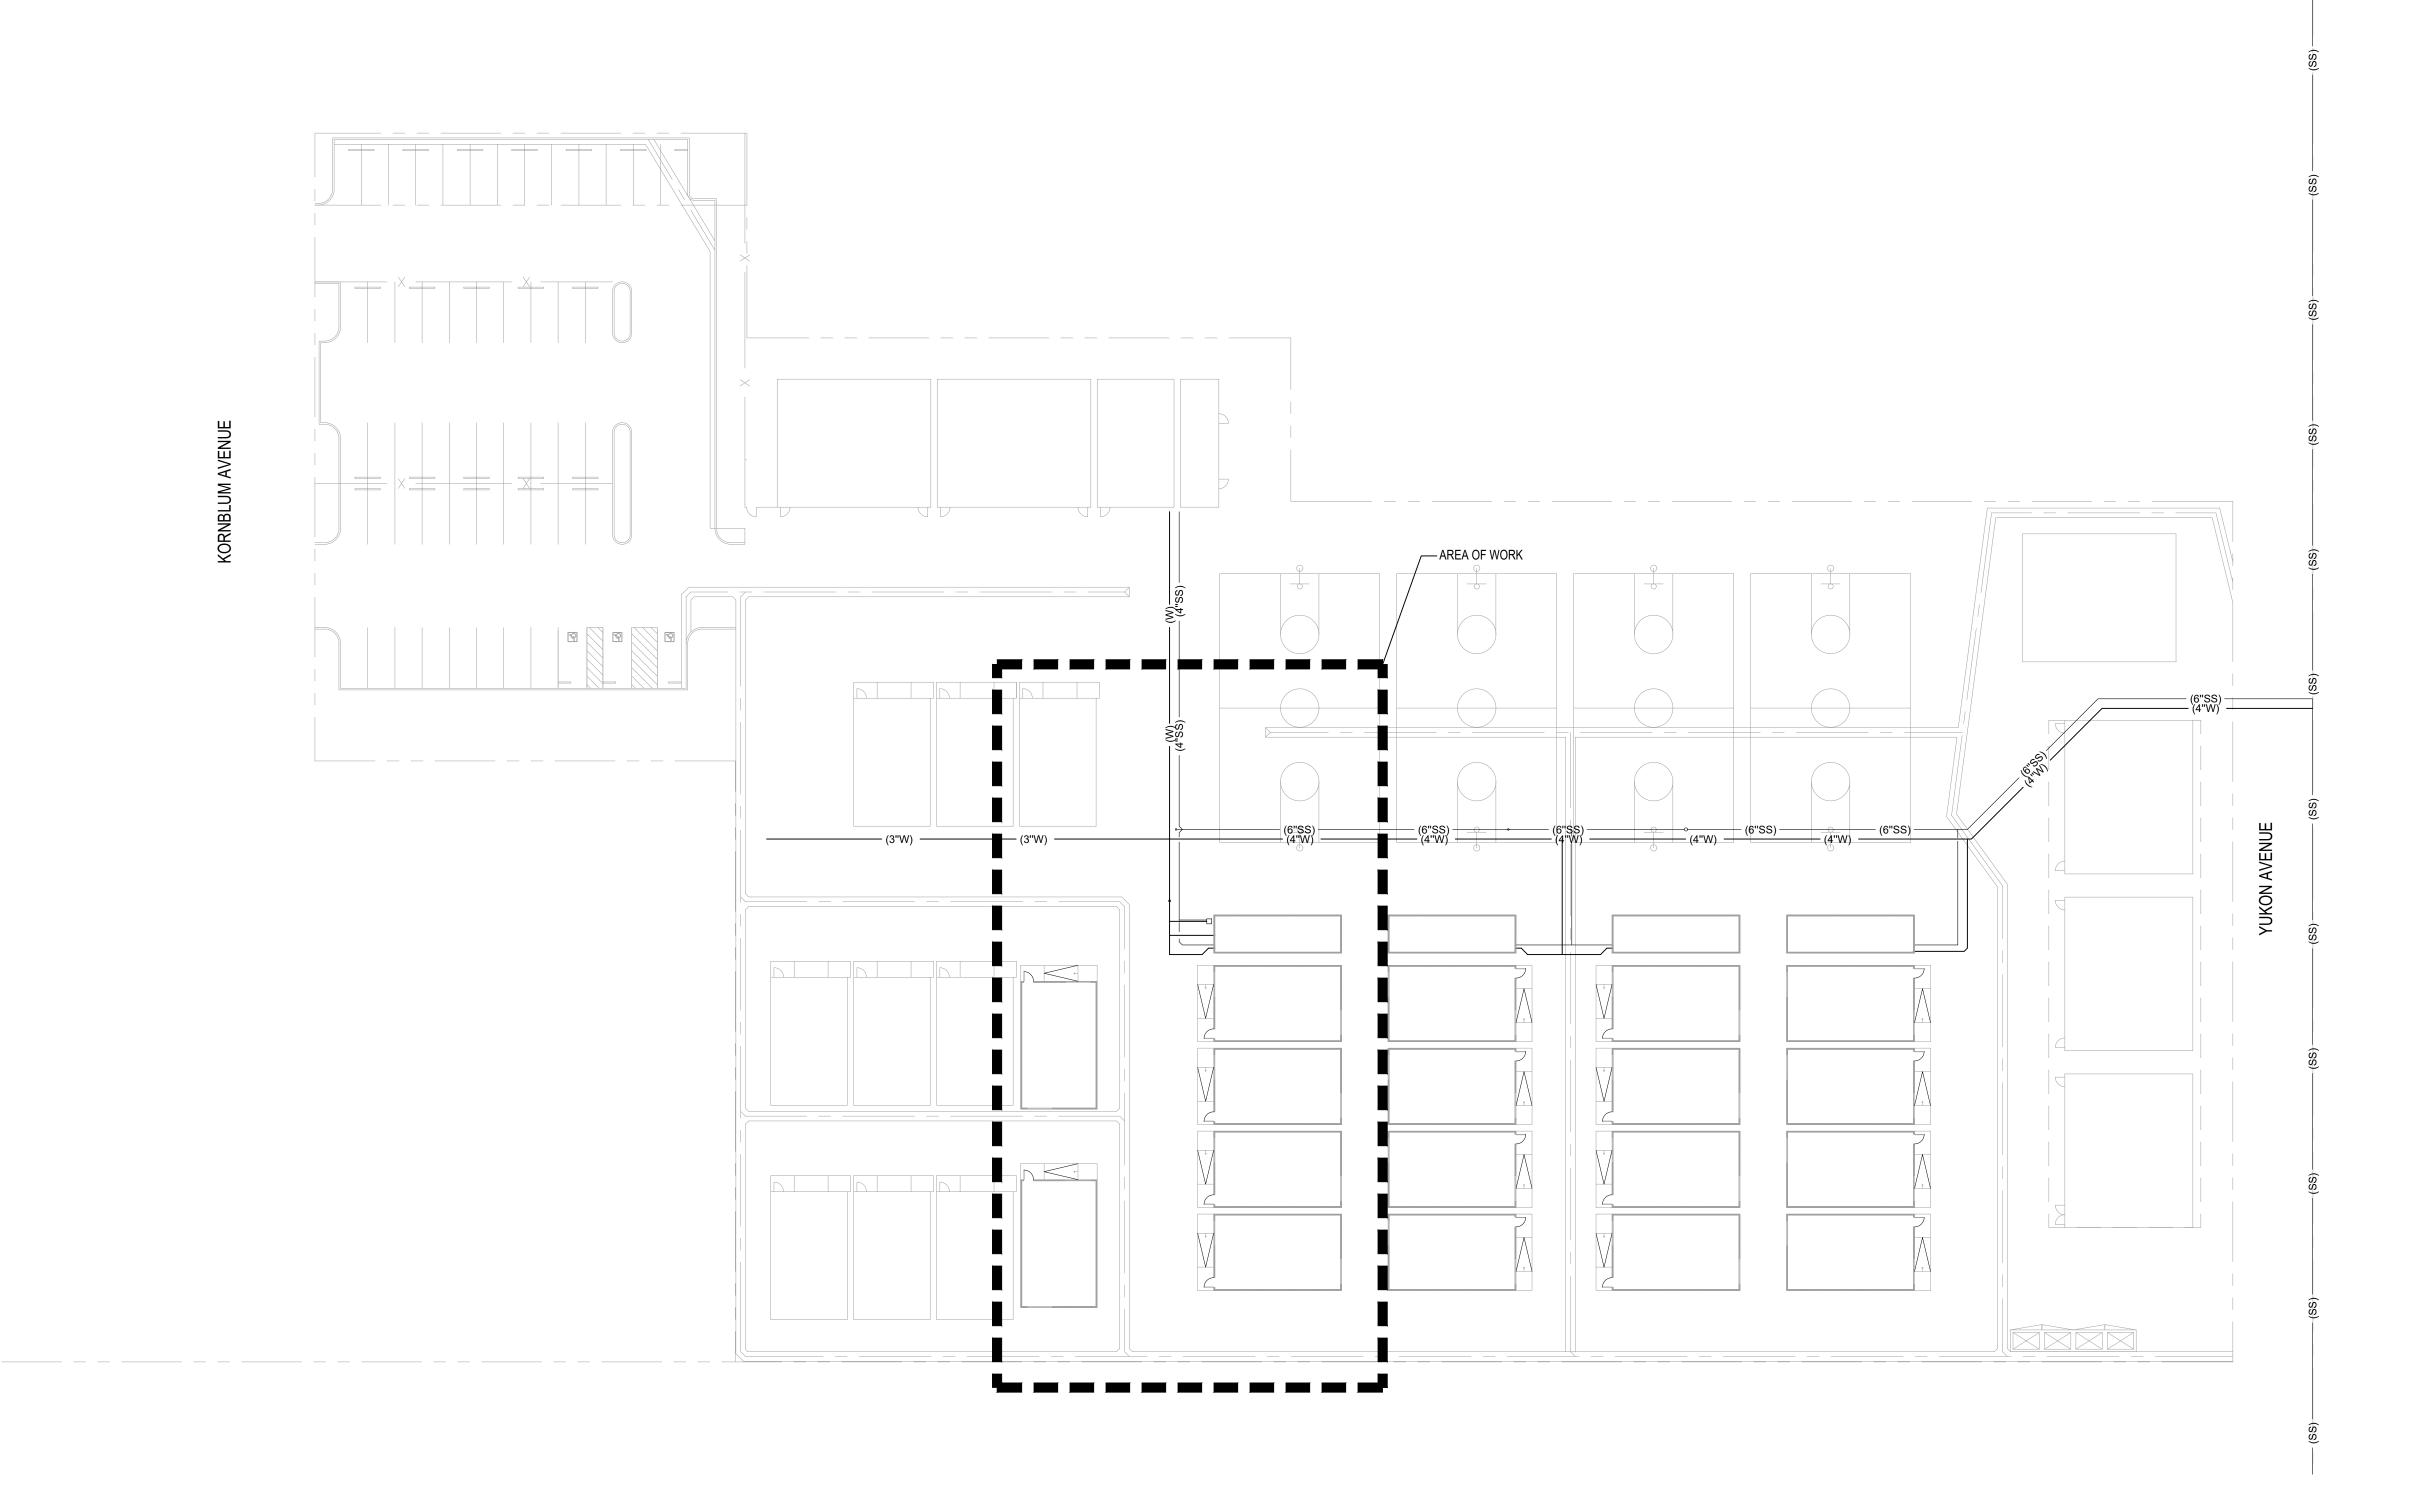
DATE REV PROGRESS SET 02.01.22 DSA PROGRESS SET 03.02.22 DSA APPLICATION SET 04.01.22 DSA BACK-CHECK SET 10.05.22

SHEET NAME:

SITE DEMOLITION PLAN

SHEET NUMBER:

C2.1



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PROGRESS SET 02.01.22

DSA PROGRESS SET 03.02.22

DSA APPLICATION SET 04.01.22


DSA BACK-CHECK SET 10.05.22


SHEET NAME:

SITE UTILITY PLAN - KEY PLAN

SHEET NUMBER:

C3.0

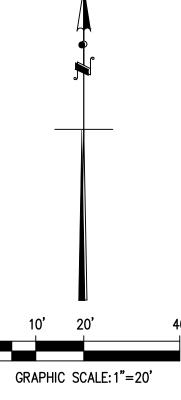

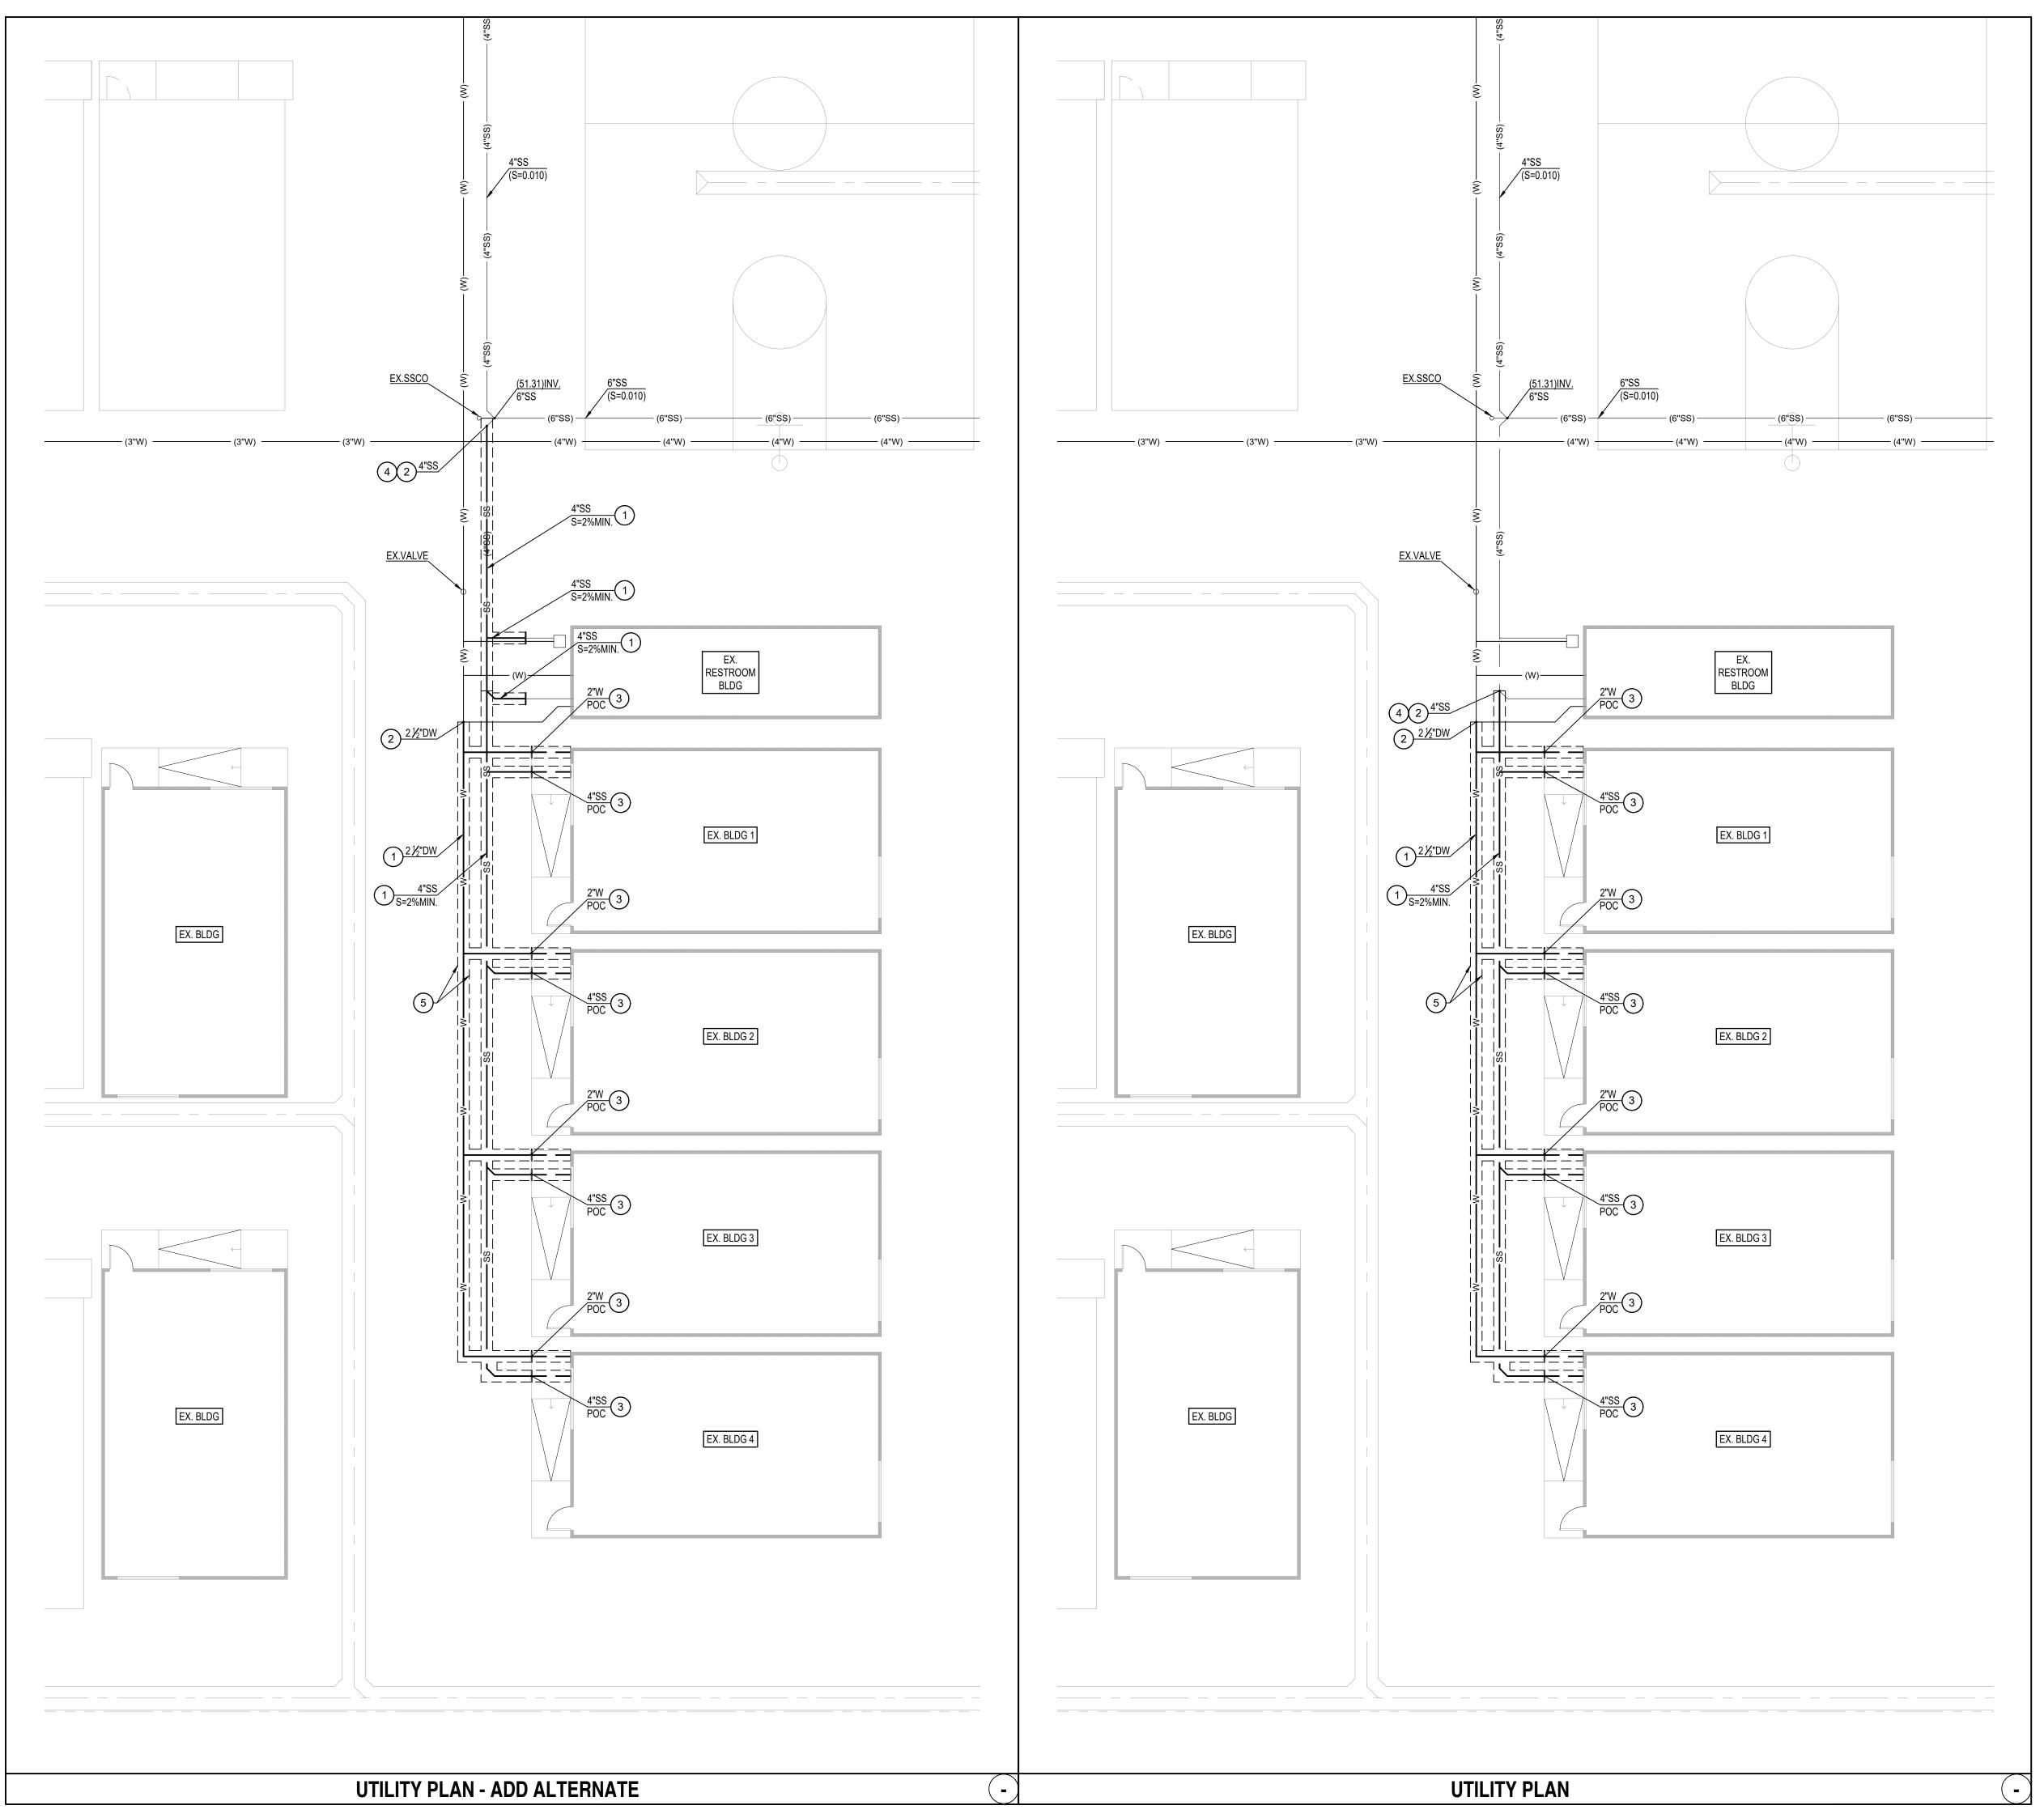

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# abode communities architecture

#### LAEP EARLY CHILDHOOD CENTER

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**STRUCTURAL** Breen Engineering 1983 W. 190th St., Suite 200 Torrance, CA 90504 T: 310.464.8404

#### **CONSTRUCTION NOTES**

- CONSTRUCT UTILITIY IN TRENCH PER PER DETAIL 1 ON SHEET C1.0.
- 2) CONNECT TO EXISTING UNDERGROUND UTILITY.
- 3 CONNECT TO BUILDING UTILITY. REFER TO PLUMBING PLANS FOR CONTINUATION.
- PRIOR TO CONSTRUCTION, CONTRACTOR SHALL POTHOLE EXISTING UTILITY IN FIELD TO VERIFY PIPE ELEVATION.
- 5 CONSTRUCT ASPHALT CONCRETE PAVEMENT (C2-PG 54-10). MINIMUM DEPTH SHALL BE 3-INCHES(OR ASPHALT CONCRETE PAVEMENT SECTION PLUS 1-INCH, WHICHEVER IS GREATER), OVER 6" CMB OVER 24" OF 95% COMPACTED SUBGRADE.

GRAPHIC SCALE:1"=10'

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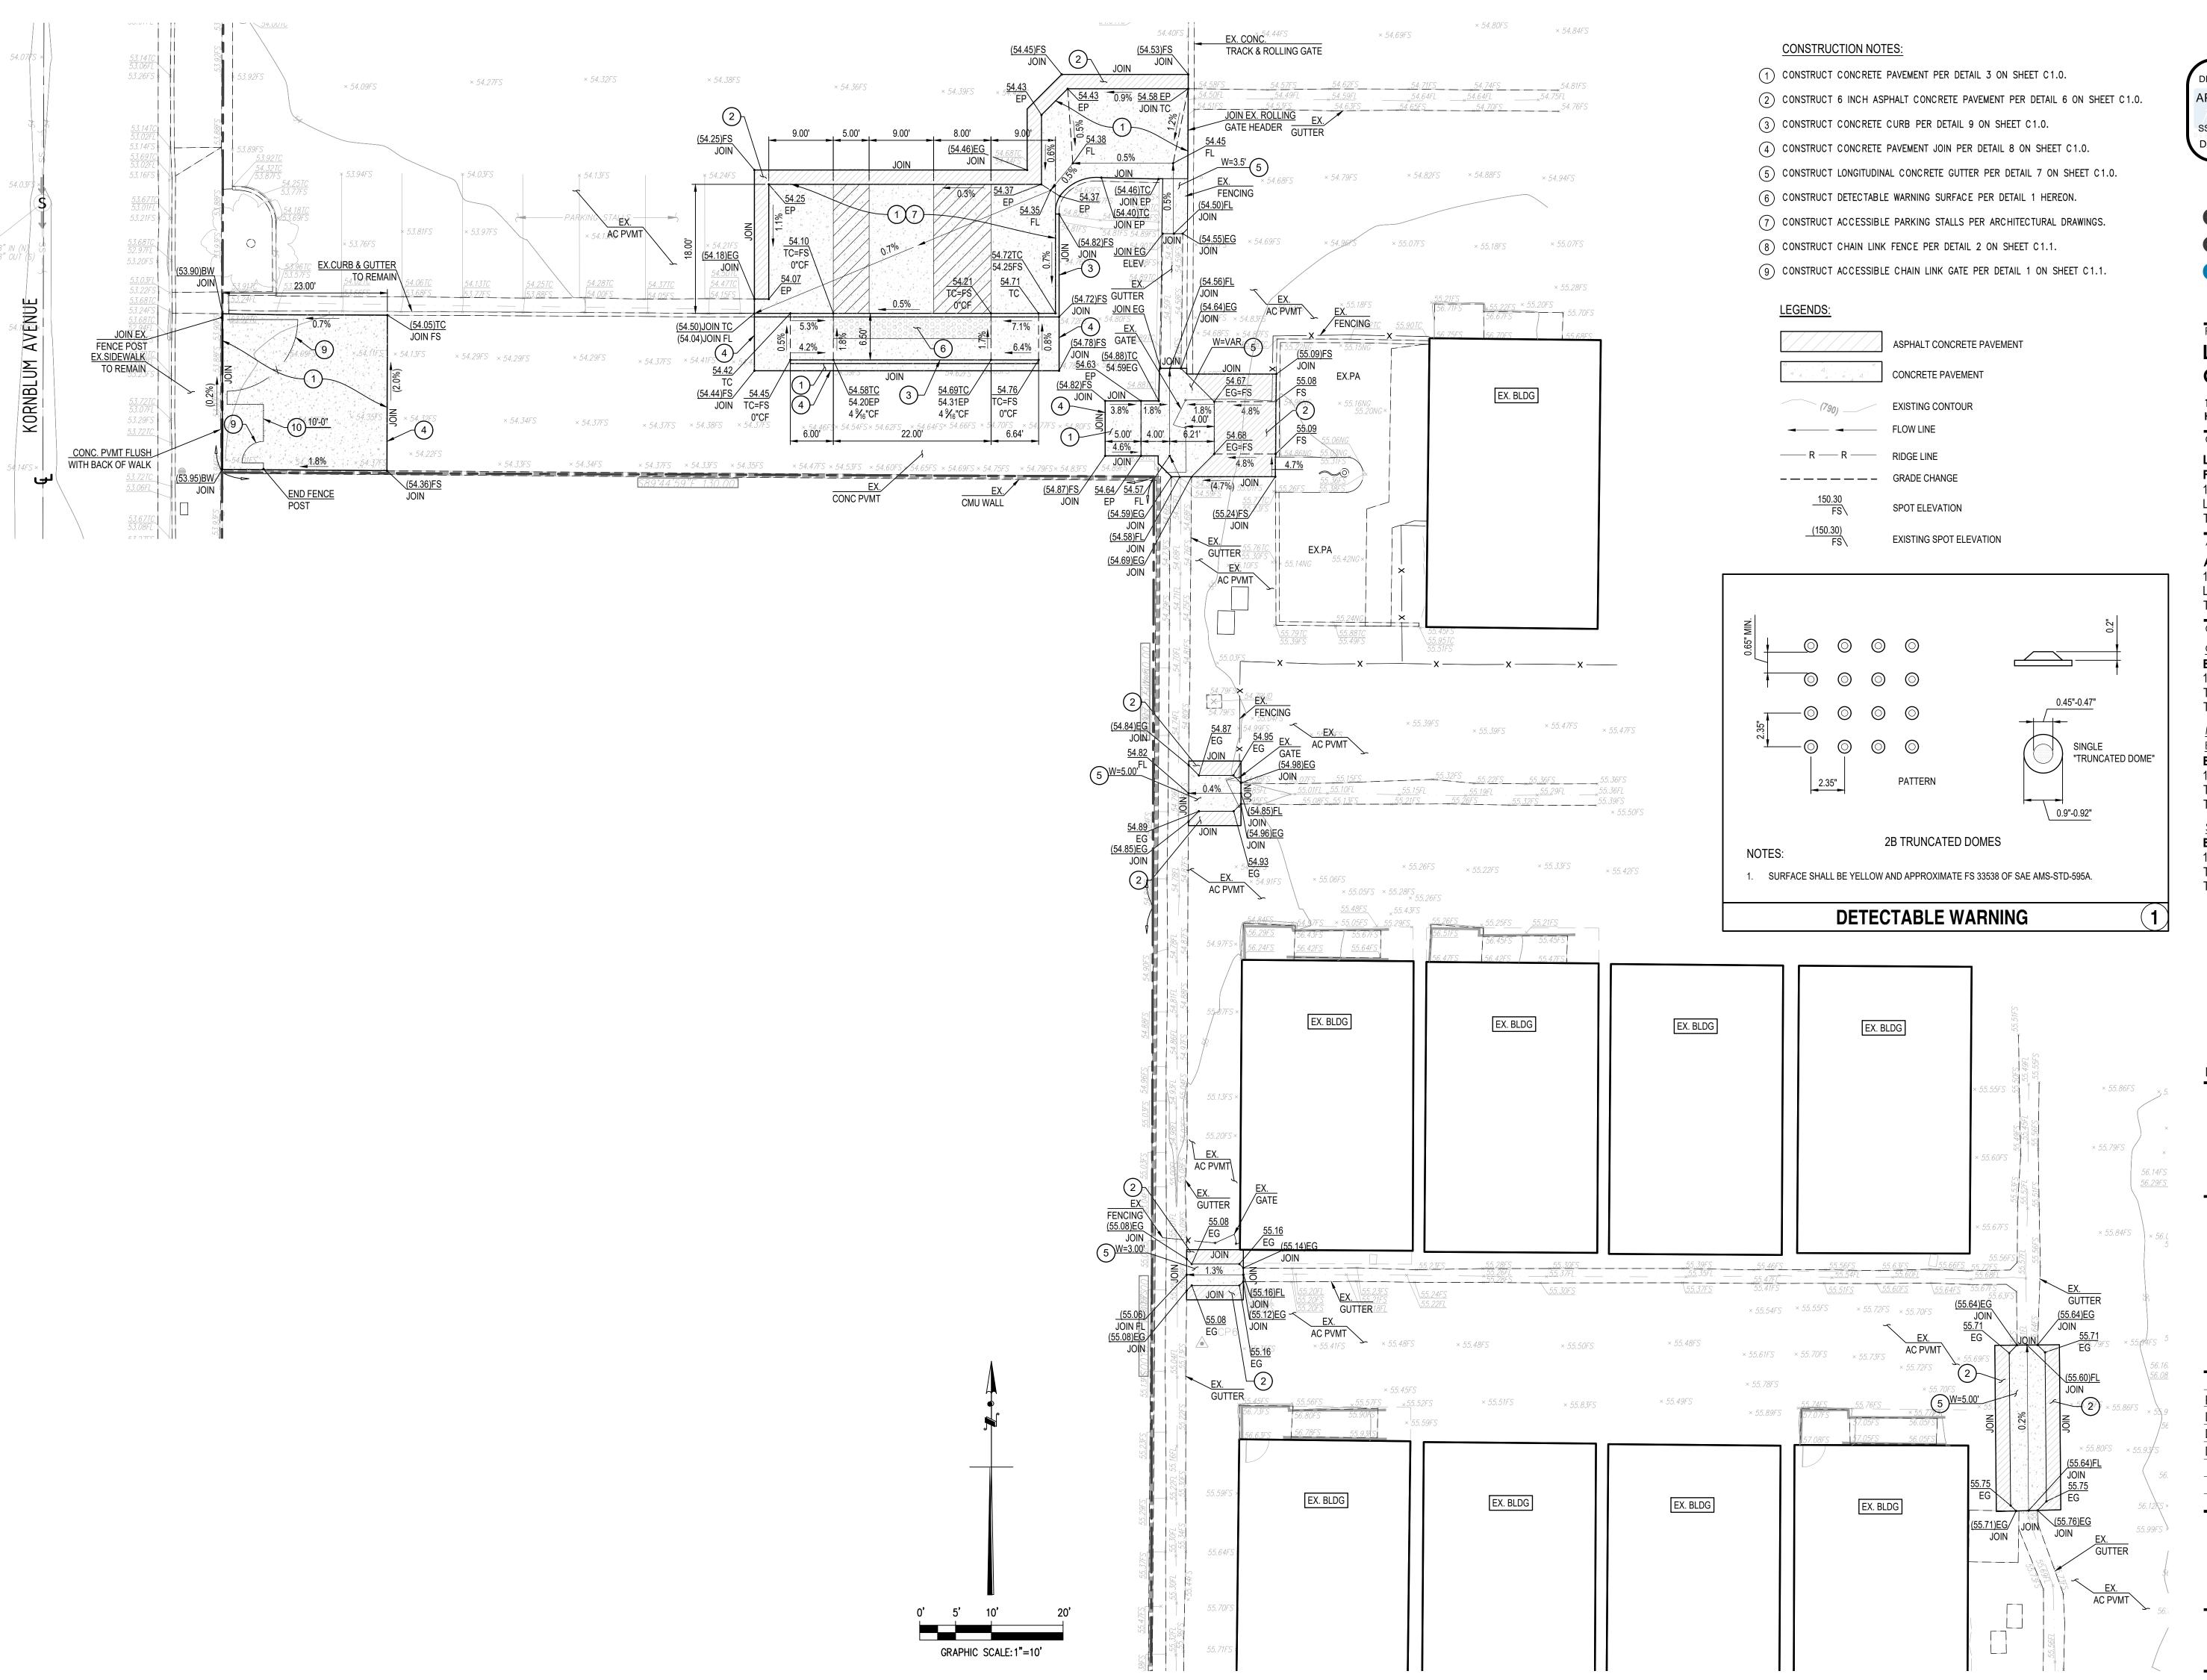


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SHEET NAME:

SITE UTILITY PLAN

SHEET NUMBER: C3.1



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T: 310.464.8404

### DSA APPLICATION NUMBER: 03-122151

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STAMP:



PROGRESS SET 02.01.22

DSA PROGRESS SET 03.02.22


DSA APPLICATION SET 04.01.22

DSA BACK-CHECK SET 10.05.22

SHEET NAME:

FINISH GRADING PLAN

SHEET NUMBER: C4.0

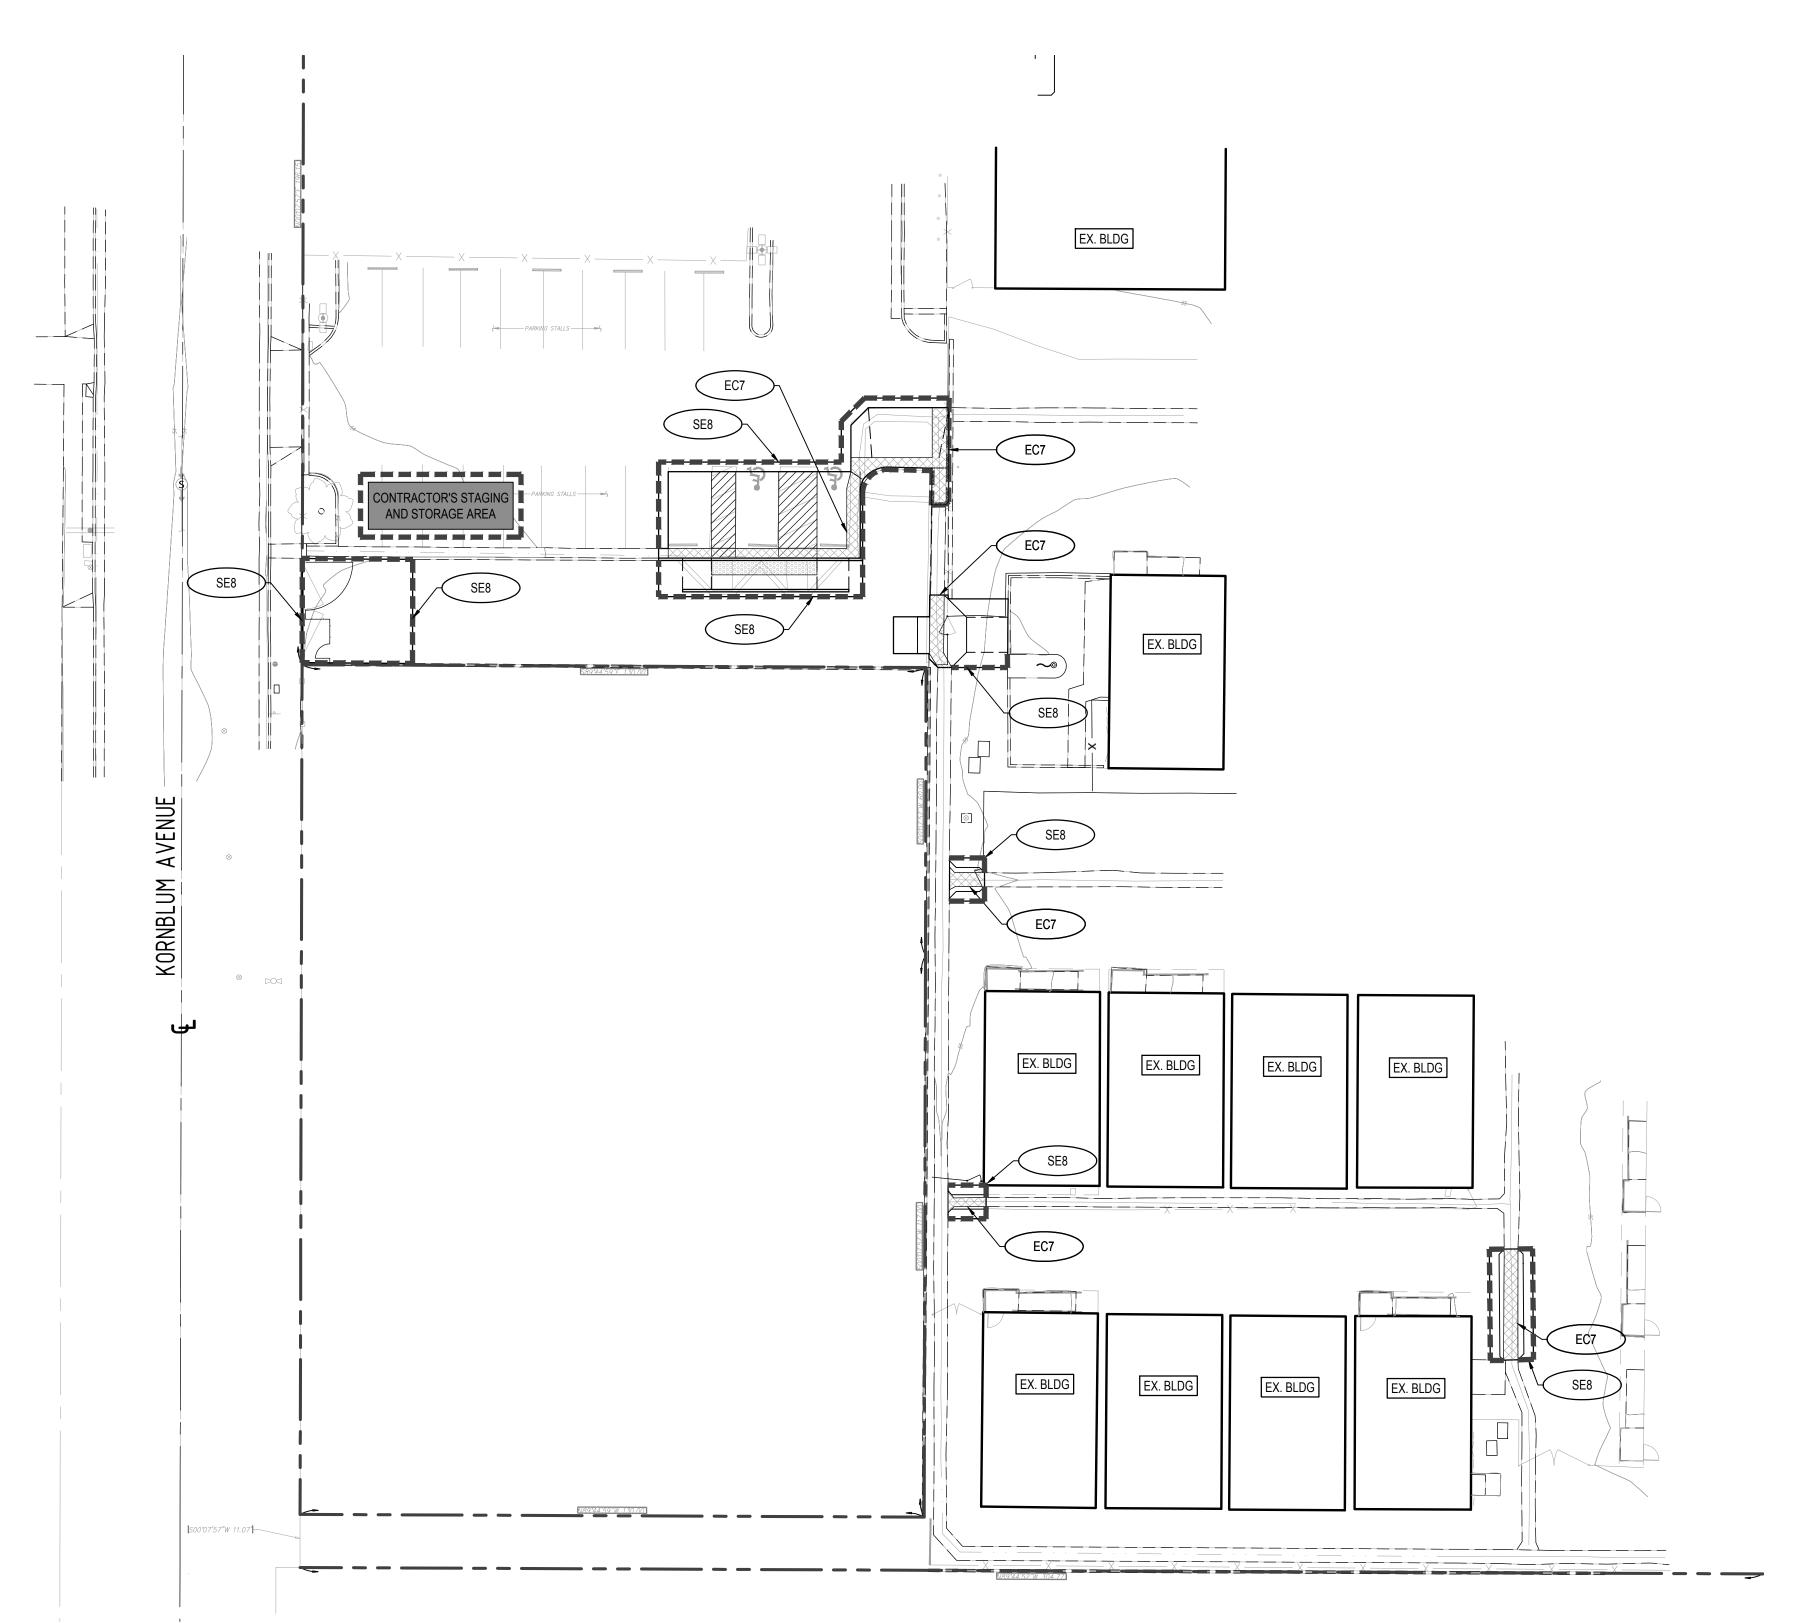


#### **EROSION CONTROL GENERAL NOTES**

- 1. IN CASE OF EMERGENCY CALL RODGER LEONARD @ 310 505 8621 (24-HR CONTACT).
- 2. A STANDBY CREW FOR EMERGENCY WORK SHALL BE AVAILABLE AT ALL TIMES DURING THE RAINY SEASON (NOVEMBER 1 TO APRIL 15). NECESSARY MATERIALS SHALL BE AVAILABLE ONSITE AND STOCKPILED AT CONVENIENT LOCATIONS TO FACILITATE RAPID CONSTRUCTION OF EMERGENCY DEVICES WHEN RAIN IS IMMINENT.
- 3. EROSION CONTROL DEVICES SHOWN ON THIS PLAN MAY BE REMOVED IF THE GRADING HAS PROGRESSED TO THE POINT WHERE THEY ARE NO LONGER REQUIRED. FOR FURTHER BMP IMPLEMENTATION DURATION, REFER TO PROVIDED SWPPP REPORT, SECTION 300.4.
- 4. GRADED AREAS ADJACENT TO FILL SLOPES LOCATED AT THE SITE PERIMETER MUST DRAIN AWAY FROM THE TOP OF SLOPE AT THE CONCLUSION OF EACH WORKING DAY. ALL LOOSE SOILS AND DEBRIS THAT MAY CREATE A POTENTIAL HAZARD TO OFF-SITE PROPERTY SHALL BE STABILIZED OR REMOVED FROM THE SITE ON A DAILY BASIS.
- 5. ALL SILT AND DEBRIS SHALL BE REMOVED FROM ALL DEVICES WITHIN 24 HOURS AFTER EACH RAINSTORM AND BE DISPOSED OF PROPERLY.
- 6. A GUARD SHALL BE POSTED ON THE SITE WHENEVER THE DEPTH OF WATER IN ANY DEVICE EXCEEDS TWO FEET. THE DEVICE SHALL BE DRAINED OR PUMPED DRY WITHIN 24 HOURS AFTER EACH RAINSTORM. PUMPING AND DRAINING OF ALL BASINS AND DRAINAGE DEVICES MUST COMPLY WITH THE APPROPRIATE BMP FOR DEWATERING OPERATIONS.
- 7. THE PLACEMENT OF ADDITIONAL DEVICES TO REDUCE EROSION DAMAGE AND CONTAIN POLLUTANTS WITHIN THE SITE IS LEFT TO THE DISCRETION OF THE CONTRACTOR. ADDITIONAL DEVICES AS NEEDED SHALL BE INSTALLED TO RETAIN SEDIMENTS AND OTHER POLLUTANTS ON SITE.
- 8. DESILTING BASINS MAY NOT BE REMOVED OR MADE INOPERABLE BETWEEN NOVEMBER 1 AND APRIL 15 OF THE FOLLOWING YEAR, UNLESS THE GRADING HAS PROGRESSED TO WHERE THEY ARE NO LONGER REQUIRED.

- 9. STORM WATER POLLUTION AND EROSION CONTROL DEVICES ARE TO BE MODIFIED, AS NEEDED, AS THE PROJECT PROGRESSES. THE DESIGN AND PLACEMENT OF THESE DEVICES IS THE RESPONSIBILITY OF THE CONTRACTOR.
- 10. EVERY EFFORT SHOULD BE MADE TO ELIMINATE THE DISCHARGE OF NONSTORM WATER FROM THE PROJECT SITES AT ALL TIMES.
- 11. ERODED SEDIMENTS AND OTHER POLLUTANTS MUST BE RETAINED ONSITE AND MAY NOT BE TRANSPORTED FROM THE SITE VIA SHEET FLOW, SWALES, AREA DRAINS, NATURAL DRAINAGE COURSES OR WIND.
- 12. STOCKPILES OF EARTH AND OTHER POLLUTANTS MUST BE RETAINED ONSITE AND MAY NOT BE TRANSPORTED FROM THE SITE BY THE FORCES OF WIND AND WATER.
- 13. FUELS, OILS, SOLVENTS AND OTHER TOXIC MATERIALS MUST BE STORED IN ACCORDANCE WITH THEIR LISTING AND ARE NOT TO CONTAMINATE THE SOILS AND SURFACE WATERS. ALL APPROVED STORAGE CONTAINERS ARE TO BE PROTECTED FROM THE WEATHER. SPILLS MUST BE CLEANED UP IMMEDIATELY AND DISPOSED OF IN A PROPER MANNER. SPILLS MAY NOT BE WASHED INTO THE DRAINAGE SYSTEM.
- 14. EXCESS OR WASTE CONCRETE MAY NOT BE WASHED INTO THE PUBLIC WAY OR ANY OTHER DRAINAGE SYSTEM. PROVISIONS SHALL BE MADE TO RETAIN CONCRETE WASTES ONSITE UNTIL THEY CAN BE DISPOSED OF AS SOLID WASTE.
- 15. THE CONTRACTORS ARE RESPONSIBLE TO INSPECT THAT ALL EROSION CONTROL DEVICE BMP's ARE INSTALLED AND FUNCTIONING PROPERLY IF THERE IS A 40% CHANCE OF 0.25 INCHES OR GREATER OF PREDICTED PRECIPITATION, AND AFTER ACTUAL PRECIPITATION. A CONSTRUCTION SITE INSPECTION CHECKLIST AND INSPECTION LOG SHALL BE MAINTAINED AT THE PROJECT SITE AT ALL TIMES AND AVAILABLE FOR REVIEW BY THE BUILDING OFFICIAL (COPIES OF THE SELF INSPECTION CHECK LIST AND INSPECTION LOGS ARE AVAILABLE UPON

- 16. TRASH AND CONSTRUCTION-RELATED SOLID WASTES MUST BE DEPOSITED INTO A COVERED RECEPTACLE TO PREVENT CONTAMINATION OR RAINWATER AND DISPERSAL BY WIND.
- 17. SEDIMENTS AND OTHER MATERIALS MAY NOT BE TRACKED FROM THE SITE BY VEHICULAR TRAFFIC. THE CONSTRUCTION ENTRANCE ROADWAYS MUST BE STABILIZED TO INHIBIT SEDIMENTS FROM BEING DEPOSITED INTO THE PUBLIC WAY. ACCIDENTAL DEPOSITIONS MUST BE SWEPT UP IMMEDIATELY AND MAY NOT BE WASHED DOWN BY RAIN OR OTHER MEANS.
- 18. ANY SLOPES WITH DISTURBED SOILS OR DENUDED OF VEGETATION MUST BE STABILIZED TO INHIBIT EROSION BY WIND AND WATER.
- 19. THE FOLLOWING BMP's FROM THE "CALIFORNIA STORM WATER BMP CONSTRUCTION HANDBOOK" - 2009, MUST BE IMPLEMENTED FOR ALL CONSTRUCTION ACTIVITIES AS APPLICABLE. BMP'S FROM THE "CALIFORNIA STORM WATER BMP HANDBOOK" - JANUARY 2003 MAY BE USED IF DETAIL IS INDICATED.
- 20. AS THE ARCHITECT/ENGINEER OF RECORD, I HAVE SELECTED APPROPRIATE BMPs TO EFFECTIVELY MINIMIZE THE NEGATIVE IMPACTS OF THE PROJECT'S CONSTRUCTION ACTIVITIES ON STORM WATER QUALITY. THE PROJECT OWNER AND CONTRACTOR ARE AWARE THAT THE SELECTED BMPs MUST BE INSTALLED, MONITORED, AND THE MAINTAINED TO ENSURE THEIR EFFECTIVENESS. THE BMPs NOT SELECTED FOR IMPLEMENTATION ARE REDUNDANT OR DEEMED NOT APPLICABLE TO THE PROPOSED CONSTRUCTION ACTIVITY.

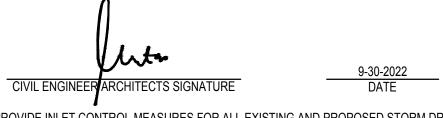

21. PROVIDE INLET CONTROL MEASURES FOR ALL EXISTING AND PROPOSED STORM DRAIN INLETS. GRAVEL BAGS (D1 PROTECTION TYPE 3) SHALL BE USED AS SPECIFIED PER SWPPP FOR INLET PROTECTION MEASURES.

#### **CONTRUCTION BMPs:**

#### **EROSION CONTROL**

- EC1 SCHEDULING EC2 - PRESERVATION OF EXISTING VEGETATION
- EC3 HYDRAULIC MULCH
- EC4 HYDROSEEDING
- EC5 SOIL BINDERS EC6 - STRAW MULCH
- EC7 GEOTEXTILES & MATS EC8 - WOOD MULCHING
- EC9 EARTH DIKES AND DRAINAGE SWALES EC10 - VELOCITY DISSIPATION DEVICES
- EC11 SLOPES DRAINS
- EC12 STREAMBANK STABILIZATION
- EC13 RESERVED EC14 - COMPOST BLANKETS
- EC15 SOIL PREPARATION/ROUGHENING EC16 - NON-VEGETATED STABILIZATION


#### TEMPORARY SEDIMENT CONTROL


- SE1 SILT FENCE
- SE2 SEDIMENT BASIN
- SE3 SEDIMENT TRAP SE4 - CHECK DAM
- SE5 FIBER ROLLS SE6 - GRAVEL BAG BERM
- SE7 STREET SWEEPING AND VACUUMING
- SE8 SANDBAG BARRIER
- SE9 STRAW BALE BARRIER
- SE10 STORM DRAIN INLET PROTECTION
- SE11 ACTIVE TREATMENT SYSTEMS SE12 - TEMPORARY SILT DIKE
- SE13 COMPOST SOCKS & BERMS
- SE14 BIOFILTER BAGS

#### WIND EROSION CONTROL

WE1 - WIND EROSION CONTROL

LEGEND:

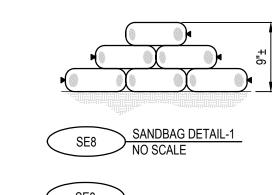

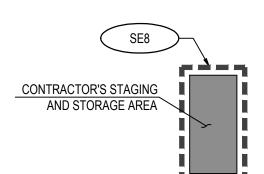

CONTRACTOR'S STAGING/STORAGE AREA. INCLUDE: WM-1 MATERIAL DELIVERY AND STORAGE, WM-2 MATERIAL USE, WM-3 STOCKPILE MANAGEMENT, WM-4 SPILL PREVENTION, WM-5 SOLID WASTE MANAGEMENT, WM-6 HAZARDOUS WASTE MANAGEMENT, WM-8 CONCRETE WASTE MANAGEMENT AND

WM-9 SANITARY/SEPTIC WASTE MANAGEMENT SANDBAG ENTIRE PERIMETER OF STAGING/STORAGE AREA.

#### **EQUIPMENT TRACKING CONTROL**

- TC1 STABILIZED CONSTRUCTION ENTRACE/EXIT
- TC3 ENTRANCE/OUTLET TIRE WASH

- NS6 ILLICIT CONNECTION/DISCHARGE
- NS9 VEHICLE AND EQUIPMENT FUELING
- NS11 PILE DRIVING OPERATIONS
- NS13 CONCRETE FINISHING
- NS14 MATERIAL AND EQUIPMENT USE
- NS15 DEMOLITION ADJACENT TO WATER NS16 - TEMPORARY BATCH PLANTS

- WM2 MATERIAL USE
- WM3 STOCKPILE MANAGEMENT WM4 - SPILL PREVENTION AND CONTROL
- WM5 SOLID WASTE MANAGEMENT
- WM6 HAZARDOUS WASTE MANAGEMENT
- WM7 CONTAMINATION SOIL MANAGEMENT
- WM8 CONCRETE WASTE MANAGEMENT
- WM10 -LIQUID WASTE MANAGEMENT

## ARCHITECT:

**Partnership** 

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**Abode Communities** 1149 S. Hill Street, Suite 700 Los Angeles, CA 90015 T: 213.629.2702

1541 Wilshire Blvd., Suite 200

Los Angeles, CA 90017

**IDENTIFICATION STAMP** DIV. OF THE STATE ARCHITEC

REVIEWED FOR

SS 🗹 FLS 🗹 ACS 🗹

APP: 03-122151 INC:

DATE: 11/02/2022

abode

**LAEP EARLY** 

13928 KORNBLUM AVE.

HAWTHORNE, CA 90250

communities

architecture

**CHILDHOOD CENTER** 

**CONSULTANTS:** 

**Breen Engineering** 1983 W. 190th St., Suite 200

Torrance, CA 90504 T: 310.464.8404


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**STRUCTURAL Breen Engineering** 1983 W. 190th St., Suite 200 Torrance, CA 90504 T: 310.464.8404

### DSA APPLICATION NUMBER: 03-122151

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DATE REV PROGRESS SET 02.01.22 DSA PROGRESS SET 03.02.22 DSA APPLICATION SET 04.01.22

SHEET NAME:

DSA BACK-CHECK SET 10.05.22

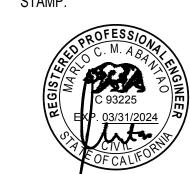DSA BACK-CHECK SET 10.24.22

**EROSION** 

SHEET NUMBER:



#### TEMPORARY SEDIMENT CONTROL


- NS1 WATER CONSERVATION PRACTICES NS2 - DEWATERING OPERATIONS
- NS3 PAVING AND GRINDING OPERATIONS NS4 - TEMPORARY STREAM CROSSING
- NS5 CLEAR WATER DISVERSION
- NS7 POTABLE WATER/IRRIGATION NS8 - VEHICLE AND EQUIPMENT CLEANING
- NS10 VEHICLE AND EQUIPMENT MAINTENANCE
- NS12 CONCRETE CURING

#### CLIENT: **Los Angeles Education** WATER MANAGEMENT & MATERIAL POLLUTION CONTROL

- WM1 MATERIAL DELIVERY

GRAPHIC SCALE: 1"=20'

WM9 - SANITARY/SEPTIC WASTE MANAGEMENT

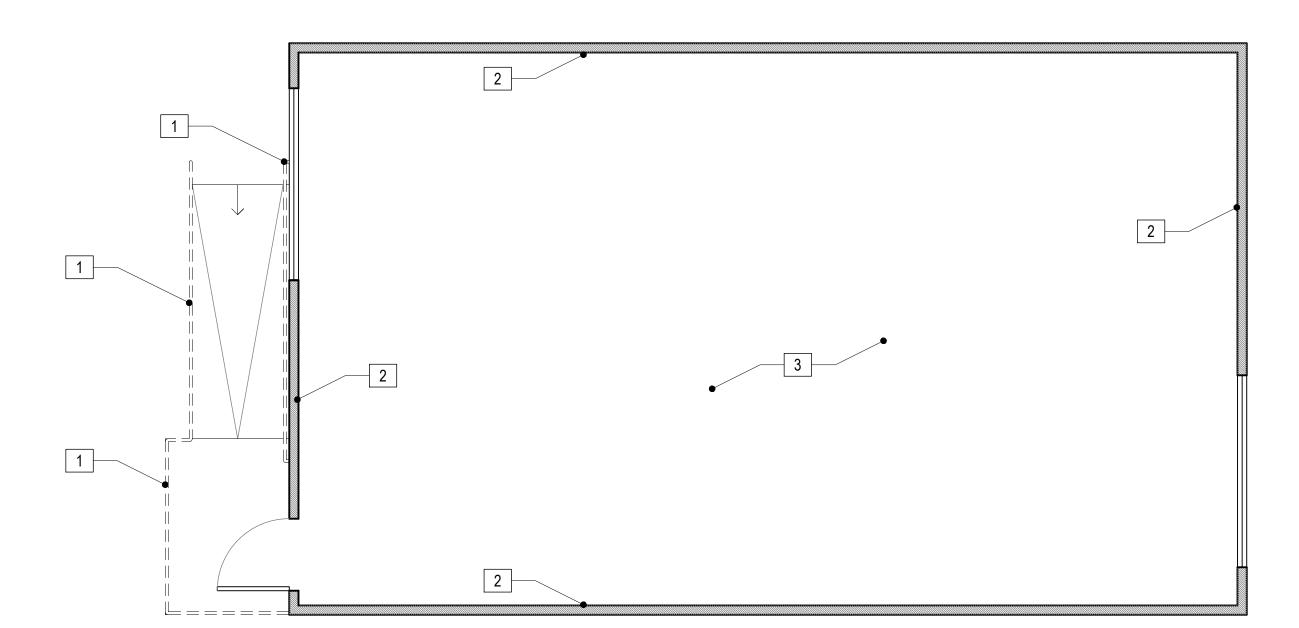

BUNGALOW 01 DEMOLITION PLAN

SCALE: 1/4" = 1'-0"





#### **DEMOLITION NOTES**

- 1. ALL EXISTING DIMENSIONS AND SQUARE FOOTAGE AMOUNTS ARE APPROXIMATE. CONTRACTOR TO VERIFY IN FIELD
- 2. STORE AND MAINTAIN EXISTING CEILING TILES FOR USE IN PROJECT
- 3. PATCH AND FILL ALL OPENINGS AND EXISTING WALLS DUE TO REMOVED WORK
- 4. REMOVE ALL FLOORING, REPAIR AND SMOOTH FLOOR WHERE
- REMOVE ALL EXISTING ELECTRICAL FIXTURES WHERE NEEDED
  - REMOVE ALL LIGHT FIXTURES FOR REPLACEMENT
- 7. VERIFY EXISTING RAMP SLOPE AND REPAIR WHERE NEEDED

#### LEGEND

EXISTING WALL TO BE REMAIN

---- FEATURE TO BE REMOVED

IDENTIFICATION STAMP DIV. OF THE STATE ARCHITECT APP: 03-122151 INC: REVIEWED FOR SS 🗹 FLS 🗹 ACS 🗹 DATE: 11/02/2022

# abode communities architecture

PROJECT:

#### LAEP EARLY CHILDHOOD CENTER

13928 KORNBLUM AVE. HAWTHORNE, CA 90250

CLIENT:

#### **Los Angeles Education** Partnership 1541 Wilshire Blvd., Suite 200 Los Angeles, CA 90017 T: 213.622.5237

ARCHITECT:

**Abode Communities** 1149 S. Hill Street, Suite 700 Los Angeles, CA 90015 T: 213.629.2702

CONSULTANTS:

**Breen Engineering** 1983 W. 190th St., Suite 200 Torrance, CA 90504 T: 310.464.8404 MECHANICAL/ ELECTRICAL/ PLUMBING

**Breen Engineering** 1983 W. 190th St., Suite 200 Torrance, CA 90504 T: 310.464.8404 **STRUCTURAL Breen Engineering** 1983 W. 190th St., Suite 200


Torrance, CA 90504 T: 310.464.8404

### **KEYNOTES**

- 1 REMOVE (E) TOP RAIL AND HANDRAIL
- REMOVE (E) VINYL TACKBOARD OVER GYP. BOARD BACKING FOR REPLACEMENT WITH DRYWALL (TYP.)
- 3 REMOVE (E) CARPET FLOORING

#### DSA APPLICATION NUMBER: 03-122151


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DSA BACK-CHECK SET	10.05.22	
DSA BACK-CHECK SET	10.24.22	
DSA BACK-CHECK SET	11.01.22	

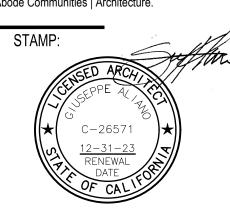SHEET NAME: **BUNGALOW 01 DEMOLITION PLAN** 

SHEET NUMBER:



BUNGALOW 02 DEMOLITION PLAN

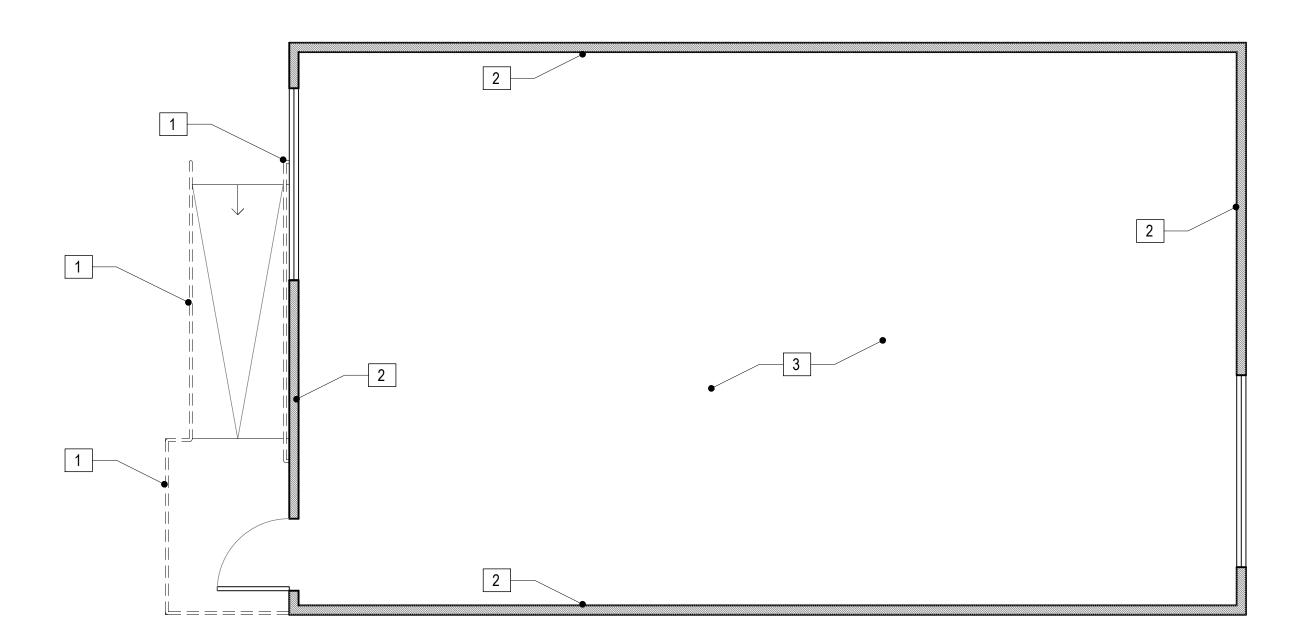SCALE: 1/4" = 1'-0"





#### **DEMOLITION NOTES**

- 1. ALL EXISTING DIMENSIONS AND SQUARE FOOTAGE AMOUNTS ARE APPROXIMATE. CONTRACTOR TO VERIFY IN FIELD
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- REMOVE ALL EXISTING ELECTRICAL FIXTURES WHERE NEEDED
- REMOVE ALL LIGHT FIXTURES FOR REPLACEMENT
- 7. VERIFY EXISTING RAMP SLOPE AND REPAIR WHERE NEEDED

#### LEGEND

EXISTING WALL TO BE REMAIN

---- FEATURE TO BE REMOVED

IDENTIFICATION STAMP DIV. OF THE STATE ARCHITECT APP: 03-122151 INC: REVIEWED FOR SS 🗹 FLS 🗹 ACS 🗹 DATE: 11/02/2022

## abode communities architecture

PROJECT:

#### LAEP EARLY CHILDHOOD CENTER

13928 KORNBLUM AVE. HAWTHORNE, CA 90250

CLIENT:

#### **Los Angeles Education** Partnership 1541 Wilshire Blvd., Suite 200 Los Angeles, CA 90017 T: 213.622.5237

ARCHITECT:

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CONSULTANTS:

**Breen Engineering** 1983 W. 190th St., Suite 200 Torrance, CA 90504 T: 310.464.8404 MECHANICAL/

ELECTRICAL/ PLUMBING **Breen Engineering** 1983 W. 190th St., Suite 200 Torrance, CA 90504 T: 310.464.8404 **STRUCTURAL** 


**Breen Engineering** 1983 W. 190th St., Suite 200 Torrance, CA 90504 T: 310.464.8404

### **KEYNOTES**

- 1 REMOVE (E) TOP RAIL AND HANDRAIL
- REMOVE (E) VINYL TACKBOARD OVER GYP. BOARD BACKING FOR REPLACEMENT WITH DRYWALL (TYP.)
- 3 REMOVE (E) CARPET FLOORING

#### DSA APPLICATION NUMBER: 03-122151


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DSA PROGRESS SET	03.02.22	
DSA APPLICATION SET	04.01.22	
DSA BACK-CHECK SET	10.05.22	
DSA BACK-CHECK SET	10.24.22	
DSA BACK-CHECK SET	11.01.22	

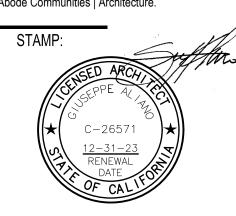SHEET NAME: **BUNGALOW 02 DEMOLITION PLAN** 

SHEET NUMBER:



BUNGALOW 03 DEMOLITION PLAN

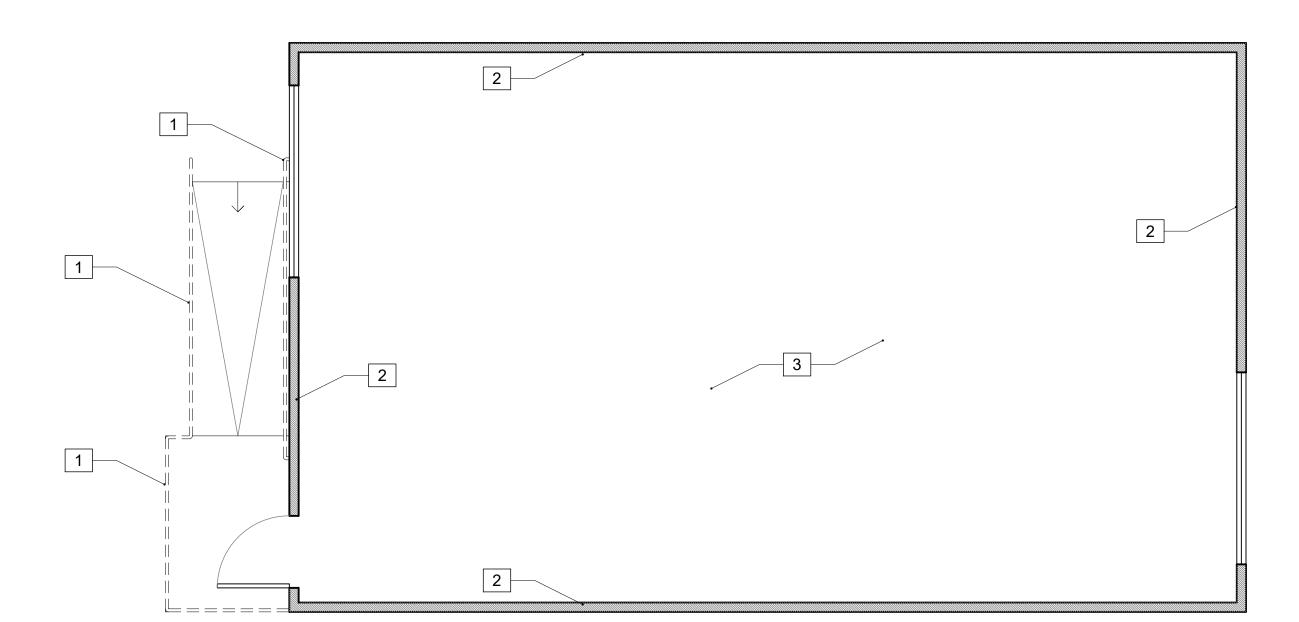SCALE: 1/4" = 1'-0"





#### **DEMOLITION NOTES**

- 1. ALL EXISTING DIMENSIONS AND SQUARE FOOTAGE AMOUNTS ARE APPROXIMATE. CONTRACTOR TO VERIFY IN FIELD
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- 4. REMOVE ALL FLOORING, REPAIR AND SMOOTH FLOOR WHERE
- REMOVE ALL EXISTING ELECTRICAL FIXTURES WHERE NEEDED
  - REMOVE ALL LIGHT FIXTURES FOR REPLACEMENT
- 7. VERIFY EXISTING RAMP SLOPE AND REPAIR WHERE NEEDED

#### LEGEND

EXISTING WALL TO BE REMAIN

---- FEATURE TO BE REMOVED

IDENTIFICATION STAMP DIV. OF THE STATE ARCHITECT APP: 03-122151 INC: REVIEWED FOR SS 🗹 FLS 🗹 ACS 🗹 DATE: 11/02/2022

## abode communities architecture

PROJECT:

#### LAEP EARLY CHILDHOOD CENTER

13928 KORNBLUM AVE. HAWTHORNE, CA 90250

CLIENT:

#### Los Angeles Education Partnership 1541 Wilshire Blvd., Suite 200 Los Angeles, CA 90017

ARCHITECT:

T: 213.622.5237

**Abode Communities** 1149 S. Hill Street, Suite 700 Los Angeles, CA 90015 T: 213.629.2702

CONSULTANTS:

**Breen Engineering** 1983 W. 190th St., Suite 200 Torrance, CA 90504 T: 310.464.8404 MECHANICAL/

**Breen Engineering** 1983 W. 190th St., Suite 200 Torrance, CA 90504 T: 310.464.8404 **STRUCTURAL** 

ELECTRICAL/ PLUMBING


**Breen Engineering** 1983 W. 190th St., Suite 200 Torrance, CA 90504 T: 310.464.8404

#### **KEYNOTES**

- 1 REMOVE (E) TOP RAIL AND HANDRAIL
- REMOVE (E) VINYL TACKBOARD OVER GYP. BOARD BACKING FOR REPLACEMENT WITH DRYWALL (TYP.)
- 3 REMOVE (E) CARPET FLOORING

#### DSA APPLICATION NUMBER: 03-122151


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> SHEET NAME: **BUNGALOW 03 DEMOLITION PLAN**

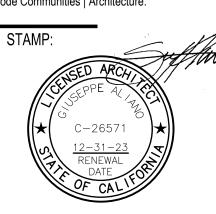SHEET NUMBER:



BUNGALOW 04 DEMOLITION PLAN

SCALE: 1/4" = 1'-0"

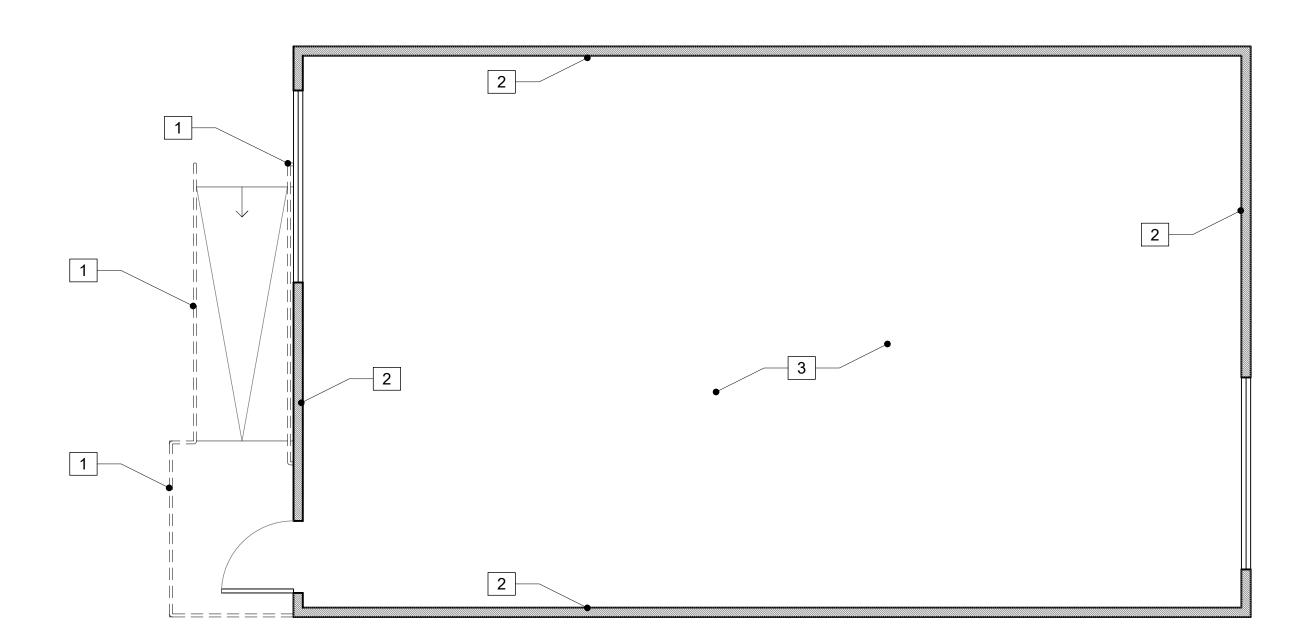



#### **DEMOLITION NOTES**

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#### LEGEND

EXISTING WALL TO BE REMAIN

---- FEATURE TO BE REMOVED

IDENTIFICATION STAMP DIV. OF THE STATE ARCHITECT APP: 03-122151 INC: REVIEWED FOR SS 🗹 FLS 🗹 ACS 🗹 DATE: 11/02/2022

## abode communities architecture

PROJECT:

#### LAEP EARLY CHILDHOOD CENTER

13928 KORNBLUM AVE. HAWTHORNE, CA 90250

CLIENT:

#### Los Angeles Education **Partnership**

1541 Wilshire Blvd., Suite 200 Los Angeles, CA 90017 T: 213.622.5237

ARCHITECT:

CONSULTANTS:

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ELECTRICAL/ PLUMBING **Breen Engineering** 1983 W. 190th St., Suite 200 Torrance, CA 90504 T: 310.464.8404


**STRUCTURAL Breen Engineering** 1983 W. 190th St., Suite 200 Torrance, CA 90504 T: 310.464.8404

#### **KEYNOTES**

- 1 REMOVE (E) TOP RAIL AND HANDRAIL
- REMOVE (E) VINYL TACKBOARD OVER GYP. BOARD BACKING FOR REPLACEMENT WITH DRYWALL (TYP.)
- 3 REMOVE (E) CARPET FLOORING

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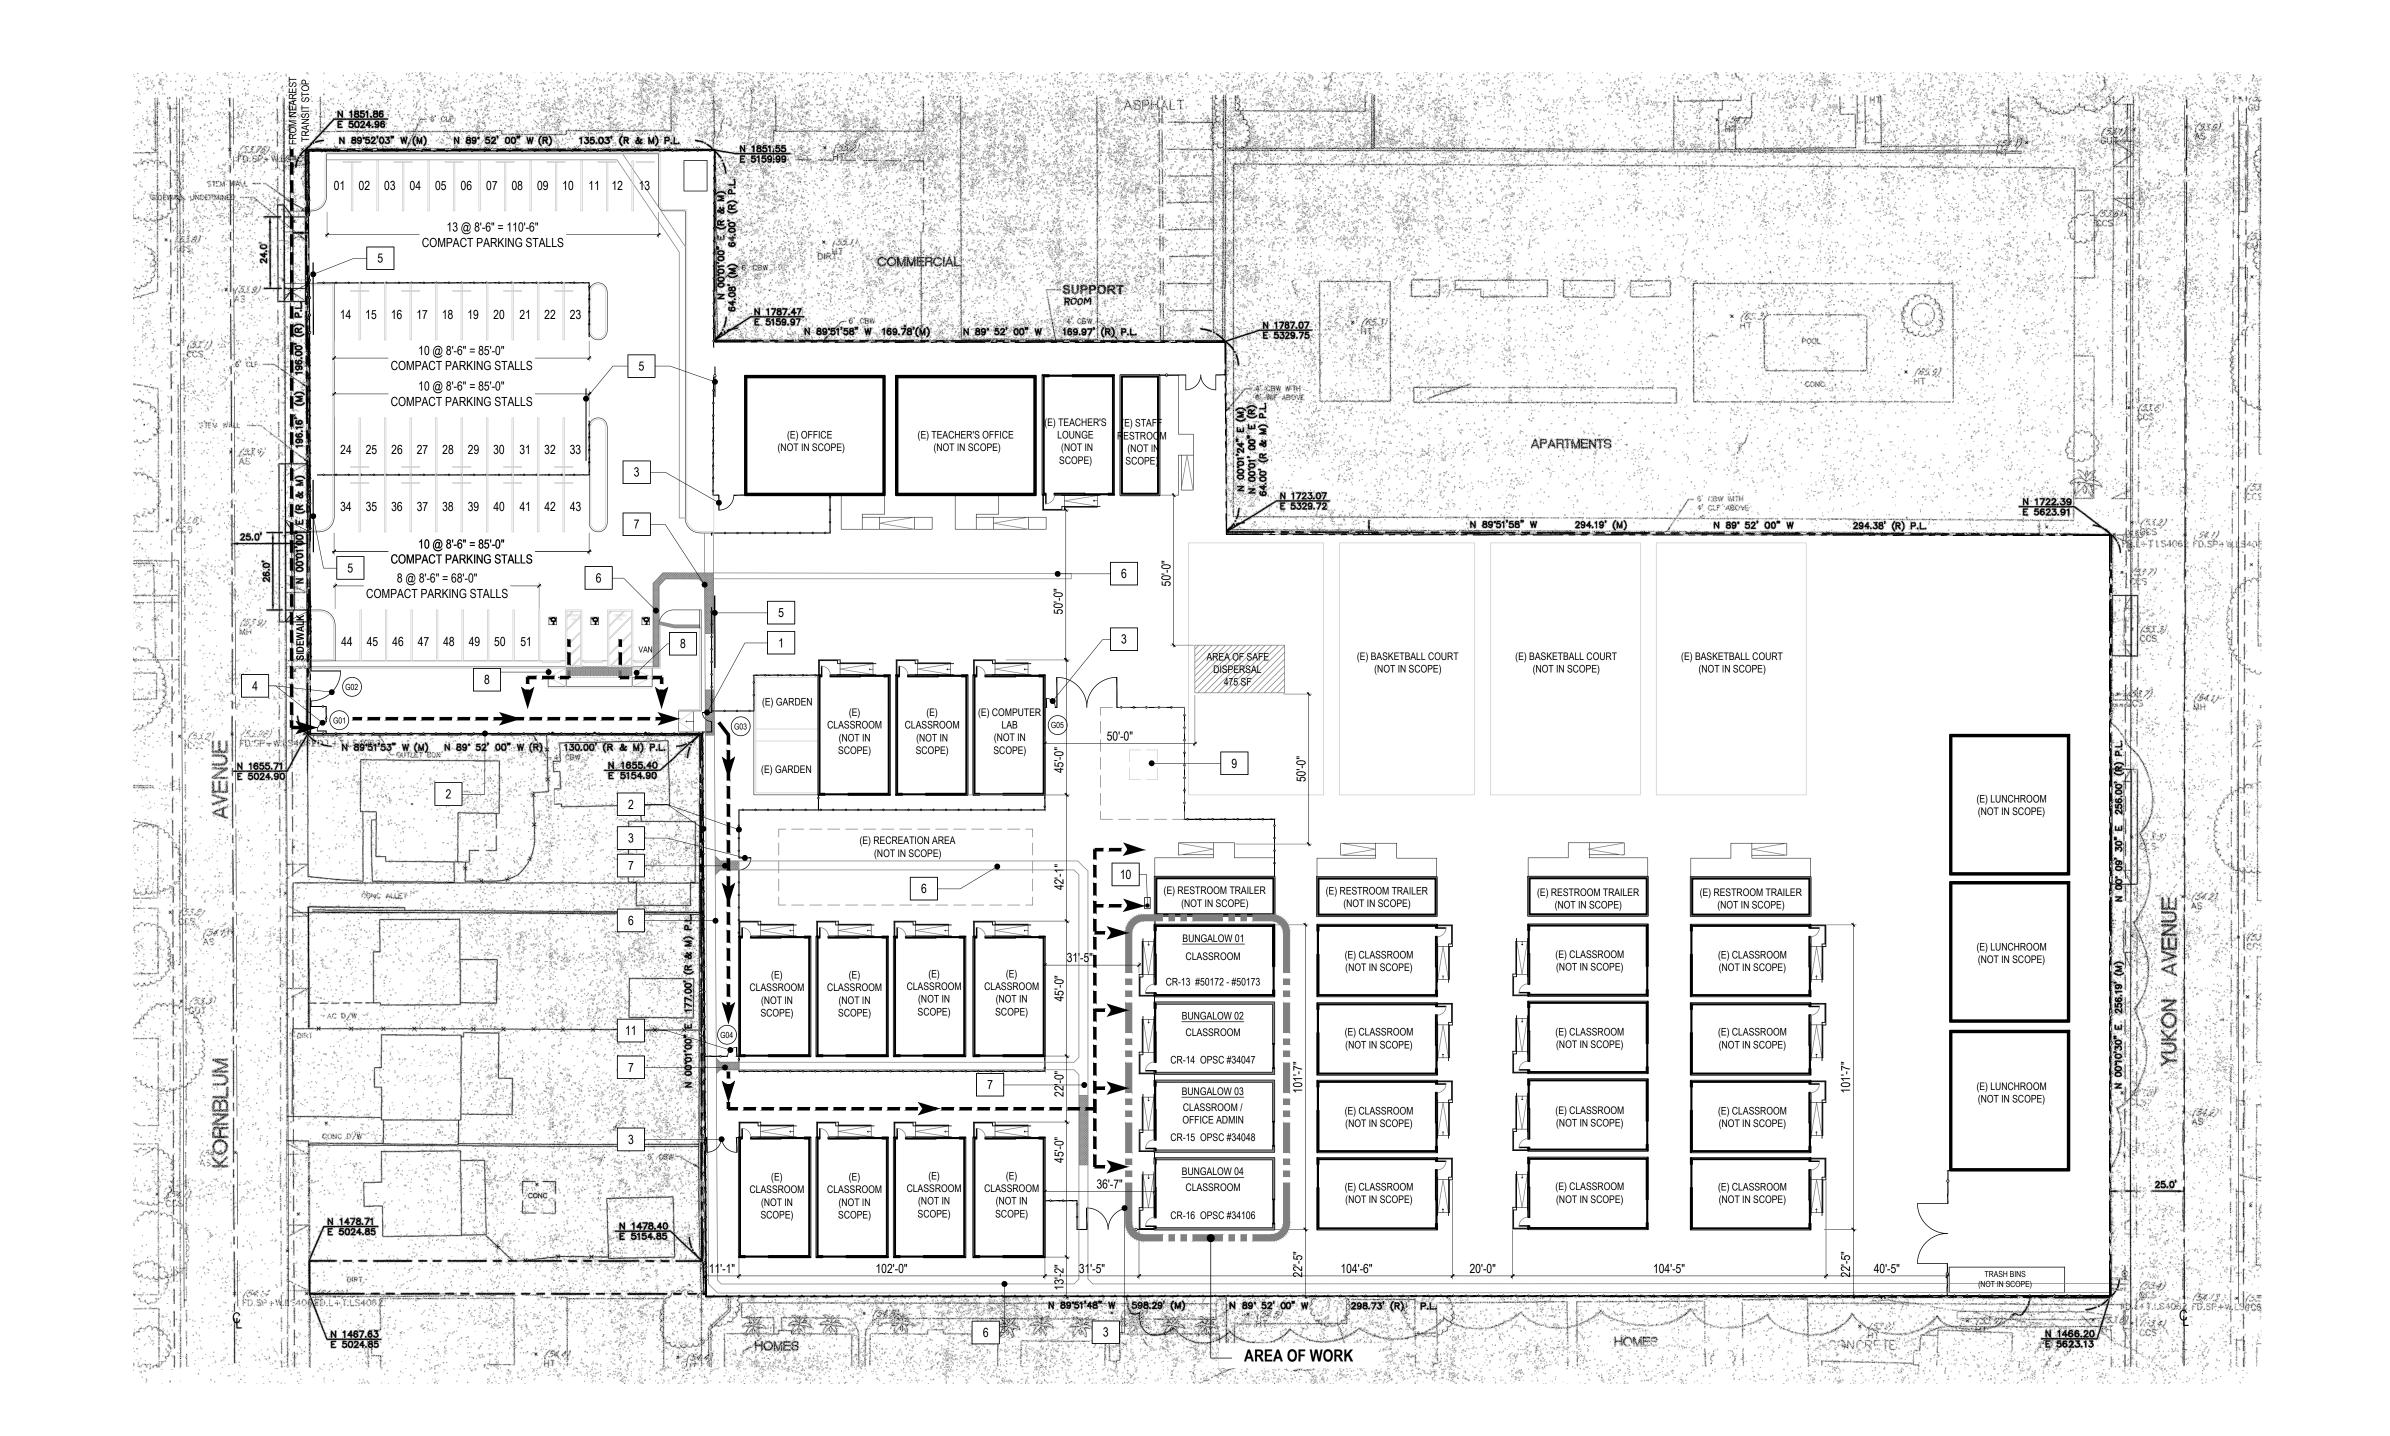
DATE REV

PROGRESS SET 02.01.22 DSA PROGRESS SET 03.02.22 DSA APPLICATION SET 04.01.22 DSA BACK-CHECK SET 10.05.22 DSA BACK-CHECK SET 10.24.22

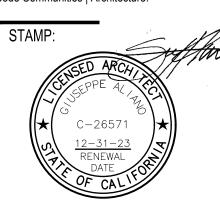DSA BACK-CHECK SET 11.01.22

SHEET NAME: **BUNGALOW 04 DEMOLITION PLAN** 

SHEET NUMBER:



SITE PLAN
SCALE: NOT TO SCALE






#### **KEYNOTES**

1	MAIN ENTRY GATE, PROVIDE PANIC HARDWARE
2	EXISTING 8 FT HIGH FENCE
3	EXISTING GATE W/ PANIC HARDWARE
4	NEW GATE - PROVIDE PANIC HARDWARE AS NEEDED
5	EXISTING SLIDING GATE
6	EXISTING V-GUTTER, REFER TO AS-BUILTS, SHEET C16
7	NEW CONCRETE SLAB, REFER TO CIVIL DRAWINGS
8	NEW RAMP, REFER TO SHEET A10.05
9	EXISTING PLAYGROUND STRUCTURE (NOT IN SCOPE)
10	EXISTING HI-LO DRINKING FOUNTAIN
11	EXISTING GATE - PROVIDE PANIC HARDWARE

#### **LEGEND**

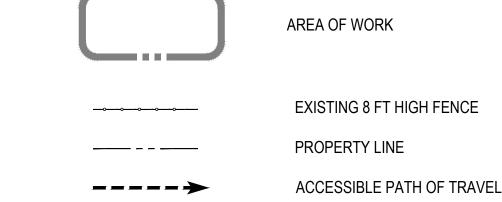

## DESIGN PROFESSIONAL IN GENERAL RESPONSIBLE CHARGE STATEMENT:

"THE PATH OF TRAVEL (POT) IDENTIFIED IN THESE CONSTRUCTION DOCUMENTS MEETS THE REQUIREMENTS OF THE CURRENT APPLICABLE CALIFORNIA BUILDING CODE (CBC) ACCESSIBILITY PROVISIONS FOR PATH OF TRAVEL REQUIREMENTS FOR ALTERATIONS, ADDITIONS AND STRUCTURAL REPAIRS. AS PART O ELEMENTS, COMPONENTS OR PORTIONS OF THE POT THAT WERE DETERMINED TO BE NONCOMPLIANT WITH THE CBC HAVE BEEN IDENTIFIED AND THE CORRECTIVE WORK NECESSARY TO BRING THEM INTO COMPLIANCE HAS BEEN INCLUDED WITHIN THE SCOPE OF THIS PROJECT'S WORK THROUGH DETAILS, DRAWINGS AND SPECIFICATIONS INCORPORATED INTO THESE CONSTRUCTION DOCUMENTS. ANY NONCOMPLIANT ELEMENTS, COMPONENTS OR PORTIONS OF THE POT THAT WILL NOT BE CORRECTED IN THIS PROJECT BASED ON VALUATION THRESHOLD LIMITATIONS OR A FINDING OF UNREASONABLE HARDSHIP ARE INDICATED IN THESE CONSTRUCTION DOCUMENTS.

DURING CONSTRUCTION, IF POT ITEMS WITHIN THE SCOPE OF THE PROJECT REPRESENTED AS CBC COMPLIANT ARE FOUND TO BE NONCONFORMING BEYOND REASONABLE CONSTRUCTION TOLERANCES, THE ITEMS SHALL BE BROUGHT INTO COMPLIANCE WITH THE CBC AS A PART OF THIS PROJECT BY MEANS OF A CONSTRUCTION CHANGE DOCUMENT."

#### NOTES

- 1. ACCESSIBLE PATH OF TRAVEL AS INDICATED ON PLAN IS A BARRIER-FREE ACCESS ROUTE WITHOUT ANY ABRUPT LEVEL CHANGES EXCEEDING 1/2" IF BEVELED AT 1:2 MAX SLOPE, OR VERTICAL LEVEL CHANGES NOT EXCEEDING 1/4" MAX, AND AT LEAST 48" IN WIDTH. SURFACE IS TABLE, FIRM, AND SLIP RESISTANT. CROSS SLOPE DOES NOT EXCEED 2% AND SLOPE IN THE DIRECTION OF TRAVEL IS LESS THAN 5%, UNLESS OTHERWISE INDICATED. ACCESSIBLE PATH OF TRAVEL SHALL BE MAINTAINED FREE OF OVERHANGING OBSTRUCTIONS TO 80" MINIMUM, AND PROTRUDING OBJECTS GREATER THAN 4" PROJECTION FROM WALL AND ABOVE 27" AND LESS THAN 80".
- AREA OF SAFE DISPERSAL: AREA SHALL BE PERMANENTLY MAINTAINED AND IDENTIFIED AS A SAFE DISPERSAL AREA.

IDENTIFICATION STAMP DIV. OF THE STATE ARCHITECT APP: 03-122151 INC:

REVIEWED FOR

SS FLS ACS DATE: 11/02/2022

# abode communities architecture

PROJECT:

# LAEP EARLY CHILDHOOD CENTER

13928 KORNBLUM AVE. HAWTHORNE, CA 90250

LIENT:

Los Angeles Education Partnership 1541 Wilshire Blvd., Suite 200 Los Angeles, CA 90017 T: 213.622.5237

ARCHITECT:

Abode Communities 1149 S. Hill Street, Suite 700 Los Angeles, CA 90015 T: 213.629.2702

CONSULTANTS:

Breen Engineering
1983 W. 190th St., Suite 200
Torrance, CA 90504
T: 310.464.8404


MECHANICAL/ ELECTRICAL/ PLUMBING Breen Engineering 1983 W. 190th St., Suite 200 Torrance, CA 90504 T: 310.464.8404

STRUCTURAL

Breen Engineering
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#### DSA APPLICATION NUMBER: 03-122151

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DATE REV
PROGRESS SET 02.01.22
DSA PROGRESS SET 03.02.22
DSA APPLICATION SET 04.01.22
DSA BACK-CHECK SET 10.05.22
DSA BACK-CHECK SET 10.24.22
DSA BACK-CHECK SET 11.01.22

SHEET NAME:

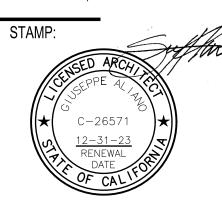SITE PLAN

SHEET NUMBER:
A1.00

BUILDING AREA SUMMARY							
BUNGALOW	CONSTR. TYPE	GROUP	DESCRIPTION	GROSS AREA SF			
01	V-B	1-4	CLASSROOM (INFANT: 0-12 MONTHS)	960			
02	V-B	1-4	CLASSROOM (INFANT/MOBILE: 0-12 MONTHS)	960			
03	V-B	1-4	CLASSROOM 1 (1-2 YEARS)	960			
04	V-B	E	CLASSROOM 2 (2-3 YEARS)	960			
05	V-B	E	RESTROOM (NOT IN SCOPE)	480			
06	V-B	E	RESTROOM (NOT IN SCOPE)	480			
07	V-B	E	CLASSROOM (NOT IN SCOPE)	960			
08	V-B	E	CLASSROOM (NOT IN SCOPE)	960			
09	V-B	E	CLASSROOM (NOT IN SCOPE)	960			
10	V-B	E	CLASSROOM (NOT IN SCOPE)	960			
			TOTAL	8640*			

N 89'52'03" W/(M) N 89' 52' 00" W (R) 135.03' (R & M) P.L.

COMPACT PARKING STALLS

COMPACT PARKING STALLS

10 @ 8'-6" = 85'-0"

10 @ 8'-6" = 85'-0"

N 89'51'53" W (M) N 89' 52' 00" W (R) 130.00' (R ... M) P.L.

8 @ 8'-6" = 68'-0"

CONG ALLEP

AC D/W

CONC D/W

Commence of the commence of th

<sup>\*</sup> BUILDING CLUSTER TOTAL AREA IS BELOW 9,000 SF (TYPE V-B, NON-SPRINKLERED I-4, NON-SEPARATED OCCUPANCIES PER CBC 508.3).

	00	CUPANT LOAD PER TA	BLE 1004	1.5			OCCUPANT LOAD SUMMARY - BUN
BUNGALOW	CONSTR. TYPE	NAME	AREA	OCC. TYPE	OCC. LOAD FACTOR	OCC.	KITCHEN CLASSROOM
						LOAD	CHILD RESTROOM
		KITCHEN	258 SF	I-4	35	08	LAUNDRY ROOM
		LAUNDRY	53 SF	I-4	35	02	TOTAL OCCUPANT LOAD
01	V-B	CHILD RESTROOM	61 SF	I-4	35	02	
		CLASSROOM	382 SF	1-4	35	11	EGRESS WIDTH CALCULATIONS
			850 SF	) SF		23	CORRIDOR WIDTH CALCULATION
							(SECTION 1005.3.1 & 1005.3.2 EGRESS WIDTH
	V-B	WORK AREA	267 SF	I-4	35	08	23 x 0.2 = 4.6
02		CHILD RESTROOM	61 SF	I-4	35	02	THEREFORE MIN. CORRIDOR WIDTH = 44"
02		CLASSROOM	441 SF	I-4	35	13	
			864 SF			23	
	V-B	OFFICE / ADMIN	248 SF	В	150	02	OCCUPANT LOAD SUMMARY - BUN
		CHILD RESTROOM	61 SF	1-4	35	02	WORK AREA
		ADULT RESTROOM	52 SF	1-4	35	02	CHILD RESTROOM
03		CLASSROOM	402 SF	1-4	35	12	CLASSROOM
		CLASSROOM	1	1-4	35	12	TOTAL OCCUPANT LOAD
			853 SF			18	
	V-B	OFFICE	101 SF	В	150	01	EGRESS WIDTH CALCULATIONS
		FILE ROOM	58 SF	В	150	01	CORRIDOR WIDTH CALCULATION
		CONFERENCE ROOM	80 SF	В	150	01	(SECTION 1005.3.1 & 1005.3.2 EGRESS WIDTH
04		CHILD RESTROOM	61 SF	Е	20	04	23 x 0.2 = 4.6
		CLASSROOM	462 SF	Е	20	24	THEREFORE MIN. CORRIDOR WIDTH = 44"
			852 SF			31	
	1		TOT	AL CAPA	CITY 95 PE	RSONS	

N 89°51'58" W 169.78'(M) N 89° 52' 00" W \ 169.97' (R) P.L.

(E) TEACHER'S OFFICE

(NOT IN SCOPE)

(NOT IN SCOPE)

**《-----**

(NOT IN SCOPE)

(NOT IN SCOPE)

(E) CLASSROOM (NOT IN SCOPE)

NOT IN SCOPE)

(NOT IN SCOPE)

(NOT IN SCOPE)

(E) CLASSROOM (NOT IN SCOPE)

(E) RECREATION AREA (NOT IN SCOPE)

(NOT IN SCOPI

(NOT IN SCOPE)

(E) CLASSROOM (NOT IN SCOPE)

(E)TEACHER'S

(NOT IN SCOP

784

DISPERSAL 475.8F

BUNGALOW 5 (E) RESTROOM TRAILER (NOT IN SCOPE)

BUNGALOW 01

BUNGALOW 02

BUNGALOW 03

E 852 SF 20 30 1

N 89'51'48" W 598:29' (M) N 89' 52' 00" W 298.73' (R) P.L.

I-4 850 SF 35 23 1

OCCUPANT LOAD SUMMARY - BUNGALOW 0	1					
KITCHEN	30					
CLASSROOM	02					
CHILD RESTROOM	02					
LAUNDRY ROOM	1					
TOTAL OCCUPANT LOAD	23					
EGRESS WIDTH CALCULATIONS						
CORRIDOR WIDTH CALCULATION						
(SECTION 1005.3.1 & 1005.3.2 EGRESS WIDTH PER OCCUPANT SERVED)						
23 x 0.2 = 4.6						
THEREFORE MIN. CORRIDOR WIDTH = 44"						
THERE OILE WIIN. CONTRIDOR WIDTH - TT						
THERE ONE WIN. CONTRIDOR WIDTH - 11						
OCCUPANT LOAD SUMMARY - BUNGALOW 0	2					
	<b>2</b>					
OCCUPANT LOAD SUMMARY - BUNGALOW 0	30					
OCCUPANT LOAD SUMMARY - BUNGALOW 0 WORK AREA CHILD RESTROOM	08					
OCCUPANT LOAD SUMMARY - BUNGALOW 0 WORK AREA	08 02 14					
OCCUPANT LOAD SUMMARY - BUNGALOW 0 WORK AREA CHILD RESTROOM CLASSROOM	08 02 14					
OCCUPANT LOAD SUMMARY - BUNGALOW 0 WORK AREA CHILD RESTROOM CLASSROOM TOTAL OCCUPANT LOAD						
OCCUPANT LOAD SUMMARY - BUNGALOW O WORK AREA CHILD RESTROOM CLASSROOM TOTAL OCCUPANT LOAD  EGRESS WIDTH CALCULATIONS	08 02 14 23					

OFFICE	02					
ADULT RESTROOM	02					
CHILD RESTROOM	02					
CLASSROOM	12					
TOTAL OCCUPANT LOAD						
EGRESS WIDTH CALCULATIONS						
CORRIDOR WIDTH CALCULATION						
(SECTION 1005.3.1 & 1005.3.2 EGRESS WIDTH PER OCCUPANT SERVED)						
18 x 0.2 = 3.6						
18 x 0.2 = 3.6  THEREFORE MIN. CORRIDOR WIDTH = 44"						
	LOW 04					
THEREFORE MIN. CORRIDOR WIDTH = 44"  OCCUPANT LOAD SUMMARY - BUNGA						
THEREFORE MIN. CORRIDOR WIDTH = 44"  OCCUPANT LOAD SUMMARY - BUNGA  OFFICE	01					
THEREFORE MIN. CORRIDOR WIDTH = 44"  OCCUPANT LOAD SUMMARY - BUNGA  OFFICE	01					
THEREFORE MIN. CORRIDOR WIDTH = 44"  OCCUPANT LOAD SUMMARY - BUNGA  OFFICE  FILE ROOM	01 01 01 03					

(SECTION 1005.3.1 & 1005.3.2 EGRESS WIDTH PER OCCUPANT SERVED)

POOL.

COMO

TOTAL OCCUPANT LOAD

30 x 0.2 = 6

**APARTMENTS** 

N 89'51'58" W 294.19' (M)

(E) BASKETBALL COURT (NOT IN SCOPE)

(E) RESTROOM TRAILER

(NOT IN SCOPE)

(E) CLASSROOM

(E) CLASSROOM (NOT IN SCOPE)

BUILDING CLUSTER TOTAL AREA IS BELOW 9,000 SF (TYPE V-B, NON-SPRINKERED I-4, NON-SEPARATED OCCUPANCIES PER 508.3)

(E) BASKETBALL COURT (NOT IN SCOPE)

BUNGALOW 6 (E) RESTROOM TRAILER (NOT IN SCOPE)

BUNGALOW 7 (E) CLASSROOM (NOT IN SCOPE)

BUNGALOW 9 (E) CLASSROOM (NOT IN SCOPE)

—BUILDING CLUSTER:

**EGRESS WIDTH CALCULATIONS** 

THEREFORE MIN. CORRIDOR WIDTH = 44"

6 CBW WITH 4 CLF ABOVE

(E) BASKETBALL COURT (NOT IN SCOPE)

N 89° 52' 00" W

(E) RESTROOM TRAILER

(NOT IN SCOPE)

(E) CLASSROOM


(E) CLASSROOM (NOT IN SCOPE)


(E) CLASSROOM


(NOT IN SCOPE)

(E) CLASSROOM (NOT IN SCOPE)

CORRIDOR WIDTH CALCULATION

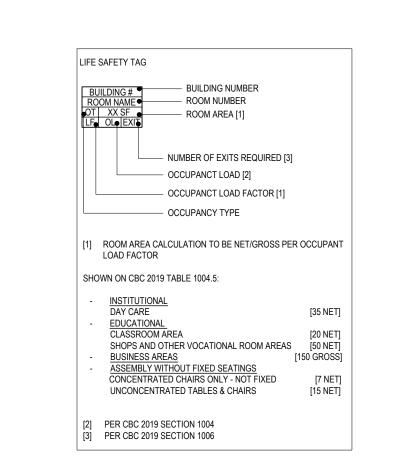

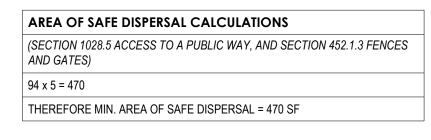

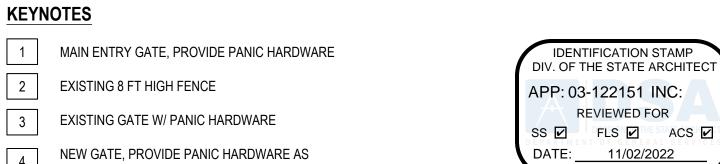

NEEDED

SHEET C16

DRAWINGS

SCOPE)

**LEGEND** 

\_\_\_\_

EXISTING SLIDING GATE

EXISTING V-GUTTER, REFER TO AS-BUILTS,

NEW CONCRETE SLAB, REFER TO CIVIL

NEW RAMP, REFER TO SHEET A10.05

EXISTING HI-LO DRINKING FOUNTAIN

EXISTING PLAYGROUND STRUCTURE (NOT IN

EXISTING GATE - PROVIDE PANIC HARDWARE

BUILDING DISCHARGE LOAD

AREA OF WORK

CHAIN LINK FENCE

DESIGN PROFESSIONAL IN GENERAL RESPONSIBLE CHARGE STATEMENT:

DOCUMENTS MEETS THE REQUIREMENTS OF THE CURRENT APPLICABLE

STRUCTURAL REPAIRS. AS PART OF THE DESIGN OF THIS PROJECT, THE

POT WAS EXAMINED AND ANY ELEMENTS, COMPONENTS OR PORTIONS

OF THE POT THAT WERE DETERMINED TO BE NONCOMPLIANT WITH THE

CBC HAVE BEEN IDENTIFIED AND THE CORRECTIVE WORK NECESSARY

SCOPE OF THIS PROJECT'S WORK THROUGH DETAILS, DRAWINGS AND

PORTIONS OF THE POT THAT WILL NOT BE CORRECTED IN THIS PROJECT

UNREASONABLE HARDSHIP ARE INDICATED IN THESE CONSTRUCTION

NONCONFORMING BEYOND REASONABLE CONSTRUCTION TOLERANCES, THE ITEMS SHALL BE BROUGHT INTO COMPLIANCE WITH THE CBC AS A

TO BRING THEM INTO COMPLIANCE HAS BEEN INCLUDED WITHIN THE

SPECIFICATIONS INCORPORATED INTO THESE CONSTRUCTION

DOCUMENTS. ANY NONCOMPLIANT ELEMENTS, COMPONENTS OR

BASED ON VALUATION THRESHOLD LIMITATIONS OR A FINDING OF

DURING CONSTRUCTION, IF POT ITEMS WITHIN THE SCOPE OF THE PROJECT REPRESENTED AS CBC COMPLIANT ARE FOUND TO BE

PART OF THIS PROJECT BY MEANS OF A CONSTRUCTION CHANGE

CALIFORNIA BUILDING CODE (CBC) ACCESSIBILITY PROVISIONS FOR PATH

PROPERTY LINE

"THE PATH OF TRAVEL (POT) IDENTIFIED IN THESE CONSTRUCTION

OF TRAVEL REQUIREMENTS FOR ALTERATIONS, ADDITIONS AND

ACCESSIBLE PATH OF EGRESS

### abode communities architecture

## LAEP EARLY

13928 KORNBLUM AVE. HAWTHORNE, CA 90250

Los Angeles Education

ARCHITECT:

**Abode Communities** 1149 S. Hill Street, Suite 700

CONSULTANTS:

**Breen Engineering** 1983 W. 190th St., Suite 200

**Breen Engineering** 1983 W. 190th St., Suite 200 Torrance, CA 90504 T: 310.464.8404

#### **NOTES**

DOCUMENTS.

DOCUMENT."

- 1. ACCESSIBLE PATH OF TRAVEL AS INDICATED ON PLAN IS A BARRIER-FREE ACCESS ROUTE WITHOUT ANY ABRUPT LEVEL CHANGES EXCEEDING 1/2" IF BEVELED AT 1:2 MAX SLOPE, OR VERTICAL LEVEL CHANGES NOT EXCEEDING 1/4" MAX, AND AT LEAST 48" IN WIDTH. SURFACE IS TABLE, FIRM, AND SLIP RESISTANT. CROSS SLOPE DOES NOT EXCEED 2% AND SLOPE IN THE DIRECTION OF TRAVEL IS LESS THAN 5%, UNLESS OTHERWISE INDICATED. ACCESSIBLE PATH OF TRAVEL SHALL BE MAINTAINED FREE OF OVERHANGING OBSTRUCTIONS TO 80" MINIMUM, AND PROTRUDING **OBJECTS GREATER THAN 4" PROJECTION FROM WALL** AND ABOVE 27" AND LESS THAN 80".
- 2. AREA OF SAFE DISPERSAL: AREA SHALL BE PERMANENTLY MAINTAINED AND IDENTIFIED AS A SAFE DISPERSAL AREA.

**CHILDHOOD CENTER** 

Partnership 1541 Wilshire Blvd., Suite 200 Los Angeles, CA 90017 T: 213.622.5237


Los Angeles, CA 90015 T: 213.629.2702

Torrance, CA 90504 T: 310.464.8404 MECHANICAL/ **ELECTRICAL/ PLUMBING** 

STRUCTURAL **Breen Engineering** 1983 W. 190th St., Suite 200 Torrance, CA 90504

#### DSA APPLICATION NUMBER: 03-122151

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DATE REV PROGRESS SET 02.01.22 DSA PROGRESS SET 03.02.22 DSA APPLICATION SET 04.01.22 DSA BACK-CHECK SET 10.05.22 DSA BACK-CHECK SET 10.24.22 DSA BACK-CHECK SET 11.01.22

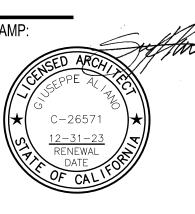SHEET NAME:

EGRESS PLAN

SHEET NUMBER:

A1.01

EGRESS PLAN SCALE: NOT TO SCALE




(E) LUNCHROOM (NOT IN SCOPE)

(E) LUNCHROOM

(E) TRASH BINS

(NOT IN SCOPE)

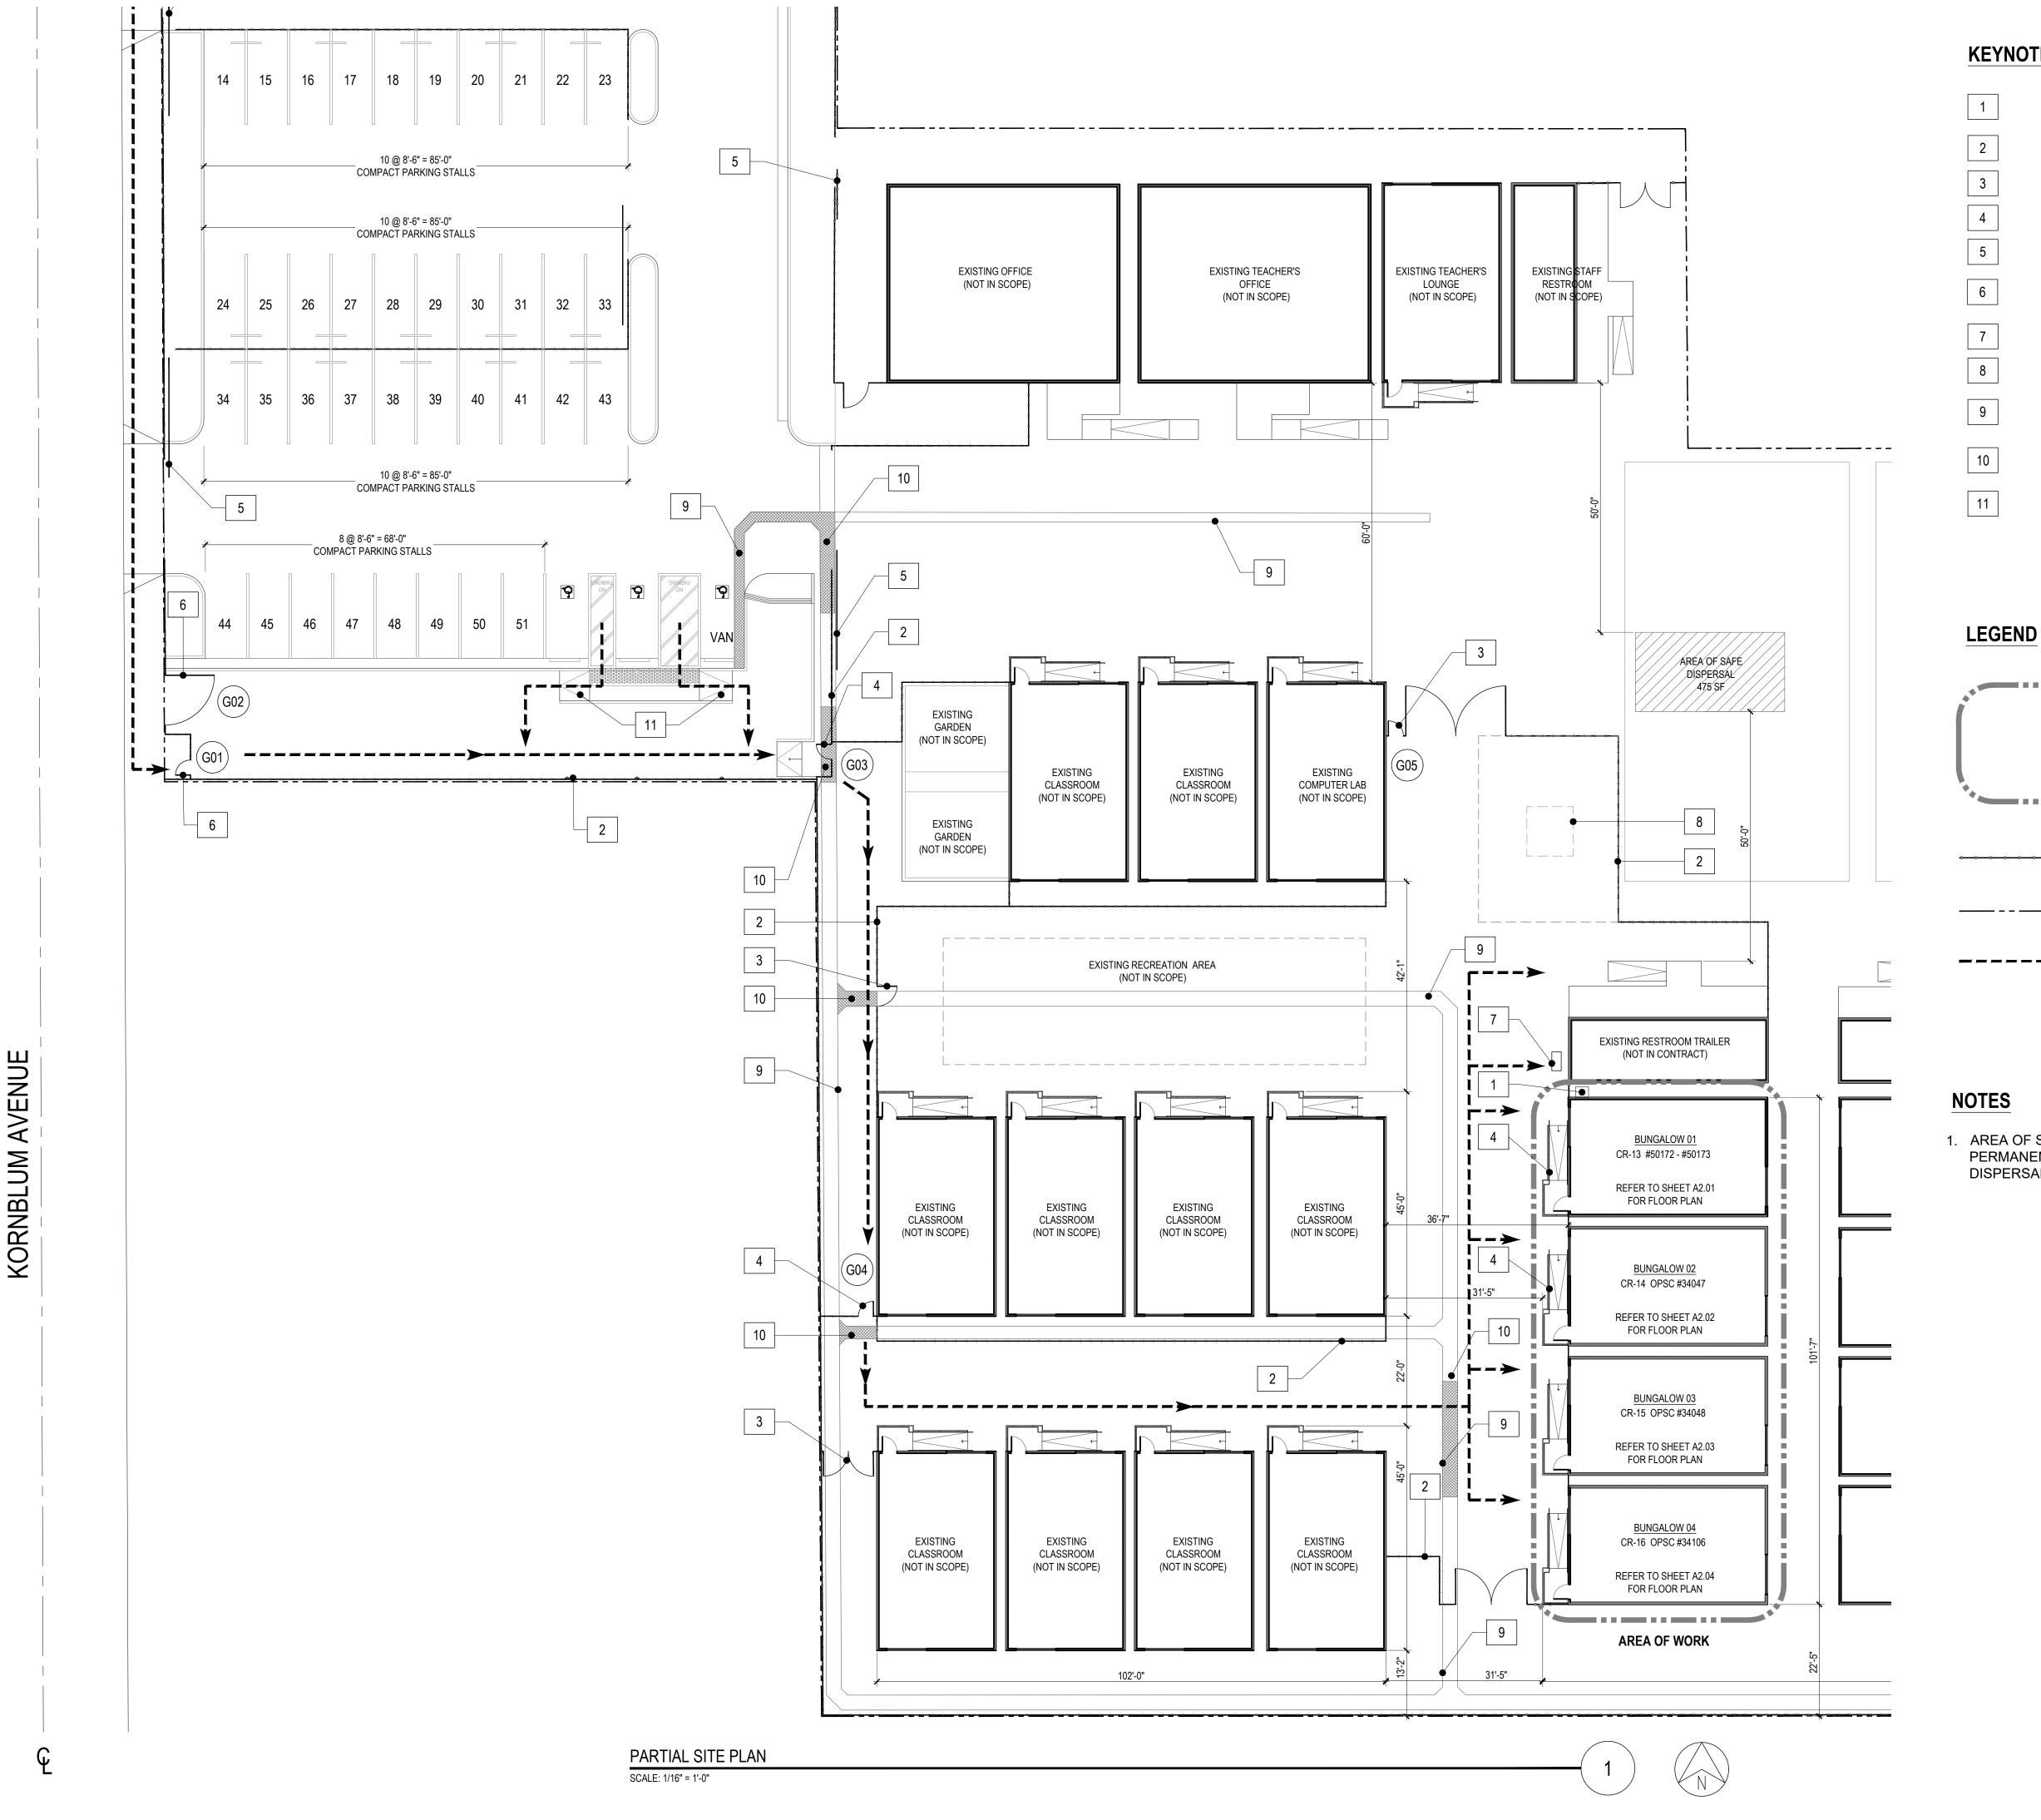

#### **KEYNOTES**

PROPOSED WATER HEATER LOCATION WITH METAL SURROUND, REFER TO PLUMBING PLANS

EXISTING 8 FT HIGH FENCE

EXISTING GATE W/ PANIC HARDWARE

EXISTING GATE, PROVIDE PANIC HARDWARE

EXISTING SLIDING GATE

NEW GATE, PROVIDE PANIC HARDWARE AS NEEDED


HI-LO DRINKING FOUNTAIN

EXISTING PLAYGROUND STRUCTURE (N.I.C.)

EXISTING V-GUTTER, REFER TO AS-BUILT DETAIL

NEW CONCRETE SLAB, REFER TO CIVIL DRAWINGS

NEW CURB RAMP, REFER TO SHEET A10.05

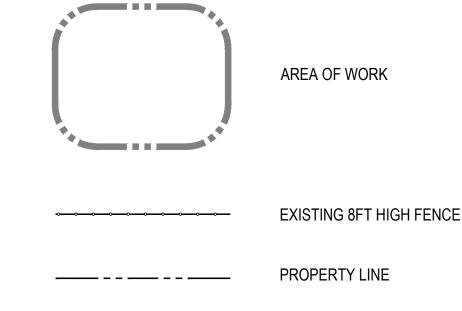

1. AREA OF SAFE DISPERSAL: AREA SHALL BE PERMANENTLY MAINTAINED AND IDENTIFIED AS A SAFE DISPERSAL AREA.

ACCESSIBLE PATH OF TRAVEL

IDENTIFICATION STAMP DIV. OF THE STATE ARCHITEC APP: 03-122151 INC: REVIEWED FOR SS 🗹 FLS 🗹 ACS 🗹 DATE: 11/02/2022

## abode communities architecture

#### LAEP EARLY CHILDHOOD CENTER

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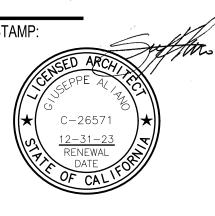
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#### DSA APPLICATION NUMBER: 03-122151


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SHEET NAME: PARTIAL SITE PLAN


SHEET NUMBER: A1.02



SITE PLAN

SCALE: 1/32" = 1'-0"

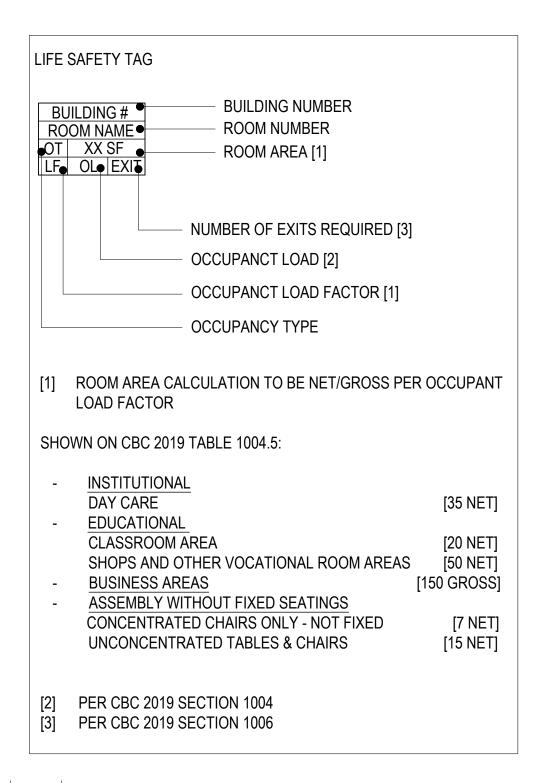BUNGALOW	CONSTR. TYPE	NAME	AREA	OCC. TYPE	OCC. LOAD FACTOR	OCC. LOAD
01	V-B	KITCHEN	258 SF	1-4	35	08
		LAUNDRY	53 SF	I-4	35	02
		CHILD RESTROOM	61 SF	1-4	35	02
		CLASSROOM	382 SF	I-4	35	11
			850 SF			23
02	V-B	WORK AREA	267 SF	I-4	35	08
		CHILD RESTROOM	61 SF	1-4	35	02
		CLASSROOM	441 SF	1-4	35	13
			864 SF			23
	V-B	OFFICE / ADMIN	248 SF	В	150	02
		CHILD RESTROOM	61 SF	I-4	35	02
03		ADULT RESTROOM	52 SF	1-4	35	02
00		CLASSROOM	402 SF	1-4	35	12
			853 SF			18
04	V-B	OFFICE	101 SF	В	150	01
		FILE ROOM	58 SF	В	150	01
		CONFERENCE ROOM	80 SF	В	150	01
		CHILD RESTROOM	61 SF	Е	20	04
		CLASSROOM	462 SF	Е	20	24
			852 SF			31
				AL CAPA	CITY 95 PE	

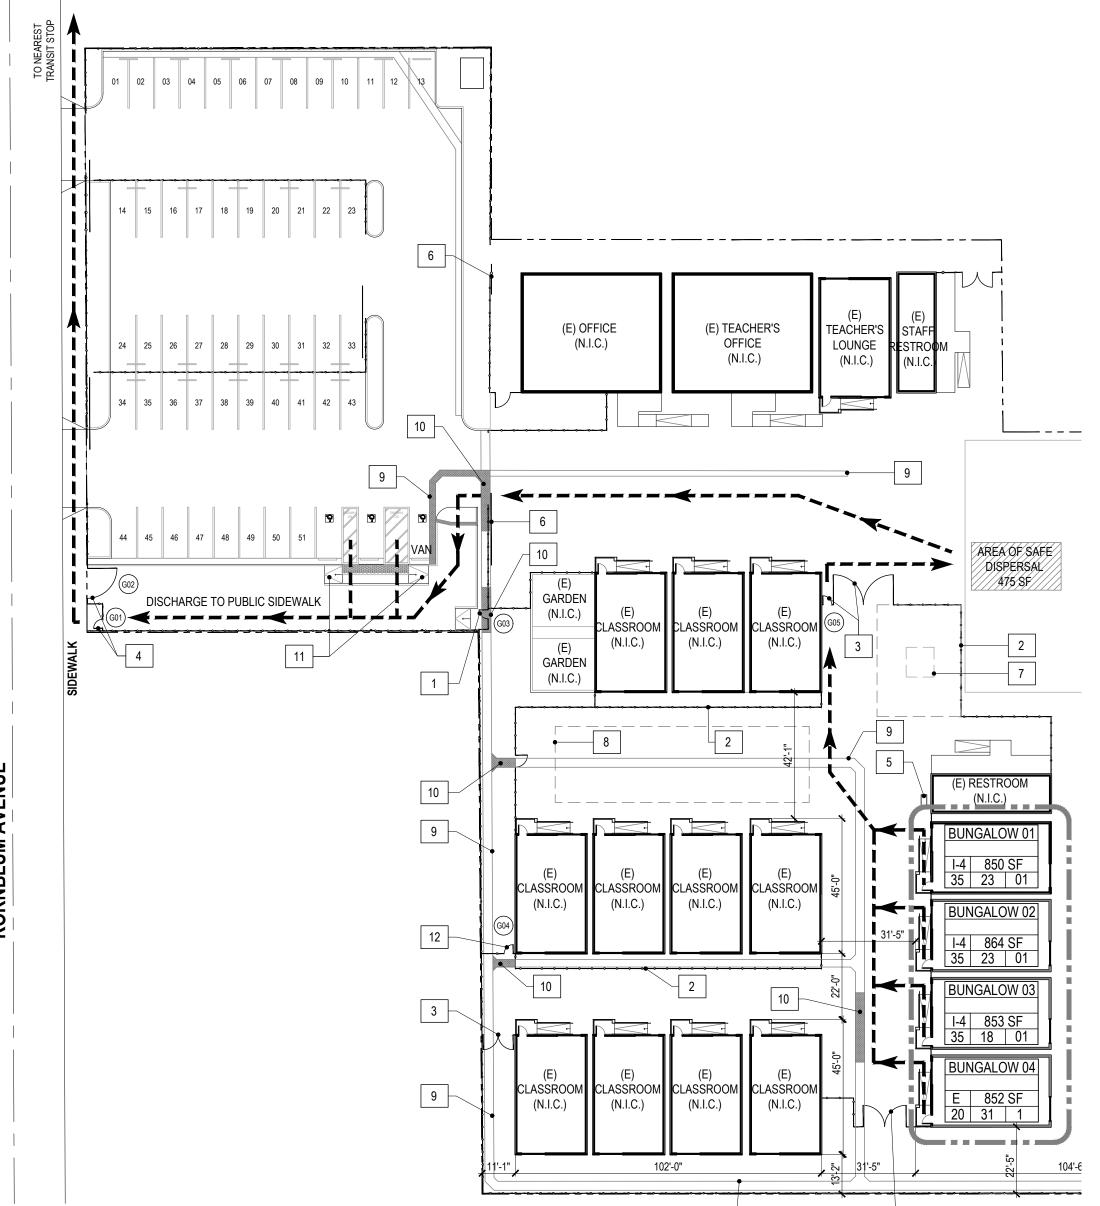




9



3

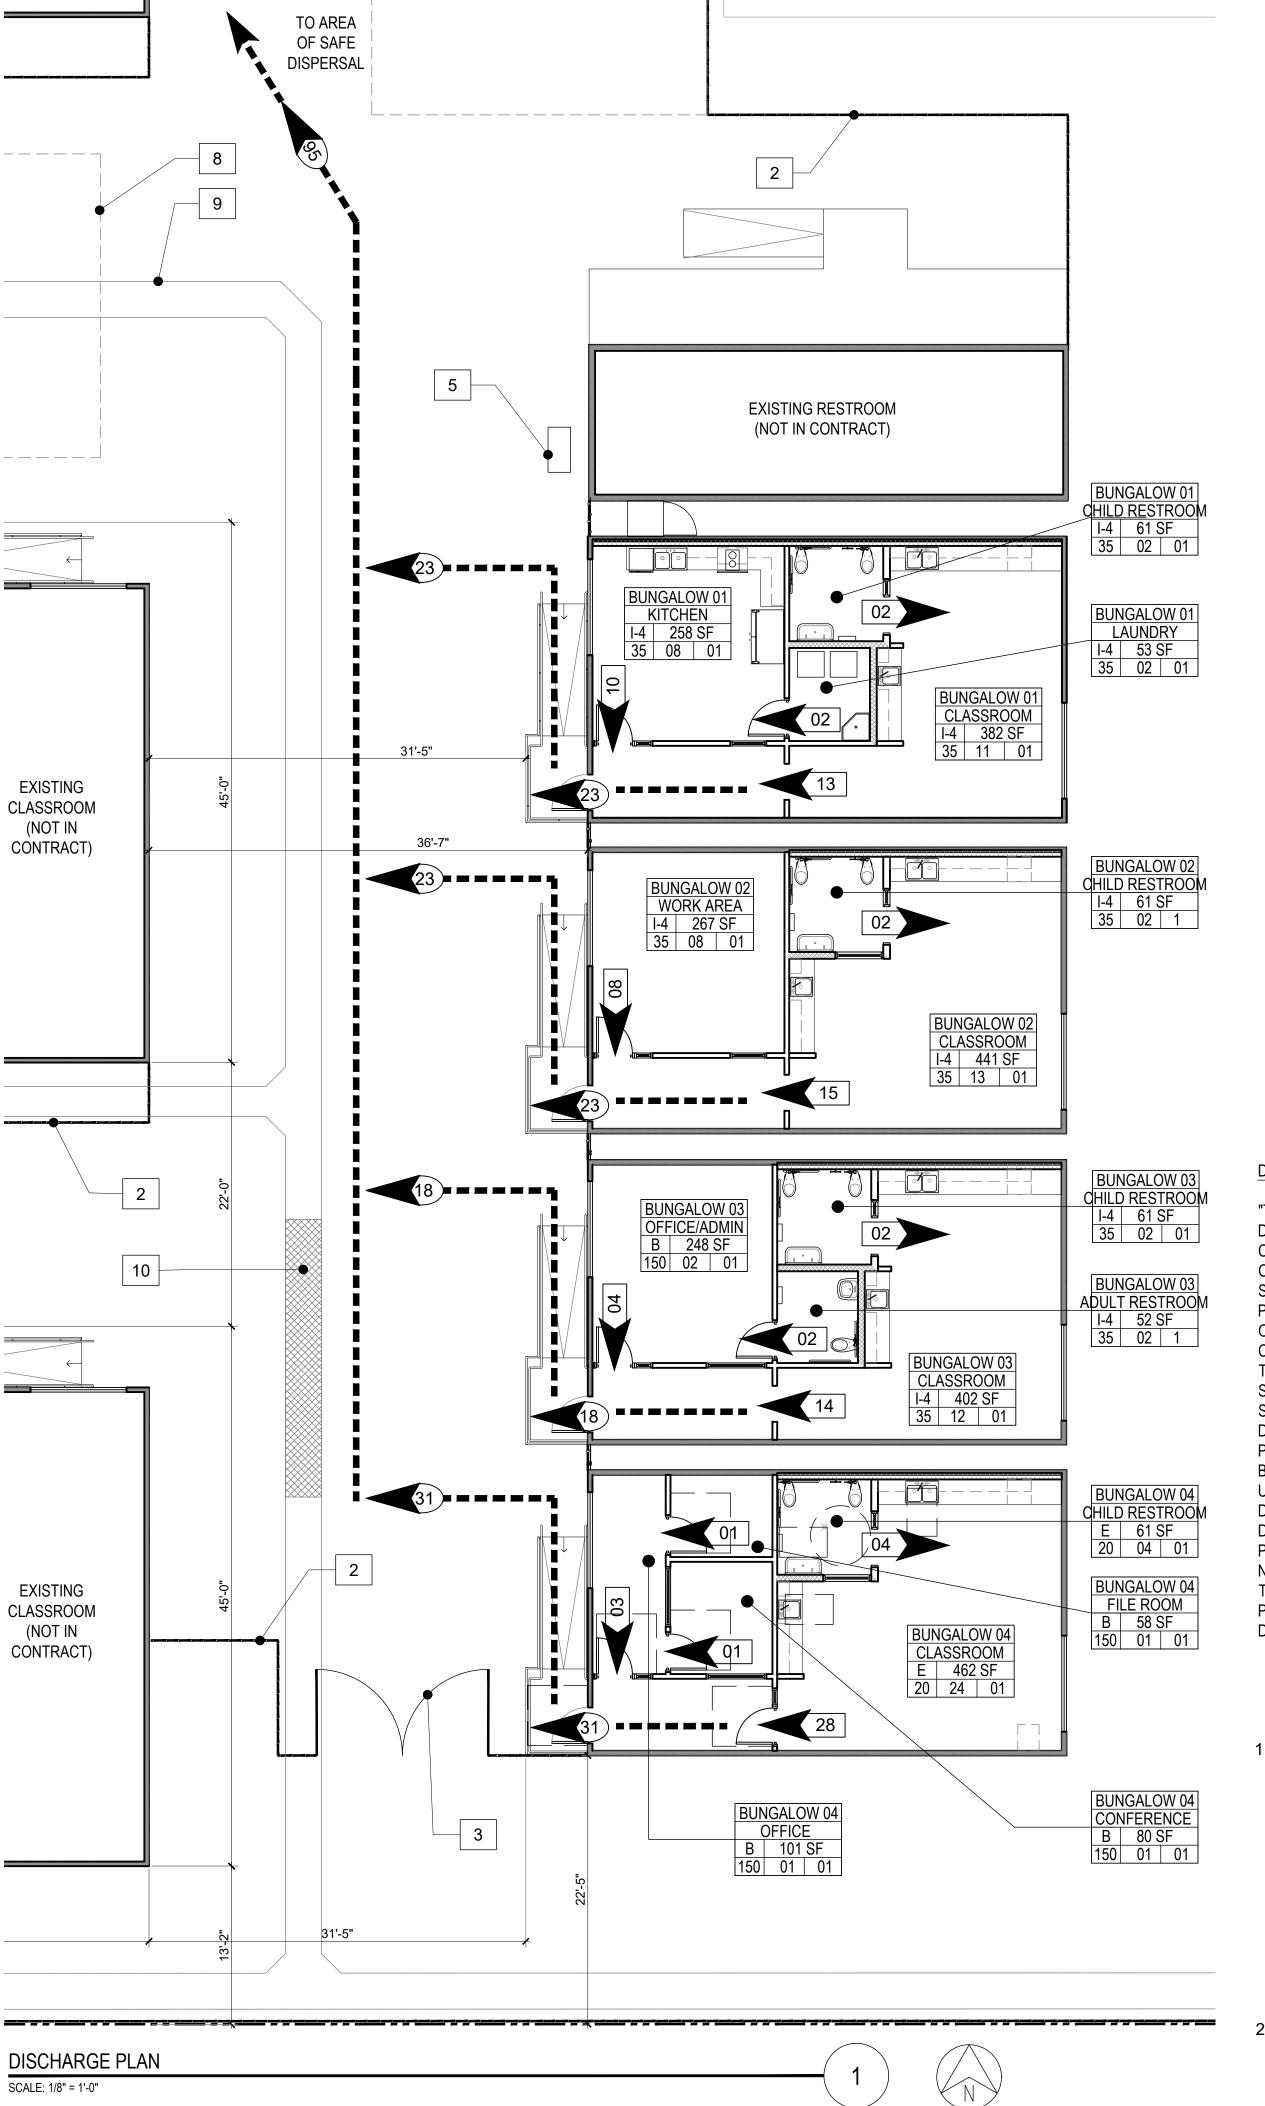

#### **KEYNOTES**

- MAIN ENTRY GATE, PROVIDE PANIC HARDWARE
- EXISTING 8 FT HIGH FENCE
- 3 EXISTING GATE W/ PANIC HARDWARE
- NEW GATE, PROVIDE PANIC HARDWARE AS NEEDED
- HI-LO DRINKING FOUNTAIN
- 6 EXISTING SLIDING GATE
- EXISTING PLAYGROUND STRUCTURE (N.I.C.)
- EXISTING RECREATION AREA (N.I.C.)
- 9 EXISTING V-GUTTER, REFER TO AS-BUILT DETAIL 1/C16
- 10 NEW CONCRETE SLAB, REFER TO CIVIL **DRAWINGS**
- 11 NEW CURB RAMP, REFER TO SHEET A10.05
- 12 EXISTING GATE, PROVIDE PANIC HARDWARE

#### **LEGEND**



AREA OF WORK

OF TRAVEL

PROPERTY LINE

**EXISTING 8 FT HIGH FENCE** 

#### DESIGN PROFESSIONAL IN GENERAL RESPONSIBLE CHARGE STATEMENT:

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- AREA OF SAFE DISPERSAL: AREA SHALL BE PERMANENTLY MAINTAINED AND IDENTIFIED AS A SAFE DISPERSAL AREA.

**IDENTIFICATION STAMP** DIV. OF THE STATE ARCHITEC APP: 03-122151 INC: REVIEWED FOR SS 🗹 FLS 🗹 ACS 🗹 11/02/2022

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**Abode Communities** 1149 S. Hill Street, Suite 700 Los Angeles, CA 90015 T: 213.629.2702

**CONSULTANTS:** 


**Breen Engineering** 1983 W. 190th St., Suite 200 Torrance, CA 90504 T: 310.464.8404

MECHANICAL/ **ELECTRICAL/ PLUMBING Breen Engineering** 1983 W. 190th St., Suite 200 Torrance, CA 90504 T: 310.464.8404

STRUCTURAL **Breen Engineering** 1983 W. 190th St., Suite 200 Torrance, CA 90504 T: 310.464.8404

### DSA APPLICATION NUMBER: 03-122151

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DATE REV 02.01.22 PROGRESS SET DSA PROGRESS SET 03.02.22 DSA APPLICATION SET 04.01.22 DSA BACK-CHECK SET 10.05.22 DSA BACK-CHECK SET 10.24.22 DSA BACK-CHECK SET 11.01.22

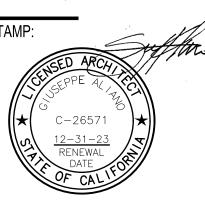SHEET NAME:


DISCHARGE PLAN

SHEET NUMBER:

A1.03

# 16 | 15 | 9'-0" MIN. STANDARD ADA 5'-0" STANDARD ADA 8'-0" 9'-0" MIN. VAN ACCESSIBUE 9 14 LANDING LANDING A10.05 6'-0" 22'-0" 6'-7 3/4" RAMP RUN RAMP RUN A10.05 12 15 NOTE: REFER TO CIVIL DRAWINGS FOR SLOPES. ACCESSIBLE PARKING

SCALE: 1/8" = 1'-0"

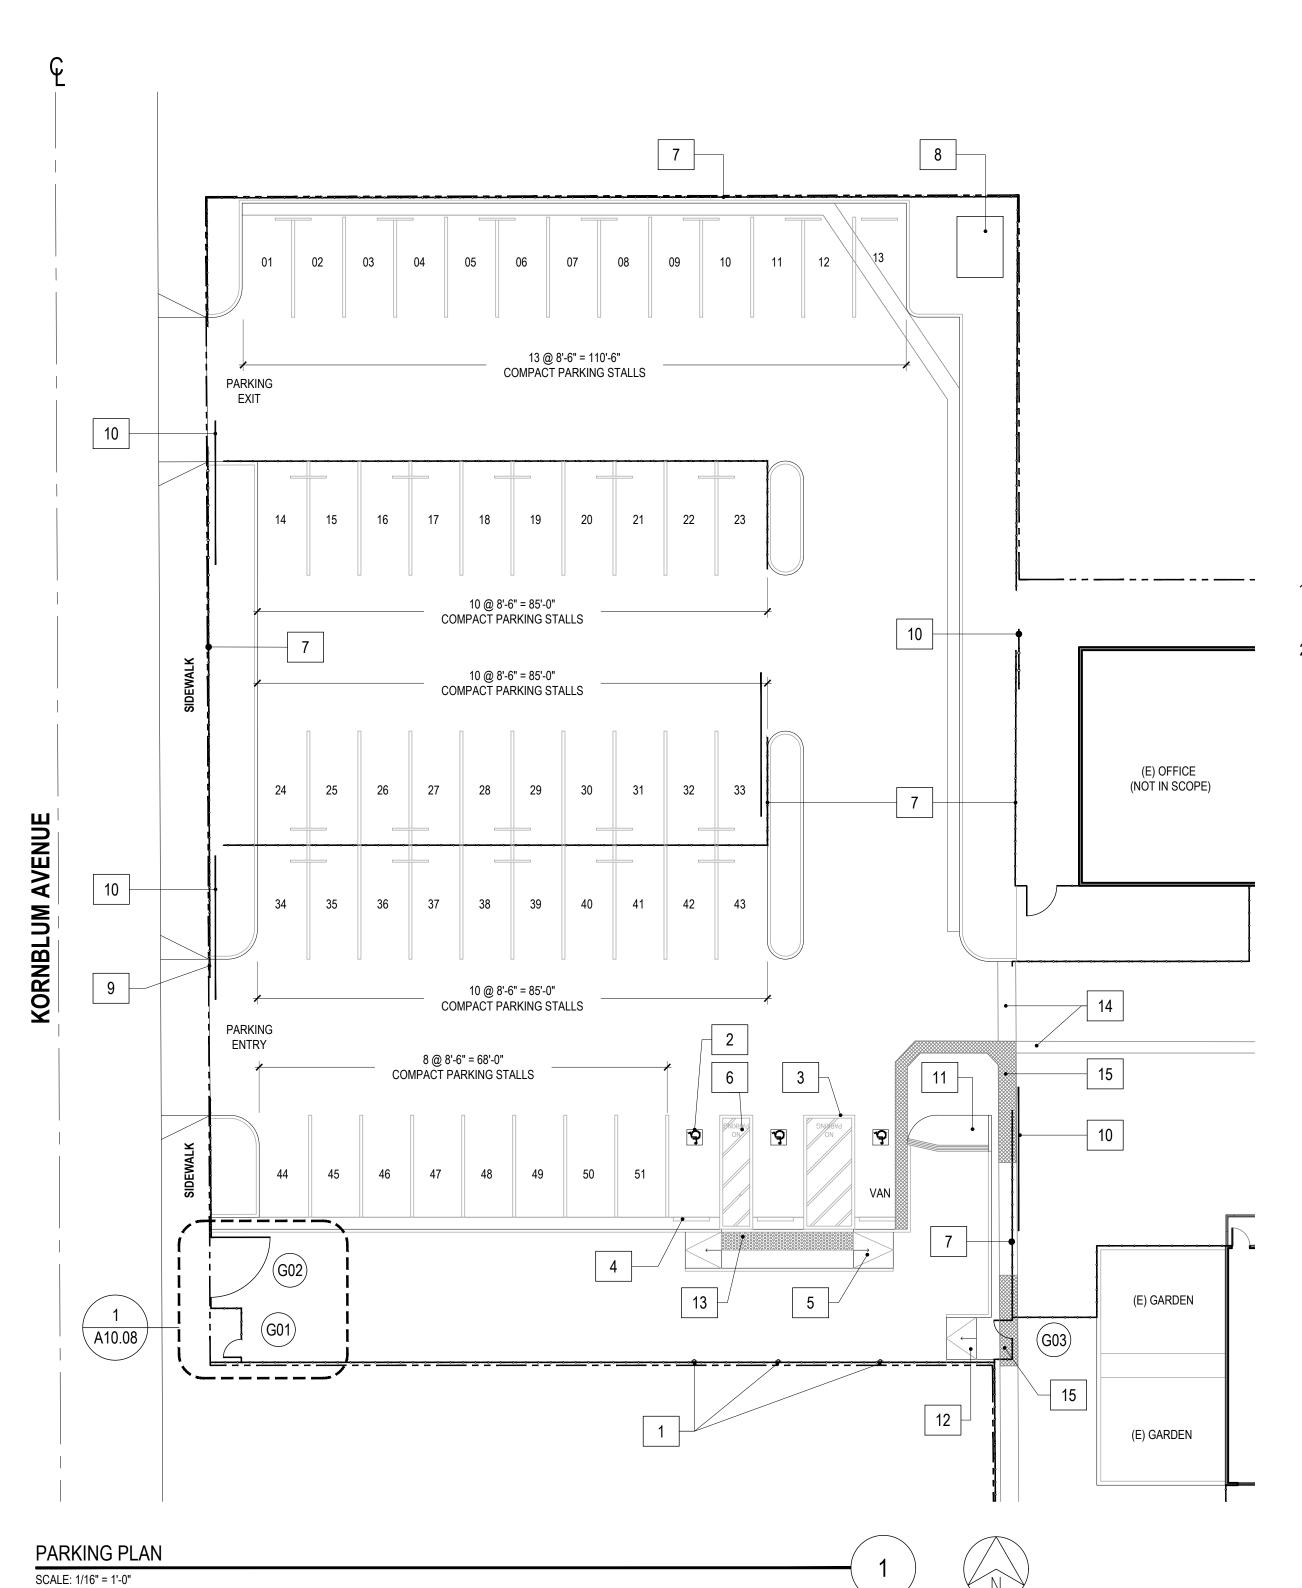

#### **KEYNOTES**

ACCESSIBLE PARKING SIGN TO BE MOUNTED ON EXISTING

10 FT HIGH CHAIN LINK FENCE

APP: 03-122151 IN

REVIEWED FO

SS ID FLS ID IN

REVIEWED FO

2 PAINTED PAVEMENT EMBLEM, REFER TO DETAIL 1/G3.03.

3 LOADING, UNLOADING AND ACCESS AISLE, REFER TO DETAIL 4/G3.03.

4 (E) WHEEL STOP

5 NEW CURB RAMP, REFER TO DETAILS 6/G3.03, AND 8/A10.05.

12" WHITE LETTERS, REFER TO DETAIL 4/G3.03.

7 (E) CHAIN LINK FENCE, REFER TO AS BUILTS, SHEET C11.

(E) POWER PER SOUTHERN CALIFORNIA EDISON, REFER TO AS BUILTS, SHEET E-3.

9 TOW AWAY SIGN, REFER TO DETAIL 7/G3.03.

10 (E) SLIDING GATE

11 (E) RAMP, REFER TO AS BUILTS, SHEET C16.

12 NEW RAMP, REFER TO 7/A10.05.

13 NEW TRUNCATED DOMES

14 (E) V-GUTTER, REFER TO AS BUILTS, SHEET C16.

5 NEW CONCRETE SLAB, REFER TO CIVIL DRAWINGS.

16 (E) 12" GROOVING

#### **LEGEND**

(E) CHAIN LINK FENCE

PROPERTY LINE

#### NOTES

- 1. FOR EXISTING ACCESSIBLE PARKING AREA, REFER TO (E) DSA A# 00-101976, SHEET C16.
- 2. REFER TO DETAILS 2/G3.03, 3/G3.03, AND 4/G3.03 FOR ACCESSIBLE PARKING SPACES.

IDENTIFICATION STAMP DIV. OF THE STATE ARCHITECT

APP: 03-122151 INC:

REVIEWED FOR

SS FLS ACS D

DATE: 11/02/2022

# abode communities architecture

PROJECT:

# LAEP EARLY CHILDHOOD CENTER

13928 KORNBLUM AVE. HAWTHORNE, CA 90250

CLIENT:

Los Angeles Education Partnership 1541 Wilshire Blvd., Suite 200

Los Angeles, CA 90017 T: 213.622.5237

ARCHITECT:

Abode Communities 1149 S. Hill Street, Suite 700 Los Angeles, CA 90015 T: 213.629.2702

CIVIL

CONSULTANTS:

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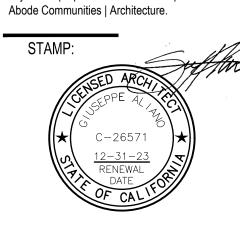
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DSA APPLICATION SET 04.01.22

DSA BACK-CHECK SET 10.05.22


DSA BACK-CHECK SET 10.24.22

SHEET NAME:

PARKING PLAN

DSA BACK-CHECK SET 11.01.22

SHEET NUMBER:
A1.04

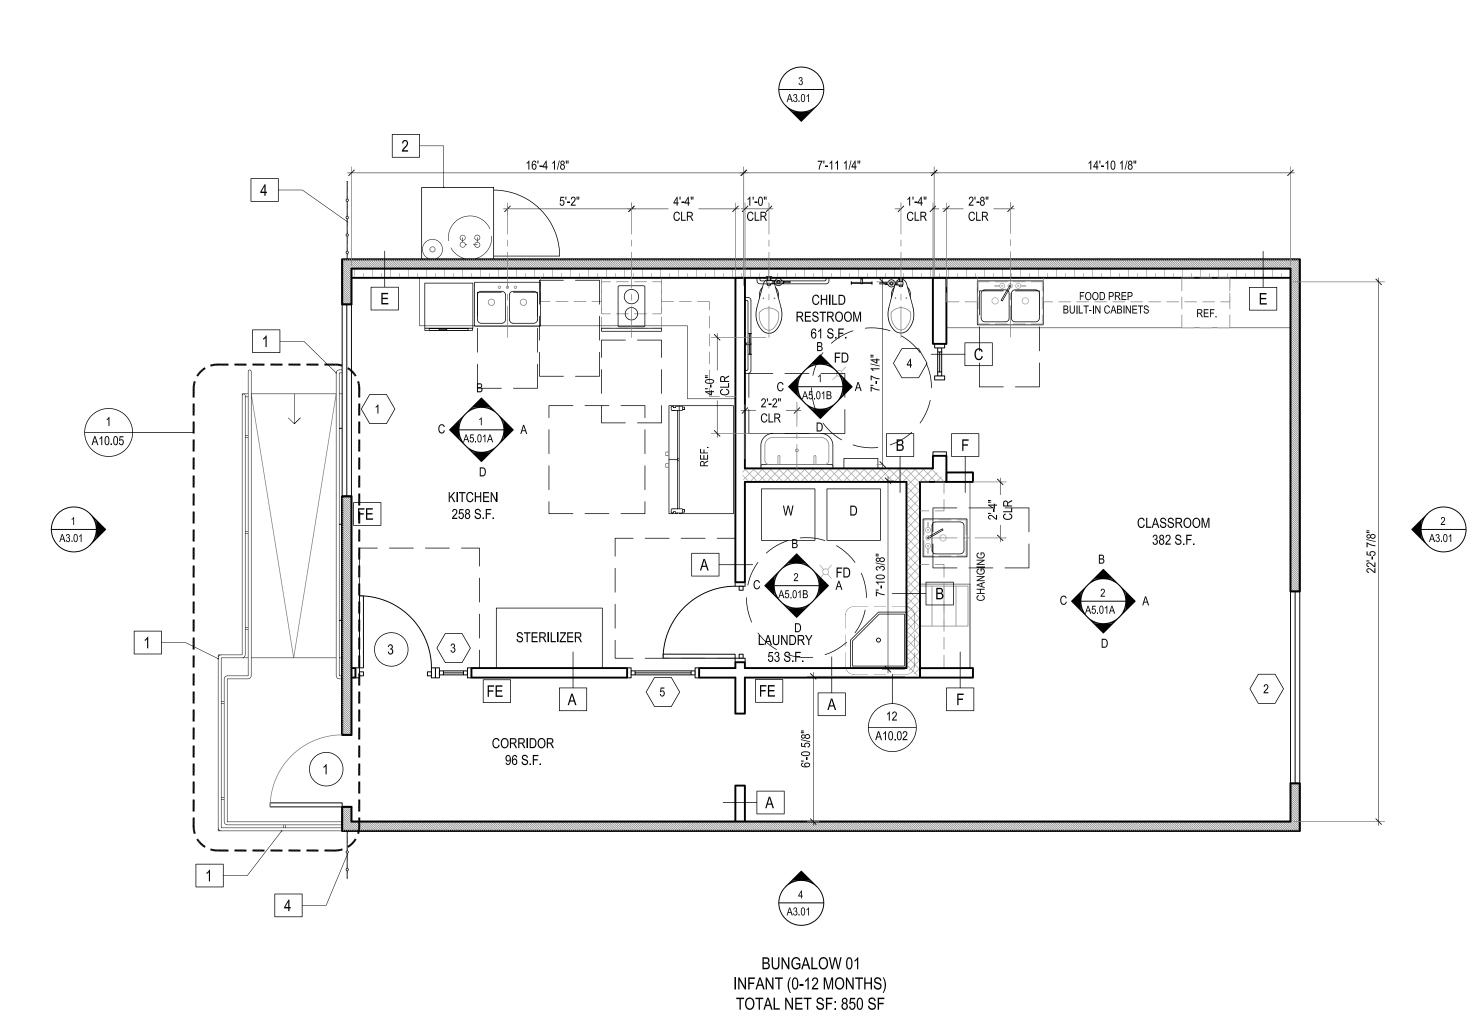


ADMINISTRATION KITCHEN/LAUNDRY

BUNGALOW 01 FLOOR PLAN

SCALE: 1/4" = 1'-0"

LEGEND

EXISTING WALL TO REMAIN

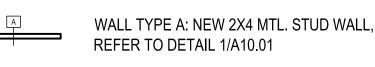

WALL TYPE B: NEW 2X6 MTL. STUD PLUMBING WALL, REFER TO DETAILS 1/A10.01

WALL TYPE C: NEW 2x6 MTL. STUD WALL,


REFER TO DETAIL 3/A10.01

WALL TYPE D: NEW 2X6 MTL. STUD PLUMBING WALL, REFER TO DETAILS 3/A10.01

WALL TYPE E: NEW 2X4 METAL STUD FURR-OUT WALL, REFER TO DETAIL 2/A10.01

WALL TYPE F: NEW 2X4 METAL STUD PARTIAL HEIGHT WALL, REFER TO DETAIL 10/A10.02

ACCESSIBLE PATH OF TRAVEL

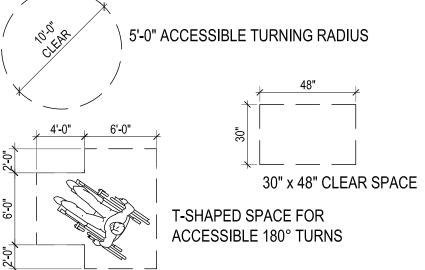

FD NEW FLOOR DRAIN

FE NEW 2A: 10-B: C FIRE EXTINGUISHER AND CABINET

#### NOTES

- 1. ALL DIMENSIONS FROM CENTERLINE OF PLUMBING FIXTURE ARE TO FACE OF FINISH.
- SEE FLOOR PLANS (A2.01 A2.04) FOR DOOR AND WINDOW LOCATION.
- 3. MAX COUNTER HEIGHT FOR CABINETS SHALL NOT EXCEED 34".
- 4. CONTRACTOR SHALL PROVIDE SHOP DRAWINGS FOR ALL CABINETRY FOR APPROVAL PRIOR TO FABRICATION.
- 5. SEE ACCESSIBILITY SHEETS FOR MOUNTING HEIGHTS.
- 6. CONTRACTOR TO PROVIDE TOILET PAPER DISPENSER AND SEAT COVER DISPENSER INSIDE ALL RESTROOMS PER 5/G3.04, 2/G3.06, AND 1/G3.06 INSIDE EACH TOILET FACILITY. REFER TO SPECS FOR NON-ACCESSIBLE WC AND FOR ALL WHEELCHAIR ACCESSIBLE WC.
- 7. FOR TYPICAL AND CHILD ACCESSIBLE RESTROOM MOUNTING HEIGHTS SEE DETAILS 2/G3.04, 4/G3.04, 5/G3.04, 2/G3.06, AND 1/G3.06.
- 8. PROVIDE PAPERLESS GYPSUM WALLBOARD AT ALL RESTROOM AND KITCHEN WALLS.
- 9. PROVIDE 3/4" RADIUS QUARTER-ROUND TO ALL EXPOSED CABINETRY EDGES.
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- 19. REFER TO PLUMBING PLANS FOR WATER HEATER ANCHORAGE DETAILS.
- 20. FLOOR DRAIN FOR MAINTENANCE ONLY.

IDENTIFICATION STAMP DIV. OF THE STATE ARCHITECT APP: 03-122151 INC:

REVIEWED FOR SS FLS ACS DATE: 11/02/2022

# abode communities architecture

PROJECT:

# LAEP EARLY CHILDHOOD CENTER

13928 KORNBLUM AVE. HAWTHORNE, CA 90250

NAWIHORNE, CA 70250

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Los Angeles Education

Partnership 1541 Wilshire Blvd., Suite 200 Los Angeles, CA 90017 T: 213.622.5237

ARCHITECT:

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CONSULTANTS: CIVIL

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MECHANICAL/

ELECTRICAL/ PLUMBING

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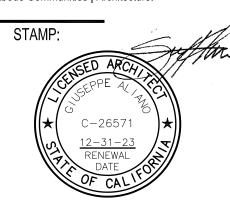
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## **KEYNOTES**

- 1 NEW RAILING, REFER TO STRUCTURAL PLANS.
- NEW 38"X40" CONCRETE PAD TO ACCOMMODATE NEW WATER HEATER CLOSET. REFER TO PLUMBING DRAWINGS
- 3 EXISTING IDF CLOSET
- 4 EXISTING 8 FT. HIGH CHAIN LINK FENCE

PROGRESS SET 02.01.22

DSA PROGRESS SET 03.02.22

DSA APPLICATION SET 04.01.22

DSA BACK-CHECK SET 10.05.22


DSA BACK-CHECK SET 10.24.22

SHEET NAME:
BUNGALOW 01
FLOOR PLAN

DSA BACK-CHECK SET 11.01.22

SHEET NUMBER:

A2.01

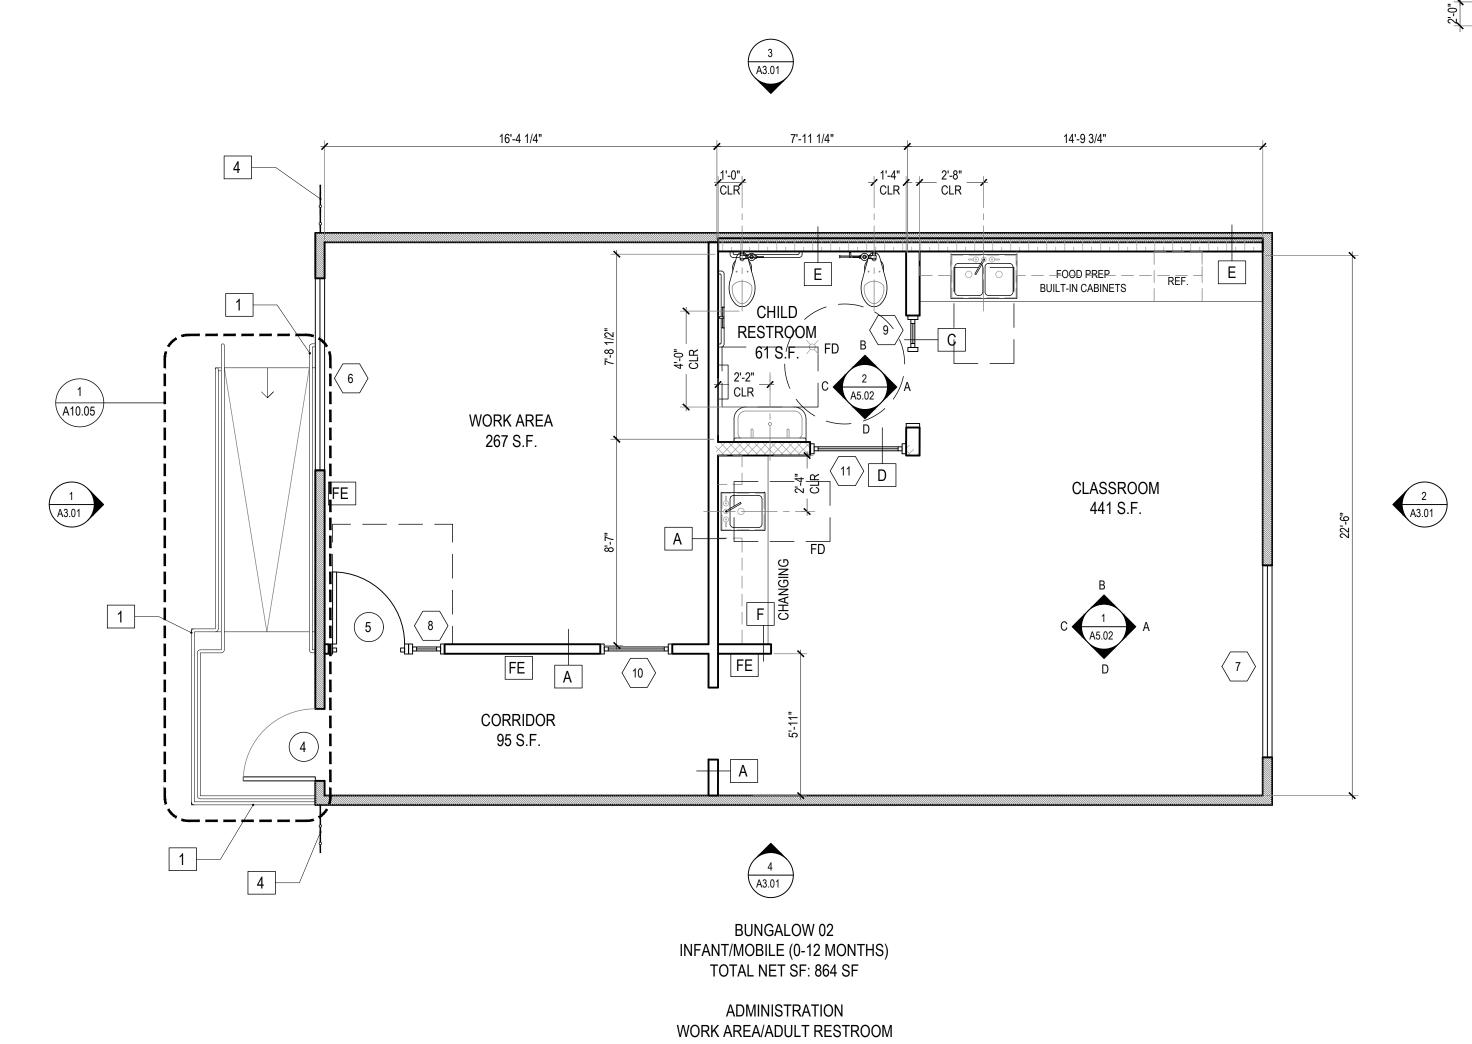

BUNGALOW 02 FLOOR PLAN

SCALE: 1/4" = 1'-0"

LEGEND EXISTING WALL TO REMAIN WALL TYPE A: NEW 2X4 MTL. STUD WALL, REFER TO DETAIL 1/A10.01 WALL TYPE B: NEW 2X6 MTL. STUD PLUMBING WALL, REFER TO DETAILS 1/A10.01 WALL TYPE C: NEW 2x6 MTL. STUD WALL, REFER TO DETAIL 3/A10.01 WALL TYPE D: NEW 2X6 MTL. STUD PLUMBING WALL, REFER TO DETAILS 3/A10.01 WALL TYPE E: NEW 2X4 METAL STUD FURR-OUT WALL REFER TO DETAIL 2/A10.01 WALL TYPE F: NEW 2X4 METAL STUD PARTIAL HEIGHT WALL, REFER TO DETAIL 10/A10.02 ACCESSIBLE PATH OF TRAVEL √ 5'-0" ACCESSIBLE TURNING RADIUS 30" x 48" CLEAR SPACE T-SHAPED SPACE FOR ACCESSIBLE 180° TURNS

FD NEW FLOOR DRAIN

FE NEW 2A: 10-B: C FIRE EXTINGUISHER AND CABINET

#### - NOTES

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APP: 03-122151 INC:

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DATE: 11/02/2022

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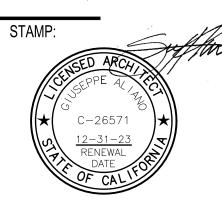
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DATE REV
PROGRESS SET 02.01.22
DSA PROGRESS SET 03.02.22
DSA APPLICATION SET 04.01.22
DSA BACK-CHECK SET 10.05.22


DSA BACK-CHECK SET 10.24.22 DSA BACK-CHECK SET 11.01.22

SHEET NAME:
BUNGALOW 02

**FLOOR PLAN** 

SHEET NUMBER:

A2.02

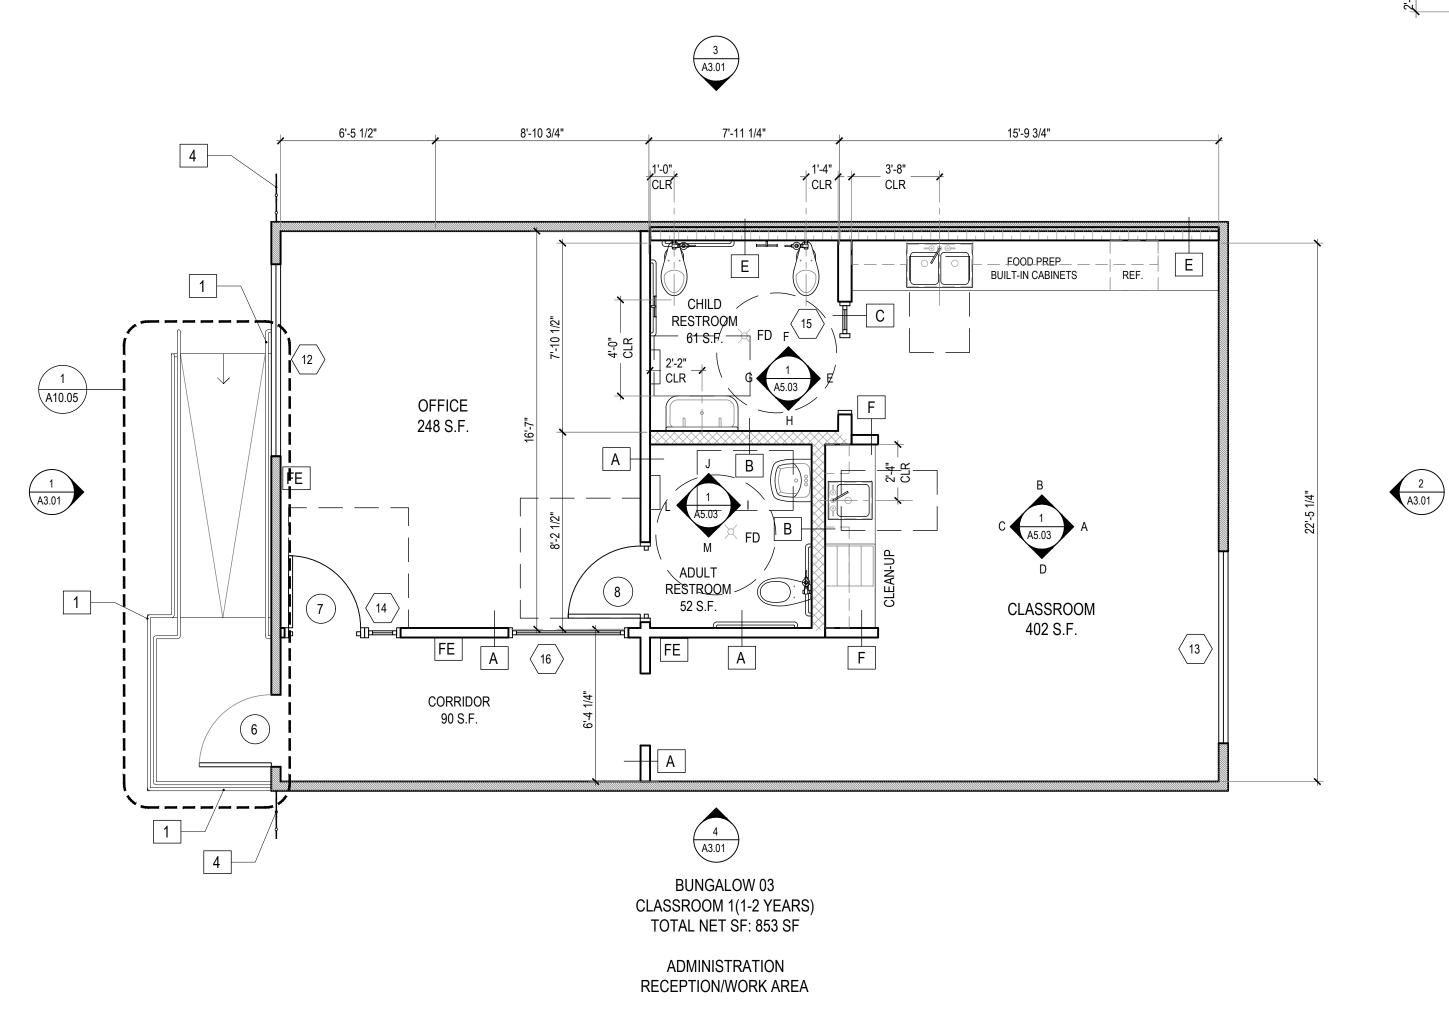

**BUNGALOW 03 FLOOR PLAN** 

SCALE: 1/4" = 1'-0"

EXISTING WALL TO REMAIN

WALL TYPE A: NEW 2X4 MTL. STUD WALL,
REFER TO DETAIL 1/A10.01

LEGEND

WALL TYPE B: NEW 2X6 MTL. STUD PLUMBING WALL, REFER TO DETAILS 1/A10.01


WALL TYPE C: NEW 2x6 MTL. STUD WALL, REFER TO DETAIL 3/A10.01

WALL TYPE D: NEW 2X6 MTL. STUD PLUMBING WALL, REFER TO DETAILS 3/A10.01

WALL TYPE E: NEW 2X4 METAL STUD FURR-OUT WALL REFER TO DETAIL 2/A10.01

WALL TYPE F: NEW 2X4 METAL STUD PARTIAL HEIGHT WALL, REFER TO DETAIL 10/A10.02

ACCESSIBLE PATH OF TRAVEL

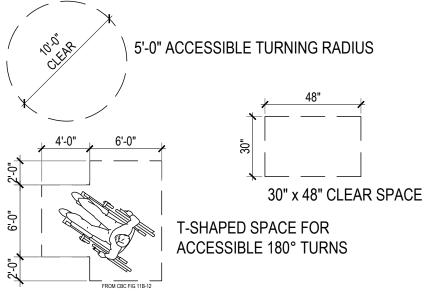

FD NEW FLOOR DRAIN

FE NEW 2A: 10-B: C FIRE EXTINGUISHER AND CABINET

#### --- NOTES

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IDENTIFICATION STAMP DIV. OF THE STATE ARCHITECT APP: 03-122151 INC:

REVIEWED FOR
SS FLS ACS DATE: 11/02/2022

# abode communities architecture

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## LAEP EARLY CHILDHOOD CENTER

13928 KORNBLUM AVE. HAWTHORNE, CA 90250

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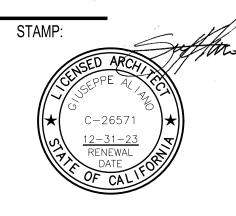
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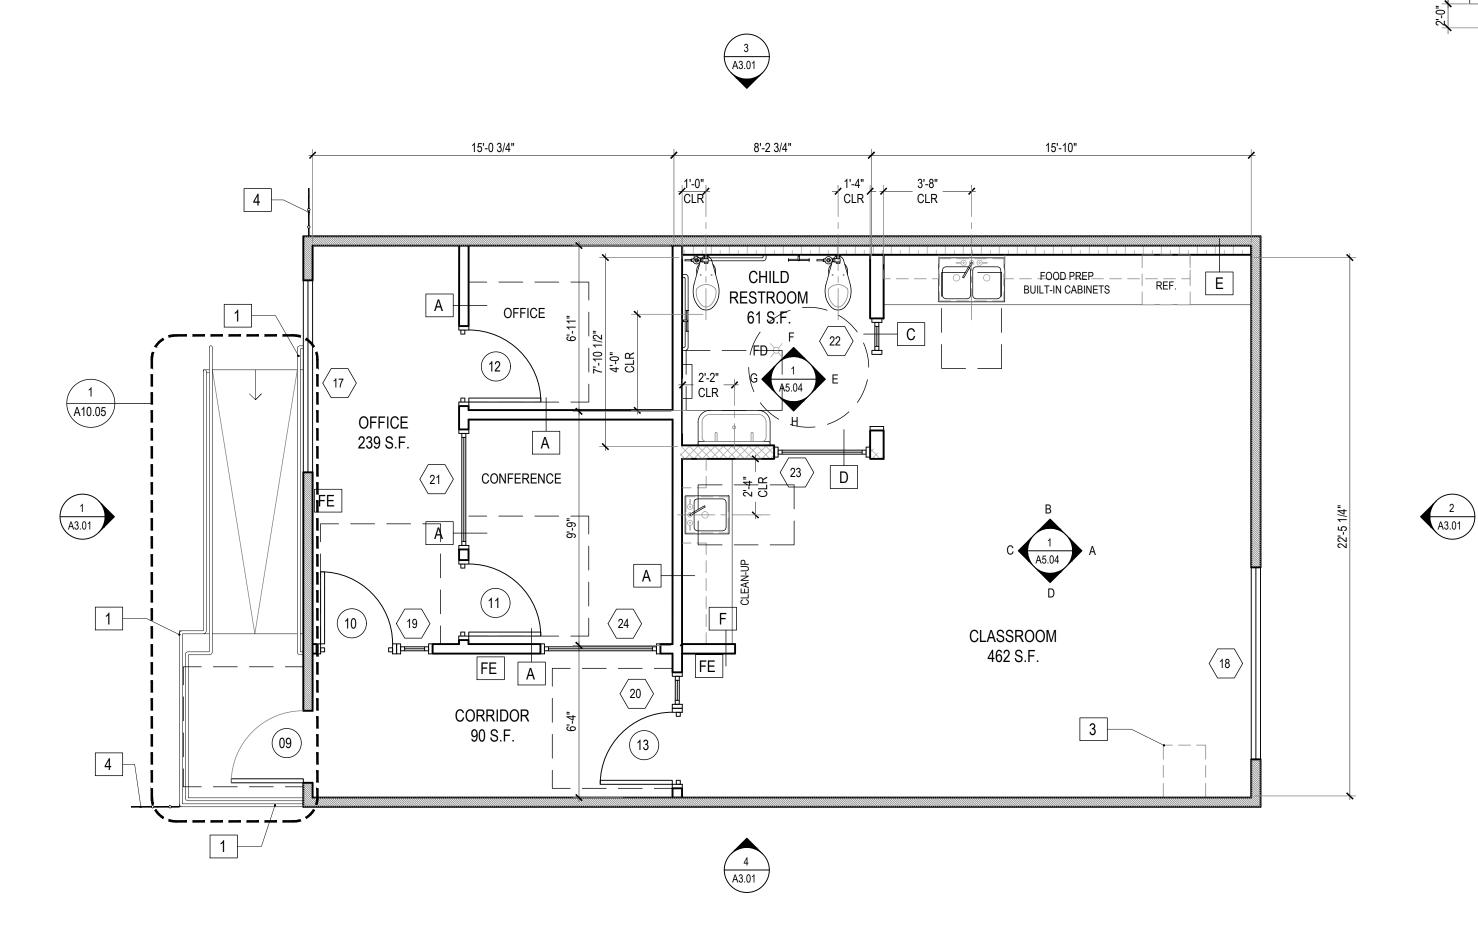
DSA BACK-CHECK SET 10.24.22

SHEET NAME:

DSA BACK-CHECK SET 11.01.22

BUNGALOW 03 FLOOR PLAN

SHEET NUMBER: A2.03



**BUNGALOW 04** CLASSROOM 2 (2-3 YEARS) TOTAL NET SF: 852 SF

ADMINISTRATION FILE/COPY/CONFERENCE

BUNGALOW 04 FLOOR PLAN SCALE: 1/4" = 1'-0"



LEGEND

EXISTING WALL TO REMAIN

REFER TO DETAIL 1/A10.01

REFER TO DETAILS 1/A10.01

REFER TO DETAIL 3/A10.01

REFER TO DETAILS 3/A10.01

REFER TO DETAIL 2/A10.01

ACCESSIBLE PATH OF TRAVEL

WALL, REFER TO DETAIL 10/A10.02

√ 5'-0" ACCESSIBLE TURNING RADIUS

T-SHAPED SPACE FOR

NEW FLOOR DRAIN

⋉ FD

ACCESSIBLE 180° TURNS

NEW 2A: 10-B: C FIRE EXTINGUISHER AND CABINET

WALL TYPE A: NEW 2X4 MTL. STUD WALL,

WALL TYPE C: NEW 2x6 MTL. STUD WALL,

WALL TYPE B: NEW 2X6 MTL. STUD PLUMBING WALL,

WALL TYPE D: NEW 2X6 MTL. STUD PLUMBING WALL,

WALL TYPE E: NEW 2X4 METAL STUD FURR-OUT WALL

WALL TYPE F: NEW 2X4 METAL STUD PARTIAL HEIGHT

30" x 48" CLEAR SPACE

1. ALL DIMENSIONS FROM CENTERLINE OF PLUMBING FIXTURE ARE TO FACE OF FINISH.

NOTES

- 2. SEE FLOOR PLANS (A2.01 A2.04) FOR DOOR AND WINDOW LOCATION.
- MAX COUNTER HEIGHT FOR CABINETS SHALL NOT EXCEED 34".
- 4. CONTRACTOR SHALL PROVIDE SHOP DRAWINGS FOR ALL CABINETRY FOR APPROVAL PRIOR TO FABRICATION.
- 5. SEE ACCESSIBILITY SHEETS FOR MOUNTING HEIGHTS.
- 6. CONTRACTOR TO PROVIDE TOILET PAPER DISPENSER AND SEAT COVER DISPENSER INSIDE ALL RESTROOMS PER 5/G3.04, 2/G3.06 AND 1/G3.06 INSIDE EACH TOILET FACILITY. REFER TO SPECS FOR NON-ACCESSIBLE WC AND FOR ALL WHEELCHAIR ACCESSIBLE WC.
- FOR TYPICAL AND CHILD ACCESSIBLE RESTROOM MOUNTING HEIGHTS SEE DETAILS 2/G3.04, 4/G3.04, 5/G3.04, 2/G3.06, AND 1/G3.06.
- 8. PROVIDE PAPERLESS GYPSUM WALLBOARD AT ALL RESTROOM AND KITCHEN WALLS.
- 9. PROVIDE 3/4" RADIUS QUARTER-ROUND TO ALL EXPOSED CABINETRY EDGES.
- 10. REFER TO G3.02, G3.02, G3.03, G3.04, G3.05, AND G3.06 FOR DISABLE ACCESS NOTES, DETAILS AND TYPICAL REQUIREMENTS.
- 11. ALL WORK SHALL CONFORM TO 2019 TITLE 24, CALIFORNIA CODE OF REGULATIONS (CCR).
- 12. CHANGES TO THE APPROVED DRAWINGS AND SPECIFICATIONS SHALL BE MADE BY AN ADDENDUM OR A CONSTRUCTION CHANGED DOCUMENT (CCD) APPROVED BY THE DIVISION OF THE STATE ARCHITECT, AS REQUIRED BY SECTION 4-338, PART 1, TITLE 24, CCR.
- 13. A "DSA CERTIFIED" PROJECT INSPECTOR EMPLOYED BY THE DISTRICT (OWNER) AND APPROVED BY THE DSA SHALL PROVIDE CONTINUOUS INSPECTION OF THE WORK. THE DUTIES OF THE INSPECTOR ARE DEFINED IN SECTION 4-342, PART 1, TITLE 24, CCR.
- 14. A "DSA CERTIFIED" CLASS 3 PROJECT INSPECTOR IS REQUIRED FOR THIS PROJECT.
- 15. A DSA ACCEPTED TESTING LABORATORY DIRECTLY EMPLOYED BY THE DISTRICT (OWNER) SHALL CONDUCT ALL THE REQUIRED TESTS AND INSPECTIONS FOR THE PROJECT.
- 16. THE INTENT OF THESE DRAWINGS AND SPECIFICATIONS IS THAT THE WORK OF THE ALTERATION, REHABILITATION OR RECONSTRUCTION IS TO BE IN ACCORDANCE WITH TITLE W4, CCR. SHOULD ANY EXISTING CONDITIONS SUCH AS DETERIORATION OR NON-COMPLYING CONSTRUCTION BE DISCOVERED WHICH IS NOT COVERED BY THE CONTRACT DOCUMENTS WHEREIN THE FINISHED WORK WILL NOT COMPLY WITH TITLE 24, CCR, A CONSTRUCTION CHANGE DOCUMENT (CCD), OR A SEPARATE SET OF PLANS AND SPECIFICATIONS, DETAILING AND SPECIFYING THE REQUIRED WORK SHALL BE SUBMITTED TO AND APPROVED BY DSA BEFORE PROCEEDING WITH THE WORK. (SECTION 4-317 (C), PART 1, TITLE 24,
- 17. GRADING PLANS, DRAINAGE IMPROVEMENTS, ROAD AND ACCESS REQUIREMENTS AND ENVIRONMENTAL HEALTH CONSIDERATIONS SHALL COMPLY WITH ALL LOCAL ORDINANCES.
- 18. KITCHEN WILL BE USED MAINLY FOR REHEATING, MINIMAL TO NO FOOD PREPARATION WILL BE DONE IN LOCATION. TYPE II HOOD TO BE INSTALLED.
- 19. REFER TO PLUMBING PLANS FOR WATER HEATER ANCHORAGE DETAILS.
- 20. FLOOR DRAIN FOR MAINTENANCE ONLY.

**IDENTIFICATION STAMP** DIV. OF THE STATE ARCHITECT APP: 03-122151 INC: REVIEWED FOR SS 🗹 FLS 🗹 ACS 🗹 DATE: 11/02/2022

## abode communities architecture

PROJECT:

#### LAEP EARLY CHILDHOOD CENTER

13928 KORNBLUM AVE. HAWTHORNE, CA 90250

CLIENT:

**Los Angeles Education Partnership** 1541 Wilshire Blvd., Suite 200

Los Angeles, CA 90017 T: 213.622.5237 ARCHITECT: **Abode Communities** 

1149 S. Hill Street, Suite 700 Los Angeles, CA 90015 T: 213.629.2702

CONSULTANTS: <u>CIVIL</u>


**Breen Engineering** 1983 W. 190th St., Suite 200 Torrance, CA 90504 T: 310.464.8404

MECHANICAL/ **ELECTRICAL/ PLUMBING** Breen Engineering 1983 W. 190th St., Suite 200 Torrance, CA 90504 T: 310.464.8404

STRUCTURAL **Breen Engineering** 1983 W. 190th St., Suite 200 Torrance, CA 90504

#### DSA APPLICATION NUMBER: 03-122151

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#### **KEYNOTES**

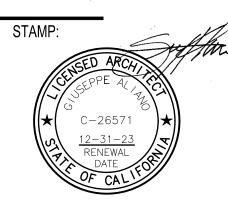- 1 NEW RAILING, REFER TO STRUCTURAL PLANS.
- NEW 38"X40" CONCRETE FAD TO AGGS....... HEATER CLOSET. REFER TO PLUMBING DRAWINGS NEW 38"X40" CONCRETE PAD TO ACCOMMODATE NEW WATER
- 3 EXISTING IDF CLOSET
- 4 EXISTING 8 FT. HIGH CHAIN LINK FENCE

DATE REV PROGRESS SET 02.01.22 DSA PROGRESS SET 03.02.22 DSA APPLICATION SET 04.01.22 DSA BACK-CHECK SET 10.05.22

DSA BACK-CHECK SET 10.24.22 DSA BACK-CHECK SET 11.01.22


SHEET NAME: **BUNGALOW 04 FLOOR PLAN** 

SHEET NUMBER:

A2.04

			AF	PPLIANCE	SCHEDU	LE		
NO		DIMENSIONS				MODEL	201.05	
NO TYPE		WIDTH	DEPTH	HEIGHT	MRF	MODEL	COLOR	ADDITIONAL ITEMS/COMMENTS
AP C01	COOKTOP	13.38"	20.5"	2.25"	SUMMIT	INDUCTION STOVE SINC2B120	BLACK	-
AP C02	OVEN	30"	24.75"	29"	FRIGIDAIRE	OVEN FFEW3026T D / S / W / B	STAINLESS STEEL	SELF CLEANING
AP C03	RANGEHOOD	30"	-	-	AIRKING	ESADA 30" WITH WALL SWITCH	STAINLESS STEEL	-
AP C04	KITCHEN REFRIGERATOR	82.5"	32.25"	54"	MOTAK	MSD-2DR-BAL-54-X	STAINLESS STEEL	-
AP C05	CLASSROOM REFRIGERATOR	23.63"	22.63"	32"	SUMMIT	AL54	STAINLESS STEEL	-
AP C06	STERILIZER	53.63"	31.07"	76.19"	ZONO	SC 2 WH	STAINLESS STEEL	-
AP C07	WASHER	28"	32"	39.75"	GE	GFW550SSN/SPN	WHITE	-
AP C08	ELECTRIC DRYER	28"	32"	39.75"	GE	GFD55ESSN	WHITE	-
AP C09	DISHWASHER	23.75"	23.5"	32.25"	GE	GDT225SSLSS	STAINLESS STEEL	-
	-	-	-	-			-	-

			PLUMI	BING FIXTI	JRE SCHE	DULE		
NO	ТҮРЕ	DIMENSIONS WIDTH LENGTH DEPTH			MFR	MODEL	COLOR	ADDITIONAL ITEMS/COMMENTS
WC 1	FLOOR MOUNTED WATER CLOSET	-	-	-	SLOAN	ST-2309 JUNIOR TOILET	WHITE	-
WC 2	FLOOR MOUNTED WATER CLOSET (ADA)	-	-	-	SLOAN	ST-2309 JUNIOR TOILET	WHITE	-
WC 3	FLOOR MOUNTED WATER CLOSET (ADA)	-	-	-	SLOAN	WETS 2020.1304-1.28 ES-S TMO	WHITE	-
L 1	TROUGH LAVATORY	-	-	-	KOHLER	BROCKWAY MODEL K-3200 UTILITY SINK	WHITE	PROVIDE WITH KOHLER TRITION BOWE CANNOCK MODEL #K-730T70-4AJR BATHROOM SINK FAUCET, GOOSENECK SPOUT WITH ROSESPRAY, WALL-TO-SPOUT OUTLET, LEVER HANDLES, 1.2 GPM. PROVIDE TAILPIECE WITH INSULATED COVER.
<u>L</u> 2	WALL HUNG LAVATORY	-	-	-	AMERICAN STANDARD	MURRO 0954.004EC #0059.020EC (SHROUD/KNEE CONTACT GUARD)	WHITE	PROVIDE OPTIONAL SHROUD OVER P-TRAP AND FAUCET DELTA MODEL #86T1153
S 1	CLASSROOM CHANGING AREA SINK	-	-	-	JUST	1821-A	STAINLESS STEEL	PROVIDE WITH DELTA TRINSIC MODEL #9159-DST KITCHEN SINK FAUCET, SINGLE HANDLE DECK MOUNTED, WITH 2-FUNCTION PULL-DOWN SPRAYER, 1.8 GPM. PROVIDED WITH INSULATED COVER, SUPPLIES, STOPS AND P-TRAP.
S 2	CLASSROOM FOOD PREP SINK	-	-	-	JUST	1632-A	STAINLESS STEEL	PROVIDE WITH DELTA TRINSIC  MODEL #9159-DST KITCHEN SINK FAUCET, SINGLE HANDLE DECK MOUNTED, WITH 2-FUNCTION PULL-DOWN SPRAYER, 1.8 GPM. PROVIDED WITH INSULATED COVER, SUPPLIES, STOPS AND P-TRAP.
S 3	ADMIN. KITCHEN SINK	-	-	-	JUST	1632-A	STAINLESS STEEL	PROVIDE WITH DELTA TRINSIC  MODEL #9159-DST KITCHEN SINK FAUCET, SINGLE HANDLE DECK MOUNTED, WITH 2-FUNCTION PULL-DOWN SPRAYER, 1.8 GPM. PROVIDED WITH INSULATED COVER, SUPPLIES, STOPS AND P-TRAP.
S 4	MOP SINK	-	-	-	-	-	WHITE	-

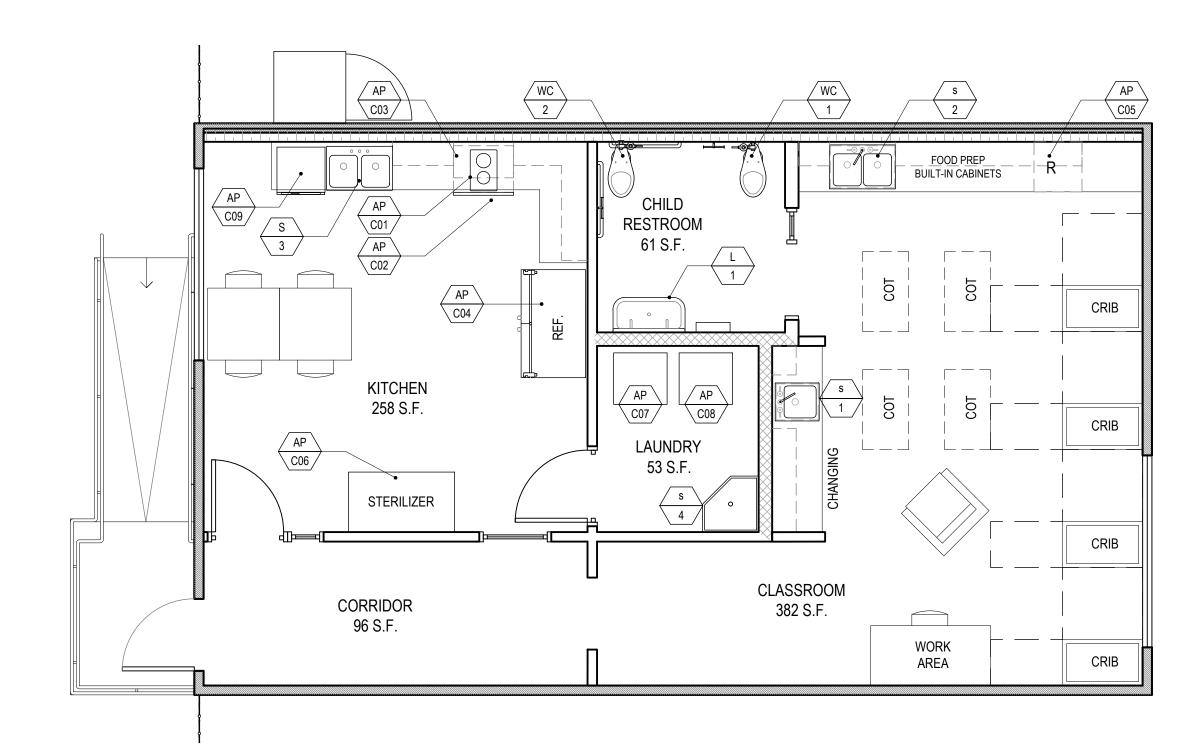

**BUNGALOW 01** INFANT (0-12 MONTHS) TOTAL NET SF: 850 SF

ADMINISTRATION KITCHEN/LAUNDRY

BUNGALOW 01 FF&E PLAN

SCALE: 1/4" = 1'-0"



## NOTES

1. FURNITURE BY OWNER AND NOT IN SCOPE

#### IDENTIFICATION STAMP DIV. OF THE STATE ARCHITECT APP: 03-122151 INC: REVIEWED FOR SS 🗹 FLS 🗹 ACS 🗹 DATE: 11/02/2022

# abode communities architecture

#### LAEP EARLY CHILDHOOD CENTER

13928 KORNBLUM AVE. HAWTHORNE, CA 90250

#### **Los Angeles Education Partnership** 1541 Wilshire Blvd., Suite 200

Los Angeles, CA 90017 T: 213.622.5237 ARCHITECT:

Abode Communities 1149 S. Hill Street, Suite 700 Los Angeles, CA 90015 T: 213.629.2702

CONSULTANTS:


**Breen Engineering** 1983 W. 190th St., Suite 200 Torrance, CA 90504 T: 310.464.8404

MECHANICAL/ ELECTRICAL/ PLUMBING Breen Engineering 1983 W. 190th St., Suite 200 Torrance, CA 90504 T: 310.464.8404

**STRUCTURAL** Breen Engineering 1983 W. 190th St., Suite 200 Torrance, CA 90504 T: 310.464.8404

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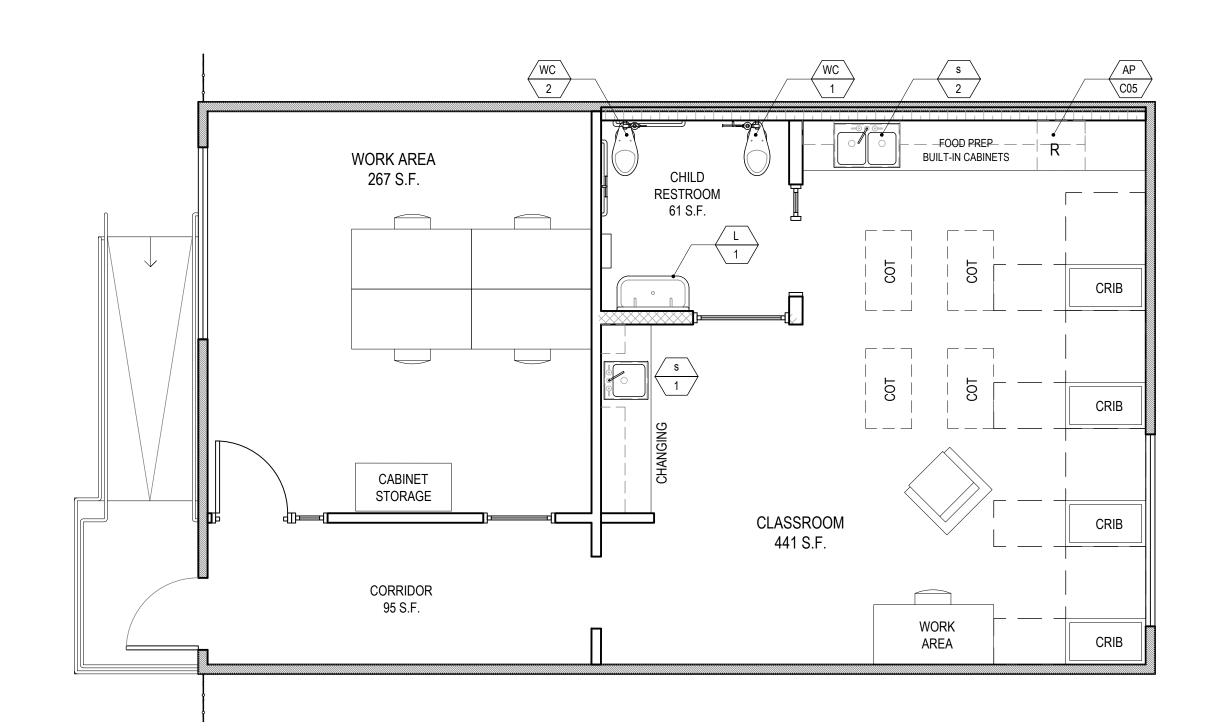
> SHEET NAME: **BUNGALOW 01** FF&E PLAN

SHEET NUMBER:

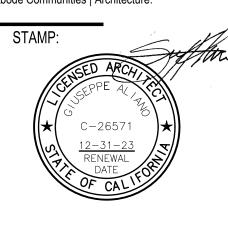A2.11

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NO	TYPE		DIMENSIONS	Γ	MRF	MODEL	COLOR	ADDITIONAL ITEMO/COMMENTO
NO	TTPE	WIDTH	DEPTH			COLOR	ADDITIONAL ITEMS/COMMENTS	
AP C01	COOKTOP	13.38"	20.5"	2.25"	SUMMIT	INDUCTION STOVE SINC2B120	BLACK	-
AP C02	OVEN	30"	24.75"	29"	FRIGIDAIRE	OVEN FFEW3026T D / S / W / B	STAINLESS STEEL	SELF CLEANING
AP C03	RANGEHOOD	30"	-	-	AIRKING	ESADA 30" WITH WALL SWITCH	STAINLESS STEEL	-
AP C04	KITCHEN REFRIGERATOR	82.5"	32.25"	54"	MOTAK	MSD-2DR-BAL-54-X	STAINLESS STEEL	-
AP C05	CLASSROOM REFRIGERATOR	23.63"	22.63"	32"	SUMMIT	AL54	STAINLESS STEEL	-
AP C06	STERILIZER	53.63"	31.07"	76.19"	ZONO	SC 2 WH	STAINLESS STEEL	-
AP C07	WASHER	28"	32"	39.75"	GE	GFW550SSN/SPN	WHITE	-
AP C08	ELECTRIC DRYER	28"	32"	39.75"	GE	GFD55ESSN	WHITE	-
AP C09	DISHWASHER	23.75"	23.5"	32.25"	GE	GDT225SSLSS	STAINLESS STEEL	-
	-	-	-	-			-	-

			PLUM	BING FIXTI	JRE SCHE	DULE		
NO	TYPE	WIDTH	DIMENSIONS LENGTH	DEPTH	MFR	MODEL	COLOR	ADDITIONAL ITEMS/COMMENTS
WC 1	FLOOR MOUNTED WATER CLOSET	-	-	-	SLOAN	ST-2309 JUNIOR TOILET	WHITE	-
WC 2	FLOOR MOUNTED WATER CLOSET (ADA)	-	-	-	SLOAN	ST-2309 JUNIOR TOILET	WHITE	-
WC 3	FLOOR MOUNTED WATER CLOSET (ADA)	-	-	-	SLOAN	WETS 2020.1304-1.28 ES-S TMO	WHITE	-
L 1	TROUGH LAVATORY	-	-	-	KOHLER	BROCKWAY MODEL K-3200 UTILITY SINK	WHITE	PROVIDE WITH KOHLER TRITION BOWE CANNOCK MODEL #K-730T70-4AJR BATHROOM SINK FAUCET, GOOSENECK SPOUT WITH ROSESPRAY, WALL-TO-SPOUT OUTLET, LEVER HANDLES, 1.2 GPM. PROVIDE TAILPIECE WITH INSULATED COVER.
L 2	WALL HUNG LAVATORY	-	-	-	AMERICAN STANDARD	MURRO 0954.004EC #0059.020EC (SHROUD/KNEE CONTACT GUARD)	WHITE	PROVIDE OPTIONAL SHROUD OVER P-TRAP AND FAUCET DELTA MODEL #86T1153
S 1	CLASSROOM CHANGING AREA SINK	-	-	-	JUST	1821-A	STAINLESS STEEL	PROVIDE WITH DELTA TRINSIC MODEL #9159-DST KITCHEN SINK FAUCET, SINGLE HANDLE DECK MOUNTED, WITH 2-FUNCTION PULL-DOWN SPRAYER, 1.8 GPM. PROVIDED WITH INSULATED COVER, SUPPLIES, STOPS AND P-TRAP.
\( \begin{pmatrix} \mathbb{S} \\ \ \ \ \ \ \ \ \ \ \ \ \ \ \ \ \ \	CLASSROOM FOOD PREP SINK	-	-	-	JUST	1632-A	STAINLESS STEEL	PROVIDE WITH DELTA TRINSIC  MODEL #9159-DST KITCHEN SINK FAUCET, SINGLE HANDLE DECK MOUNTED, WITH 2-FUNCTION PULL-DOWN  SPRAYER, 1.8 GPM. PROVIDED WITH INSULATED COVER, SUPPLIES, STOPS AND P-TRAP.
<b>S</b> 3	ADMIN. KITCHEN SINK	-	-	-	JUST	1632-A	STAINLESS STEEL	PROVIDE WITH DELTA TRINSIC MODEL #9159-DST KITCHEN SINK FAUCET, SINGLE HANDLE DECK MOUNTED, WITH 2-FUNCTION PULL-DOWN SPRAYER, 1.8 GPM. PROVIDED WITH INSULATED COVER, SUPPLIES, STOPS AND P-TRAP.
$\left\langle \begin{array}{c} \mathbb{S} \\ 4 \end{array} \right\rangle$	MOP SINK	-	-	-	-	-	WHITE	-



BUNGALOW 02 INFANT/MOBILE (0-12 MONTHS) TOTAL NET SF: 864 SF

ADMINISTRATION WORK AREA/ADULT RESTROOM

BUNGALOW 02 FF&E PLAN
SCALE: 1/4" = 1'-0"



IDENTIFICATION STAMP
DIV. OF THE STATE ARCHITECT

APP: 03-122151 INC:

REVIEWED FOR

SS FLS ACS D

DATE: 11/02/2022

# abode communities architecture

PROJECT:

## LAEP EARLY CHILDHOOD CENTER

13928 KORNBLUM AVE. HAWTHORNE, CA 90250

CLIENT:

### Los Angeles Education Partnership

1541 Wilshire Blvd., Suite 200 Los Angeles, CA 90017 T: 213.622.5237

ARCHITECT:

Abode Communities 1149 S. Hill Street, Suite 700 Los Angeles, CA 90015 T: 213.629.2702

CONSULTANTS:

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1983 W. 190th St., Suite 200
Torrance, CA 90504
T: 310.464.8404

MECHANICAL/ ELECTRICAL/ PLUMBING Breen Engineering 1983 W. 190th St., Suite 200 Torrance, CA 90504 T: 310.464.8404

STRUCTURAL

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1. FURNITURE BY OWNER AND NOT IN SCOPE

NOTES

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PROGRESS SET 02.01.22

DSA PROGRESS SET 03.02.22

DSA APPLICATION SET 04.01.22

DSA BACK-CHECK SET 10.05.22

DSA BACK-CHECK SET 10.24.22

DSA BACK-CHECK SET 11.01.22


SHEET NAME:
BUNGALOW 02
FF&E PLAN

SHEET NUMBER:

A2.12

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			DIMENSIONS					
NO	TYPE	WIDTH	DEPTH	HEIGHT	MRF	MODEL	COLOR	ADDITIONAL ITEMS/COMMENTS
AP C01	СООКТОР	13.38"	20.5"	2.25"	SUMMIT	INDUCTION STOVE SINC2B120	BLACK	-
AP C02	OVEN	30"	24.75"	29"	FRIGIDAIRE	OVEN FFEW3026T D / S / W / B	STAINLESS STEEL	SELF CLEANING
AP C03	RANGEHOOD	30"	-	-	AIRKING	ESADA 30" WITH WALL SWITCH	STAINLESS STEEL	-
AP C04	KITCHEN REFRIGERATOR	82.5"	32.25"	54"	MOTAK	MSD-2DR-BAL-54-X	STAINLESS STEEL	-
AP C05	CLASSROOM REFRIGERATOR	23.63"	22.63"	32"	SUMMIT	AL54	STAINLESS STEEL	-
AP C06	STERILIZER	53.63"	31.07"	76.19"	ZONO	SC 2 WH	STAINLESS STEEL	-
AP C07	WASHER	28"	32"	39.75"	GE	GFW550SSN/SPN	WHITE	-
AP C08	ELECTRIC DRYER	28"	32"	39.75"	GE	GFD55ESSN	WHITE	-
AP C09	DISHWASHER	23.75"	23.5"	32.25"	GE	GDT225SSLSS	STAINLESS STEEL	-
	-	-	-	-			-	-

			PLUM	BING FIXTU	JRE SCHE	DULE		
NO	TYPE	WIDTH	DIMENSIONS LENGTH	DEPTH	MFR	MODEL	COLOR	ADDITIONAL ITEMS/COMMENTS
WC 1	FLOOR MOUNTED WATER CLOSET	- -	-	-	SLOAN	ST-2309 JUNIOR TOILET	WHITE	-
WC 2	FLOOR MOUNTED WATER CLOSET (ADA)	-	-	-	SLOAN	ST-2309 JUNIOR TOILET	WHITE	-
WC 3	FLOOR MOUNTED WATER CLOSET (ADA)	-	-	-	SLOAN	WETS 2020.1304-1.28 ES-S TMO	WHITE	-
L 1	TROUGH LAVATORY	-	-	-	KOHLER	BROCKWAY MODEL K-3200 UTILITY SINK	WHITE	PROVIDE WITH KOHLER TRITION BOWE CANNOCK MODEL #K-730T70-4AJR BATHROOM SINK FAUCET, GOOSENECK SPOUT WITH ROSESPRAY, WALL-TO-SPOUT OUTLET, LEVER HANDLES, 1.2 GPM.
<u>L</u> 2	WALL HUNG LAVATORY	-	-	-	AMERICAN STANDARD	MURRO 0954.004EC #0059.020EC (SHROUD/KNEE CONTACT GUARD)	WHITE	PROVIDE TAILPIECE WITH INSULATED COVER.  PROVIDE OPTIONAL SHROUD OVER P-TRAP AND FAUCET DELTA MODEL #86T1153
S 1	CLASSROOM CHANGING AREA SINK	-	-	-	JUST	1821-A	STAINLESS STEEL	PROVIDE WITH DELTA TRINSIC MODEL #9159-DST KITCHEN SINK FAUCET, SINGLE HANDLE DECK MOUNTED, WITH 2-FUNCTION PULL-DOWN SPRAYER, 1.8 GPM. PROVIDED WITH INSULATED COVER, SUPPLIES, STOPS AND P-TRAP.
S 2	CLASSROOM FOOD PREP SINK	-	-	-	JUST	1632-A	STAINLESS STEEL	PROVIDE WITH DELTA TRINSIC  MODEL #9159-DST KITCHEN SINK FAUCET, SINGLE HANDLE DECK MOUNTED, WITH 2-FUNCTION PULL-DOWN  SPRAYER, 1.8 GPM. PROVIDED WITH INSULATED COVER, SUPPLIES, STOPS AND P-TRAP.
S 3	ADMIN. KITCHEN SINK	-	-	-	JUST	1632-A	STAINLESS STEEL	PROVIDE WITH DELTA TRINSIC  MODEL #9159-DST KITCHEN SINK FAUCET, SINGLE HANDLE DECK MOUNTED, WITH 2-FUNCTION PULL-DOWN SPRAYER, 1.8 GPM. PROVIDED WITH INSULATED COVER, SUPPLIES, STOPS AND P-TRAP.
S 4	MOP SINK	-	-	-	-	-	WHITE	-

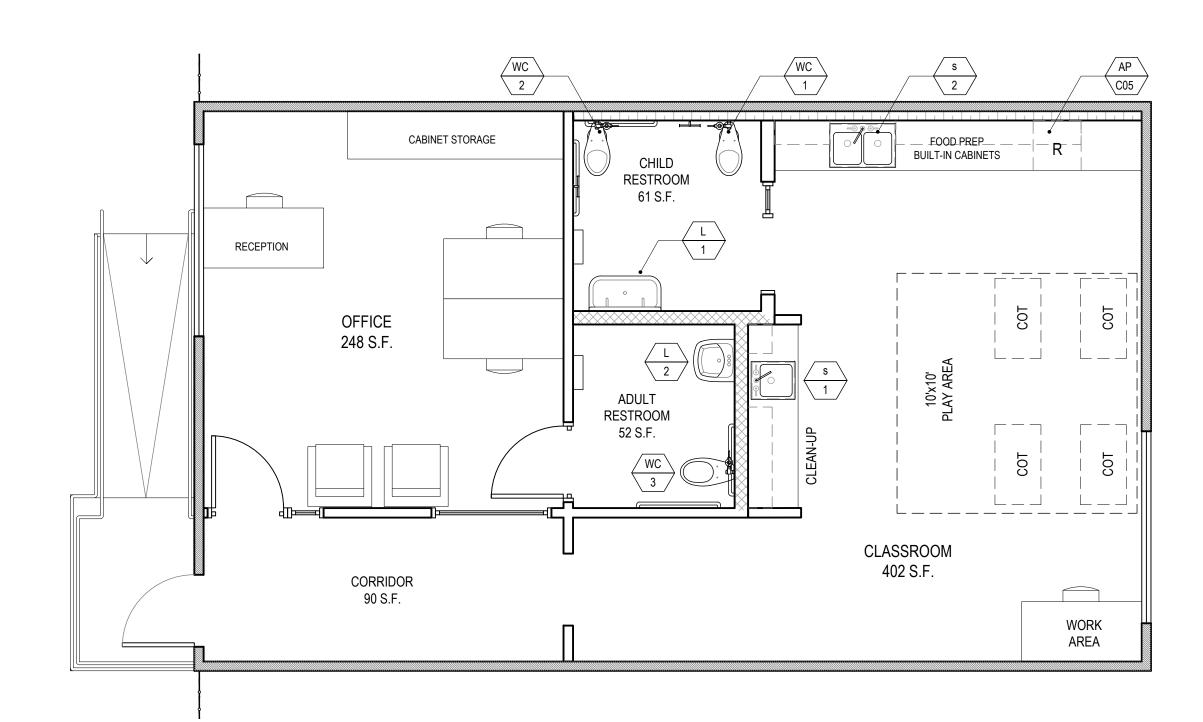

BUNGALOW 03 CLASSROOM 1(1-2 YEARS) TOTAL NET SF: 853 SF

ADMINISTRATION RECEPTION/ WORK AREA

#### NOTES

FURNITURE BY OWNER AND NOT IN SCOPE

# IDENTIFICATION STAMP DIV. OF THE STATE ARCHITECT APP: 03-122151 INC: REVIEWED FOR SS FLS ACS DATE: 11/02/2022

# abode communities architecture

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## LAEP EARLY CHILDHOOD CENTER

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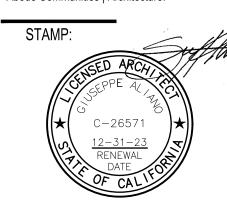
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DSA APPLICATION SET 04.01.22
DSA BACK-CHECK SET 10.05.22
DSA BACK-CHECK SET 10.24.22
DSA BACK-CHECK SET 11.01.22

SHEET NAME:
BUNGALOW 03
FF&E PLAN

SHEET NUMBER:
A2.13


BUNGALOW 03 FF&E PLAN

SCALE: 1/4" = 1'-0"



			AF	PPLIANCE	SCHEDUL	.E		
			DIMENSIONS					
NO	TYPE	WIDTH	DEPTH	HEIGHT	MRF	MODEL	COLOR	ADDITIONAL ITEMS/COMMENTS
AP C01	СООКТОР	13.38"	20.5"	2.25"	SUMMIT	INDUCTION STOVE SINC2B120	BLACK	-
AP C02	OVEN	30"	24.75"	29"	FRIGIDAIRE	OVEN FFEW3026T D / S / W / B	STAINLESS STEEL	SELF CLEANING
AP C03	RANGEHOOD	30"	-	-	AIRKING	ESADA 30" WITH WALL SWITCH	STAINLESS STEEL	-
AP C04	KITCHEN REFRIGERATOR	82.5"	32.25"	54"	MOTAK	MSD-2DR-BAL-54-X	STAINLESS STEEL	-
AP C05	CLASSROOM REFRIGERATOR	23.63"	22.63"	32"	SUMMIT	AL54	STAINLESS STEEL	-
AP C06	STERILIZER	53.63"	31.07"	76.19"	ZONO	SC 2 WH	STAINLESS STEEL	-
AP C07	WASHER	28"	32"	39.75"	GE	GFW550SSN/SPN	WHITE	-
AP C08	ELECTRIC DRYER	28"	32"	39.75"	GE	GFD55ESSN	WHITE	-
AP C09	DISHWASHER	23.75"	23.5"	32.25"	GE	GDT225SSLSS	STAINLESS STEEL	-
	-	-	-	-			-	-

			PLUMI	BING FIXTI	URE SCHE	DULE		
NO	ТҮРЕ	WIDTH	DIMENSIONS LENGTH	DEPTH	MFR	MODEL	COLOR	ADDITIONAL ITEMS/COMMENTS
WC 1	FLOOR MOUNTED WATER CLOSET	-	-	-	SLOAN	ST-2309 JUNIOR TOILET	WHITE	-
WC 2	FLOOR MOUNTED WATER CLOSET (ADA)	-	-	-	SLOAN	ST-2309 JUNIOR TOILET	WHITE	-
WC 3	FLOOR MOUNTED WATER CLOSET (ADA)	-	-	-	SLOAN	WETS 2020.1304-1.28 ES-S TMO	WHITE	-
L 1	TROUGH LAVATORY	-	-	-	KOHLER	BROCKWAY MODEL K-3200 UTILITY SINK	WHITE	PROVIDE WITH KOHLER TRITION BOWE CANNOCK MODEL #K-730T70-4AJR BATHROOM SINK FAUCET, GOOSENECK SPOUT WITH ROSESPRAY, WALL-TO-SPOUT OUTLET, LEVER HANDLES, 1.2 GPM. PROVIDE TAILPIECE WITH INSULATED COVER.
L 2	WALL HUNG LAVATORY	-	-	-	AMERICAN STANDARD	MURRO 0954.004EC #0059.020EC (SHROUD/KNEE CONTACT GUARD)	WHITE	PROVIDE OPTIONAL SHROUD OVER P-TRAP AND FAUCET DELTA MODEL #86T1153
⟨S 1	CLASSROOM CHANGING AREA SINK	-	-	-	JUST	1821-A	STAINLESS STEEL	PROVIDE WITH DELTA TRINSIC MODEL #9159-DST KITCHEN SINK FAUCET, SINGLE HANDLE DECK MOUNTED, WITH 2-FUNCTION PULL-DOWN SPRAYER, 1.8 GPM. PROVIDED WITH INSULATED COVER, SUPPLIES, STOPS AND P-TRAP.
\(\s\\\\\\\\\\\\\\\\\\\\\\\\\\\\\\\\\\	CLASSROOM FOOD PREP SINK	-	-	-	JUST	1632-A	STAINLESS STEEL	PROVIDE WITH DELTA TRINSIC  MODEL #9159-DST KITCHEN SINK FAUCET, SINGLE HANDLE DECK MOUNTED, WITH 2-FUNCTION PULL-DOWN  SPRAYER, 1.8 GPM. PROVIDED WITH INSULATED COVER, SUPPLIES, STOPS AND P-TRAP.
\(\begin{align*} S \\ 3 \end{align*}	ADMIN. KITCHEN SINK	-	-	-	JUST	1632-A	STAINLESS STEEL	PROVIDE WITH DELTA TRINSIC MODEL #9159-DST KITCHEN SINK FAUCET, SINGLE HANDLE DECK MOUNTED, WITH 2-FUNCTION PULL-DOWN SPRAYER, 1.8 GPM. PROVIDED WITH INSULATED COVER, SUPPLIES, STOPS AND P-TRAP.
S 4	MOP SINK	-	-	-	-	-	WHITE	-

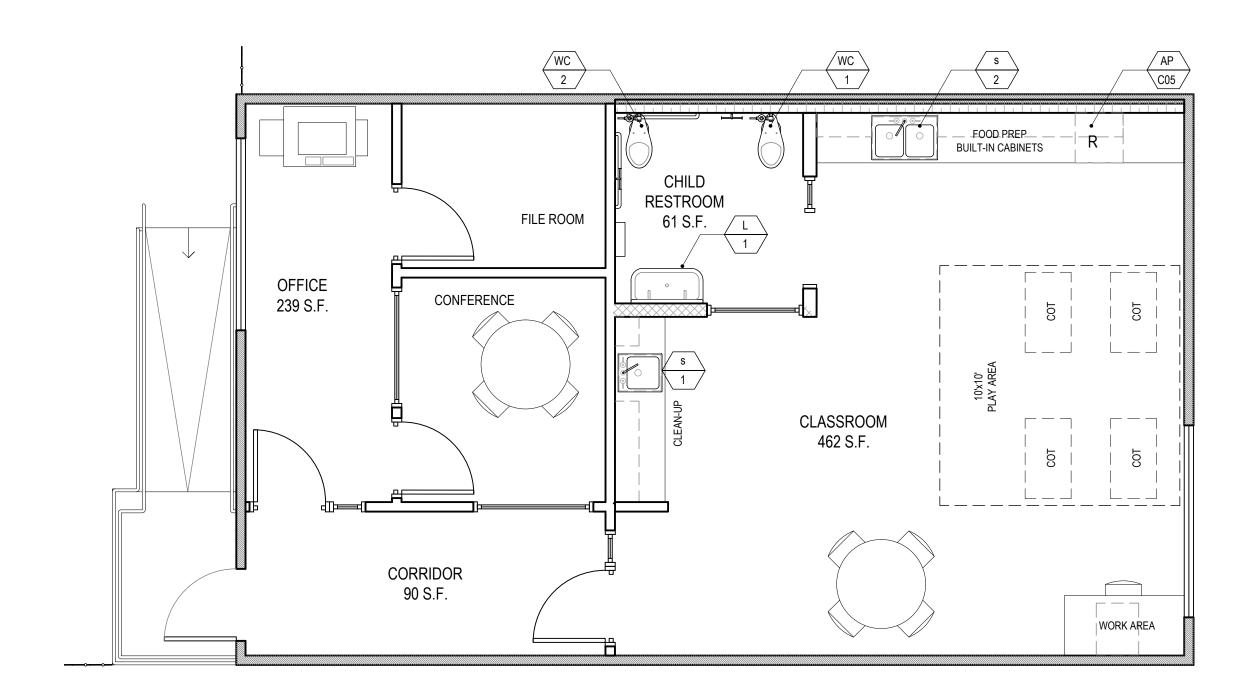

**BUNGALOW 04** CLASSROOM 2 (2-3 YEARS) TOTAL NET SF: 852 SF

ADMINISTRATION

RECEPTION/WORK AREA

NOTES

1. FURNITURE BY OWNER AND NOT IN SCOPE

IDENTIFICATION STAMP DIV. OF THE STATE ARCHITECT APP: 03-122151 INC: REVIEWED FOR SS 🗹 FLS 🗹 ACS 🗹 DATE: 11/02/2022

## abode communities architecture

#### LAEP EARLY CHILDHOOD CENTER

13928 KORNBLUM AVE. HAWTHORNE, CA 90250

CLIENT:

Los Angeles Education **Partnership** 

1541 Wilshire Blvd., Suite 200 Los Angeles, CA 90017 T: 213.622.5237

ARCHITECT:

Abode Communities 1149 S. Hill Street, Suite 700 Los Angeles, CA 90015 T: 213.629.2702

CONSULTANTS:

**Breen Engineering** 1983 W. 190th St., Suite 200 Torrance, CA 90504 T: 310.464.8404

MECHANICAL/ ELECTRICAL/ PLUMBING Breen Engineering 1983 W. 190th St., Suite 200 Torrance, CA 90504 T: 310.464.8404

**STRUCTURAL** Breen Engineering 1983 W. 190th St., Suite 200 Torrance, CA 90504 T: 310.464.8404

#### DSA APPLICATION NUMBER: 03-122151

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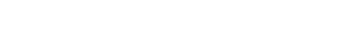
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DATE REV PROGRESS SET 02.01.22 DSA PROGRESS SET 03.02.22 DSA APPLICATION SET 04.01.22 DSA BACK-CHECK SET 10.05.22 DSA BACK-CHECK SET 10.24.22 DSA BACK-CHECK SET 11.01.22

SHEET NAME:

**BUNGALOW 04** FF&E PLAN

SHEET NUMBER: A2.14



BUNGALOW 04 FF&E PLAN

SCALE: 1/4" = 1'-0"





## NOTES

T.O. ROOF

FINISH FLOOR

4

- 1. ALL LOCATIONS OF FEATURES TO BE VERIFIED IN FIELD.
- ANNULAR SPACES AROUND PIPES, ELECTRIC CABLES, CONDUITS, OR OTHER OPENINGS IN THE SOLE/BOTTOM PLATES AT EXTERIOR WALLS SHALL BE PROTECTED AGAINST THE PASSAGE OF RODENTS BY CLOSING SUCH OPENINGS WITH CEMENT MORTAR, CONCRETE MASONRY, OR METAL PLATES. PIPING PRONE TO CORROSION SHALL BE PROTECTED.
- PATCH AND REPAIR ANY NEW OPENINGS AND REPAIRED WALL SURFACES, PRIME AND PAINT NEW AREAS TO MATCH EXISTING EXTERIOR COLORS.

IDENTIFICATION STAMP DIV. OF THE STATE ARCHITECT APP: 03-122151 INC: REVIEWED FOR SS 🗹 FLS 🗹 ACS 🗹 DATE: 11/02/2022

## abode communities architecture

PROJECT:

13928 KORNBLUM AVE. HAWTHORNE, CA 90250

CLIENT:

#### Los Angeles Education

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**STRUCTURAL** 1983 W. 190th St., Suite 200 Torrance, CA 90504

#### LAEP EARLY CHILDHOOD CENTER

Partnership


1149 S. Hill Street, Suite 700 Los Angeles, CA 90015 T: 213.629.2702

MECHANICAL/

**Breen Engineering** T: 310.464.8404

## KEYNOTES

- 1 EXISTING EXTERIOR WALL SURFACE
- 2 EXISTING 26 GA. GUTTER
- 3 EXISTING DOWNSPOUT
- 4 EXISTING MECHANICAL UNIT
- 5 EXISTING FOUNDATION VENT
- 6 EXISTING 22 GA. INTERLOCKING CLASS A ROOF PANELS
- 7 EXISTING WALL PACK LIGHT FIXTURE
- 8 NEW RAILING, REFER TO STRUCTURAL DRAWINGS.

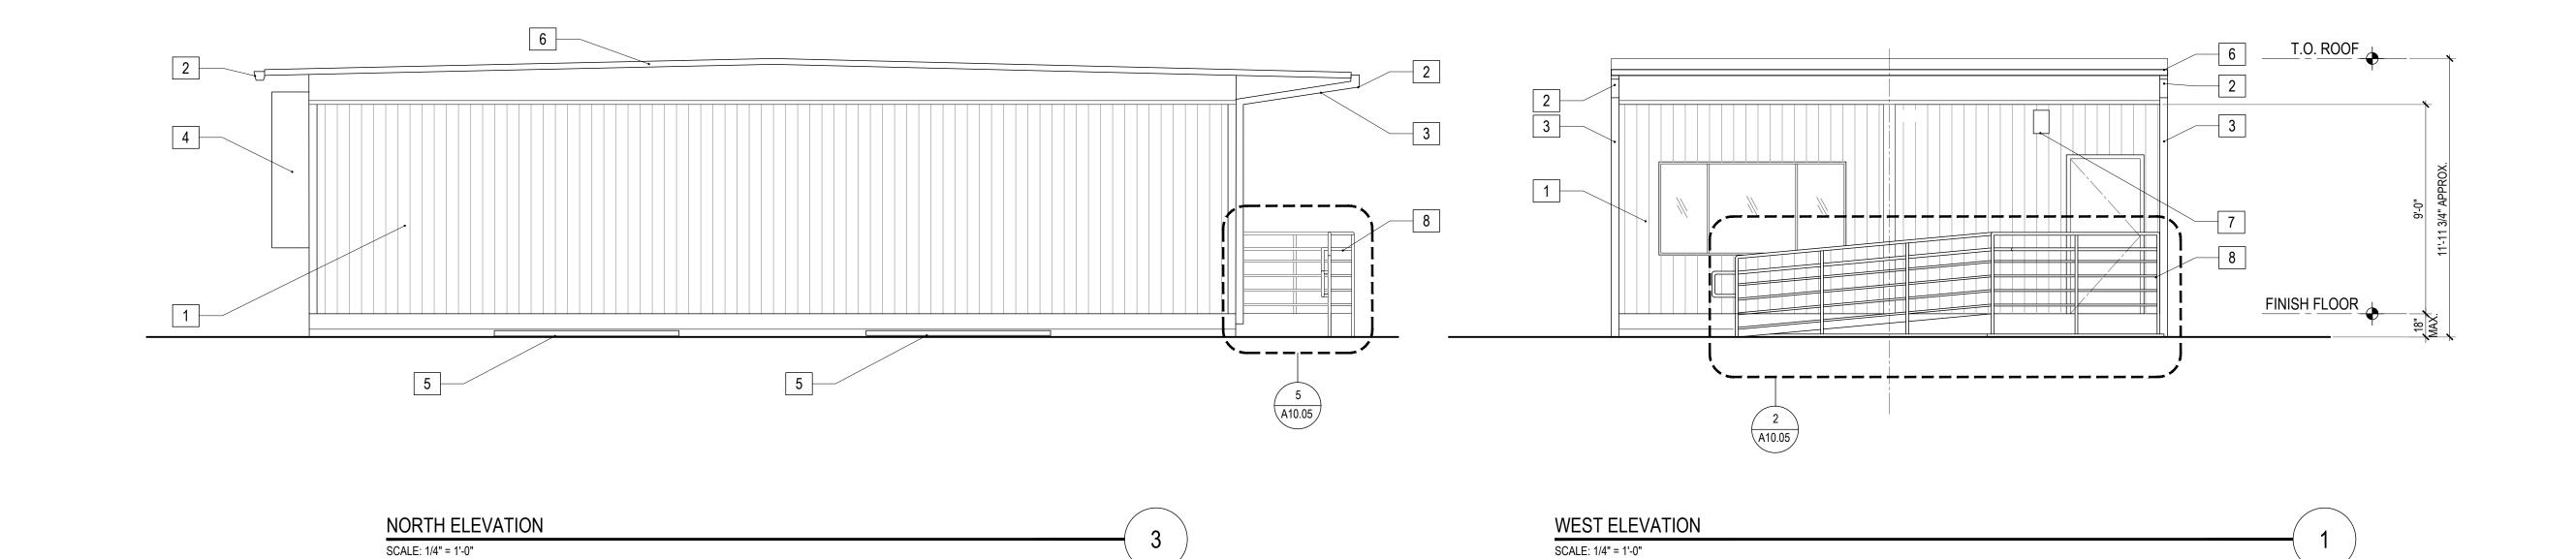

8

4 A10.05

SOUTH ELEVATION

SCALE: 1/4" = 1'-0"

3


1

EAST ELEVATION

SCALE: 1/4" = 1'-0"

#### DSA APPLICATION NUMBER: 03-122151

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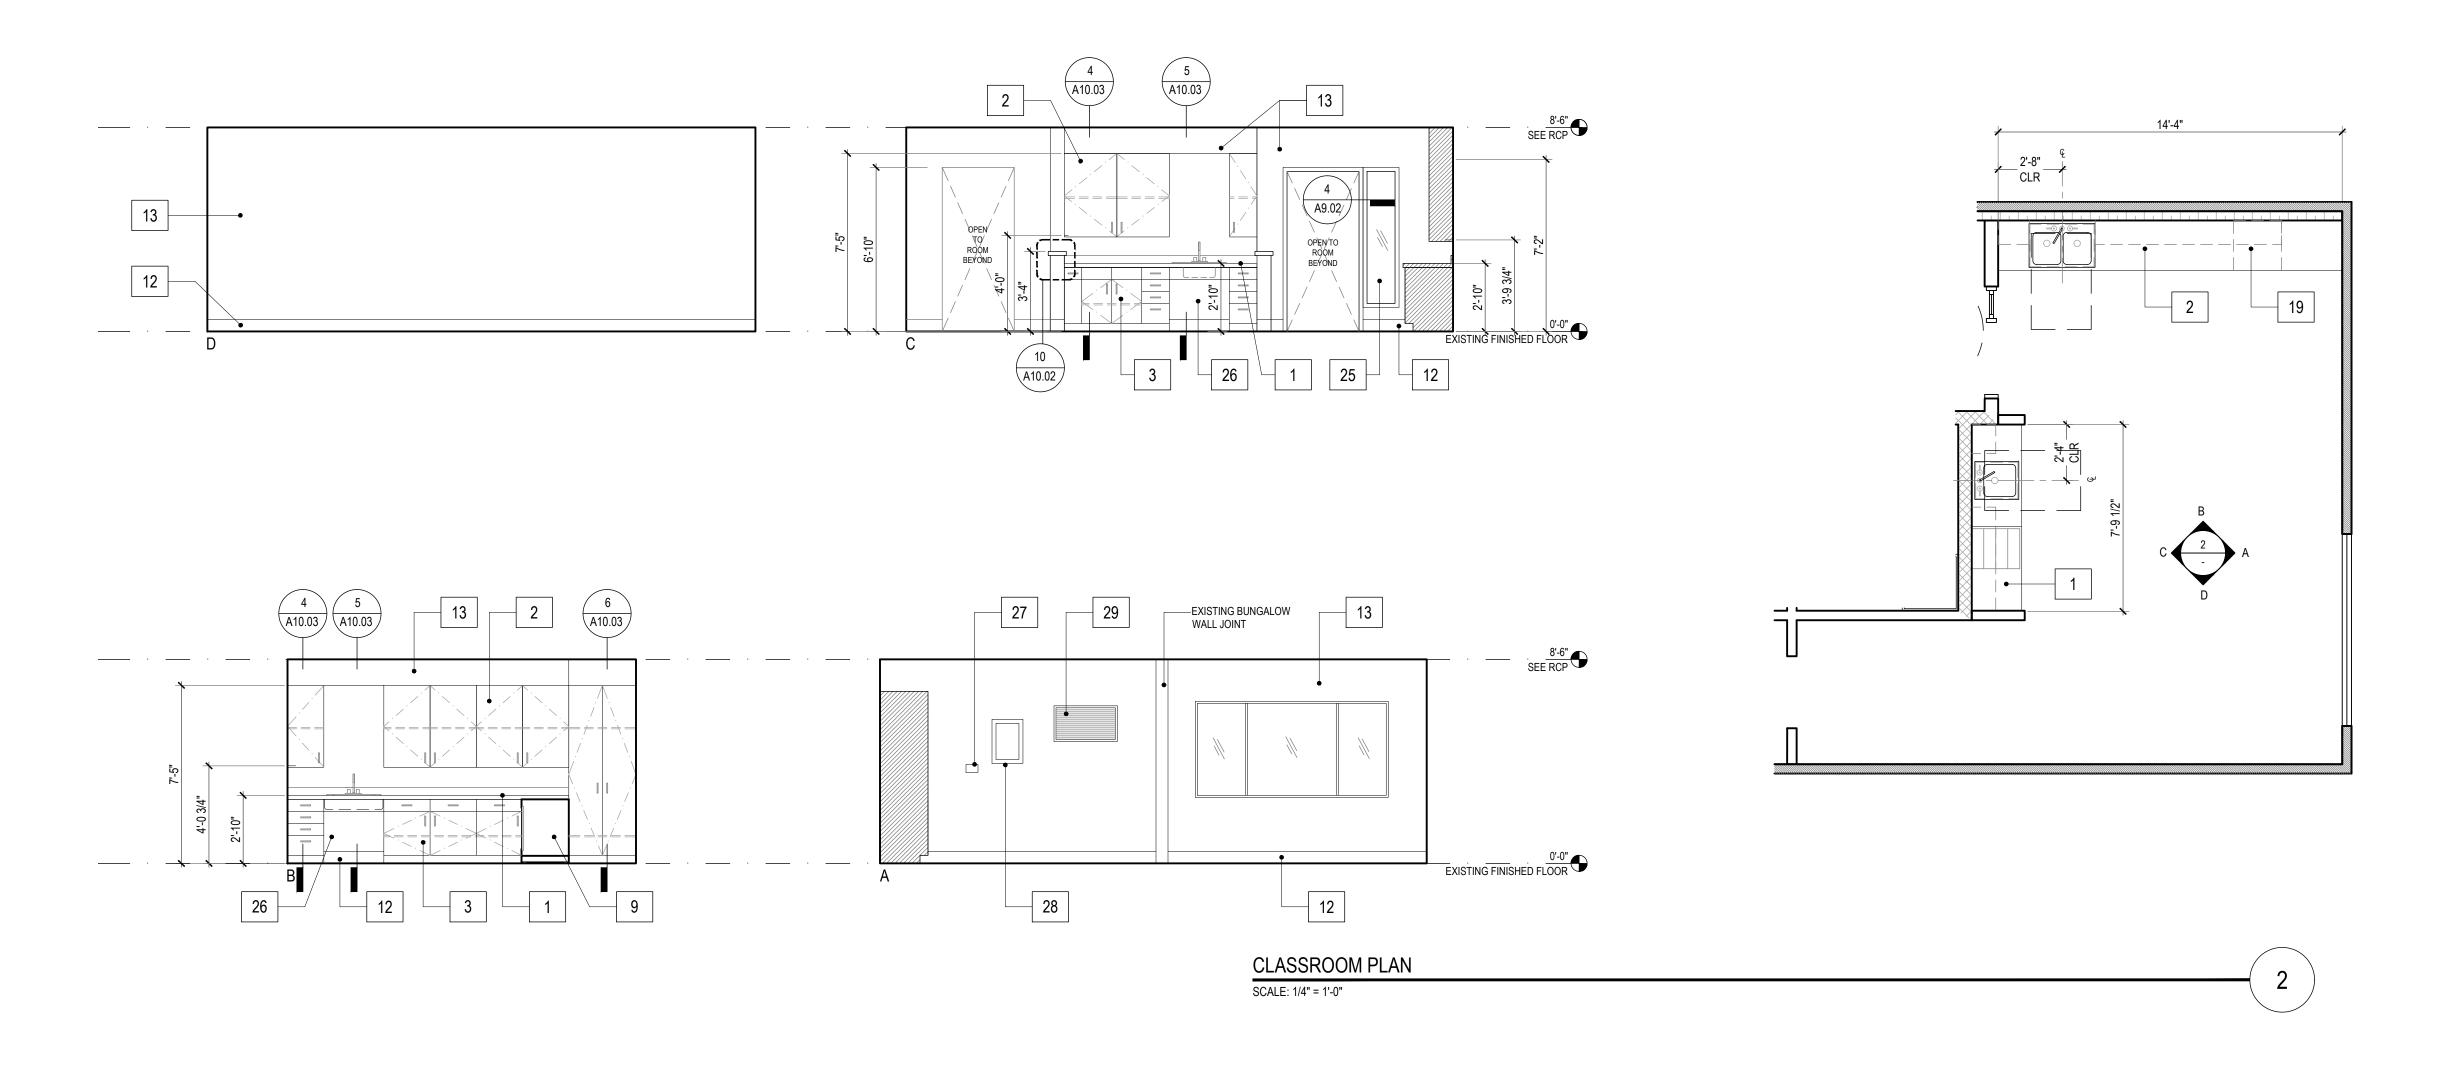


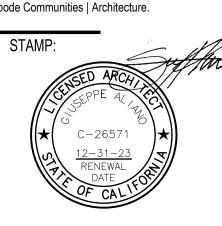·		DATE	RE\
	PROGRESS SET	02.01.22	
	DSA PROGRESS SET	03.02.22	
	DSA APPLICATION SET	04.01.22	
	DSA BACK-CHECK SET	10.05.22	
	DSA BACK-CHECK SET	10.24.22	
	DSA BACK-CHECK SET	11.01.22	


SHEET NAME:
EXTERIOR ELEVATIONS


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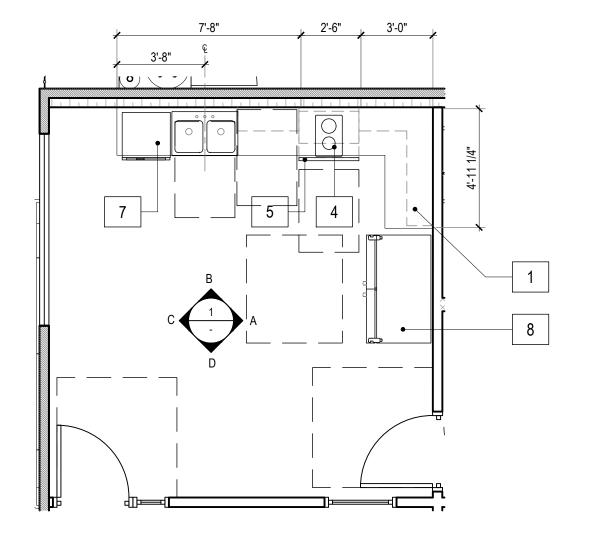
A3.01



SCALE: 1/4" = 1'-0"



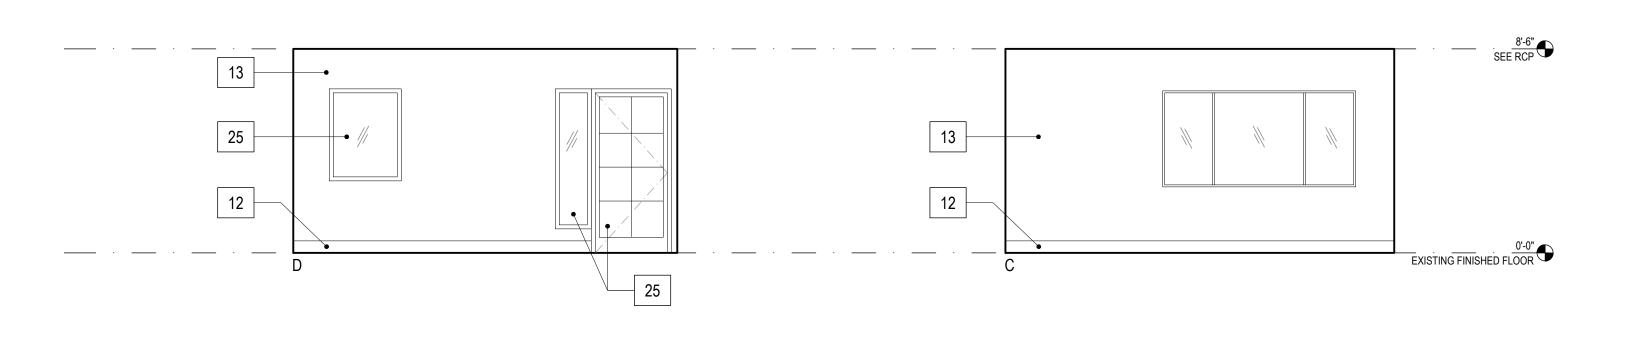

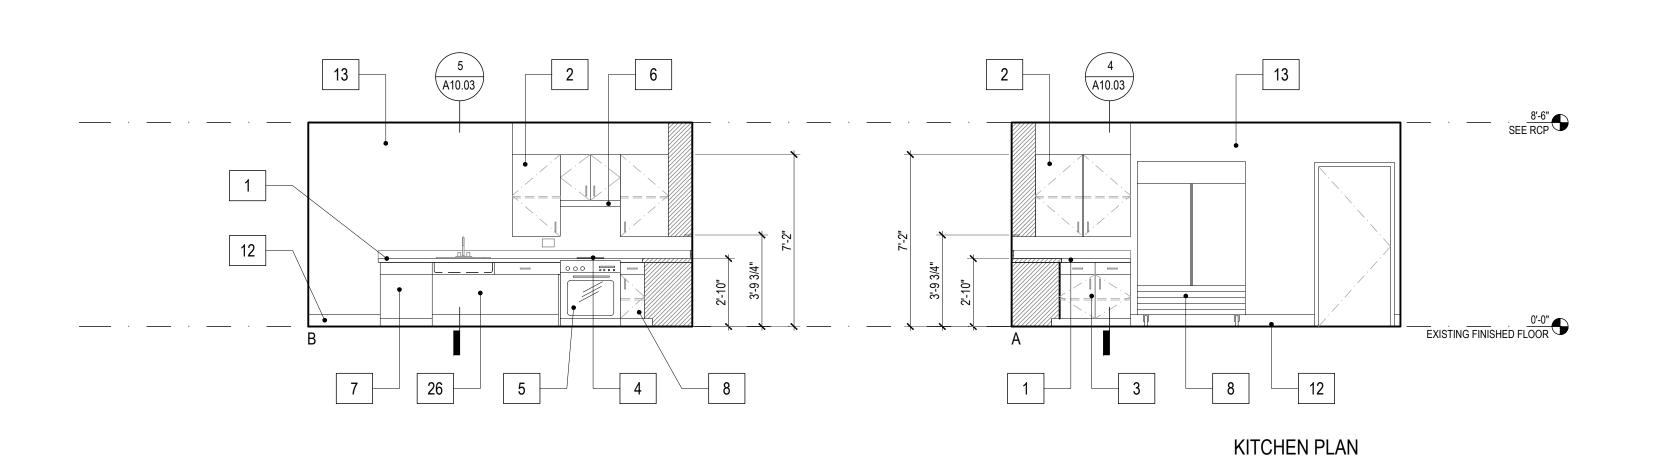

#### **KEYNOTES**

- LAMINATE COUNTERTOP WITH INTEGRAL BACK SPLASH REFER TO FINISH SCHEDULE
- 2 UPPER CABINETRY REFER TO FINISH SCHEDULE
- 3 BASE CABINETRY REFER TO FINISH SCHEDULE
- 4 COOKTOP
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- 9 REFRIGERATOR (UNDERCOUNTER)
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- 23 FRP REFER TO FINISH SCHEDULE
- 24 | FLOOR DRAIN; REFER TO PLUMBING DRAWINGS
- 25 TEMPERED GLASS
- 26 COVER PANEL AT OPEN AREA UNDER SINK (TYP.)
- 27 THERMOSTAT
- 28 ELECTRIC PANEL
- 29 AIR RETURN
- 30 IDF CLOSET
- 31 BACKING REFER TO DETAIL 5/A10.01

#### NOTES

- ALL DIMENSIONS FROM CENTERLINE OF PLUMBING FIXTURE ARE TO FACE OF FINISH.
- 2. SEE FLOOR PLANS (A2.01 A2.04) FOR DOOR AND WINDOW LOCATION.
- 3. MAX COUNTER HEIGHT FOR CABINETS SHALL NOT EXCEED 34".
- 4. CONTRACTOR SHALL PROVIDE SHOP DRAWINGS FOR ALL CABINETRY FOR APPROVAL PRIOR TO FABRICATION.
- 5. SEE ACCESSIBILITY SHEETS FOR MOUNTING HEIGHTS.
- 6. CONTRACTOR TO PROVIDE TOILET PAPER DISPENSER AND SEAT COVER DISPENSER INSIDE ALL RESTROOMS PER 5/G3.04, 2/G3.06, AND 1/G3.06 INSIDE EACH TOILET FACILITY. REFER TO SPECS FOR NON-ACCESSIBLE WC AND FOR ALL WHEELCHAIR ACCESSIBLE WC.
- 7. FOR TYPICAL AND CHILD ACCESSIBLE RESTROOM MOUNTING HEIGHTS SEE DETAILS 2/G3.04, 4/G3.04, 5/G3.04, 2/G3.06, AND 1/G3.06.
- 8. PROVIDE PAPERLESS GYPSUM WALLBOARD AT ALL RESTROOM AND KITCHEN WALLS.
- 9. PROVIDE 3/4" RADIUS QUARTER-ROUND TO ALL EXPOSED CABINETRY EDGES.
- 10. REFER TO G3.02, G3.02, G3.03, G3.04, G3.05, AND G3.06 FOR DISABLE ACCESS NOTES, DETAILS AND TYPICAL REQUIREMENTS.

IDENTIFICATION STAMP DIV. OF THE STATE ARCHITECT

APP: 03-122151 INC:

REVIEWED FOR

SS FLS ACS D

DATE: 11/02/2022

# abode communities architecture

PROJECT:

## LAEP EARLY CHILDHOOD CENTER

13928 KORNBLUM AVE. HAWTHORNE, CA 90250

CLIENT:

Los Angeles Education

Partnership 1541 Wilshire Blvd., Suite 200 Los Angeles, CA 90017 T: 213.622.5237

ARCHITECT:

Abode Communities 1149 S. Hill Street, Suite 700 Los Angeles, CA 90015 T: 213.629.2702

CONSULTANTS:

Breen Engineering 1983 W. 190th St., Suite 200 Torrance, CA 90504 T: 310.464.8404


MECHANICAL/ ELECTRICAL/ PLUMBING Breen Engineering 1983 W. 190th St., Suite 200 Torrance, CA 90504 T: 310.464.8404

STRUCTURAL

Breen Engineering
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PROGRESS SET 02.01.22

DSA PROGRESS SET 03.02.22

DSA APPLICATION SET 04.01.22

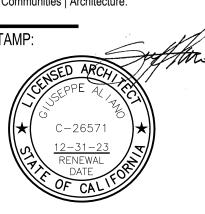
DSA BACK-CHECK SET 10.05.22


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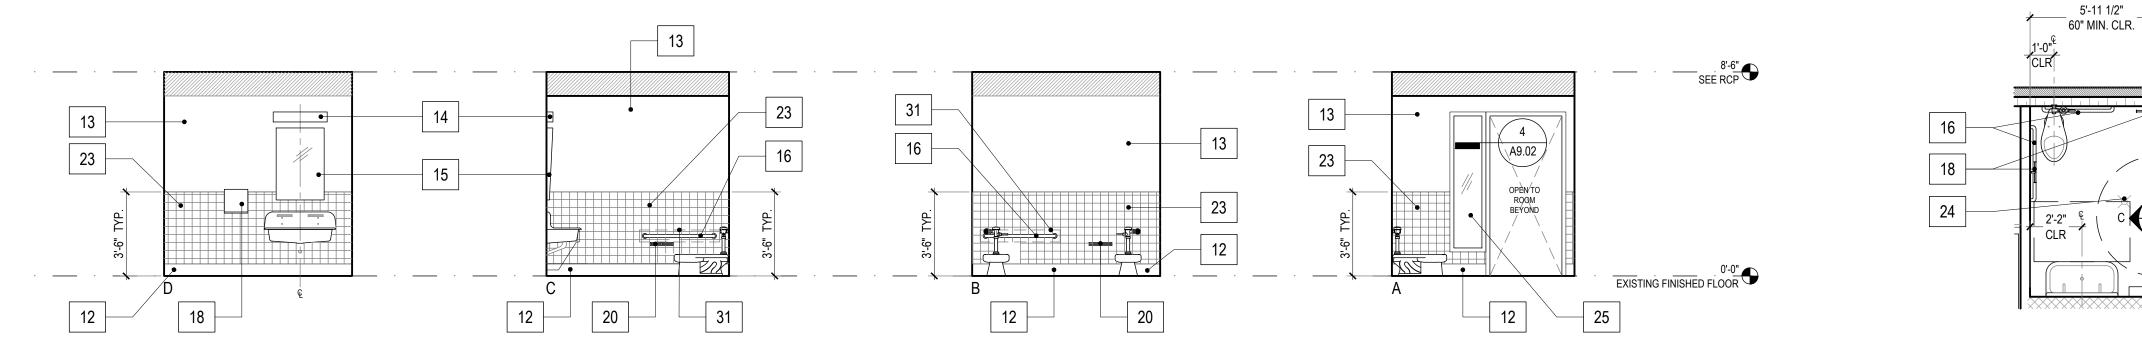
DSA BACK-CHECK SET 11.01.22

SHEET NAME:
BUNGALOW 01
INTERIOR ELEVATIONS

SHEET NUMBER:
A5.01A



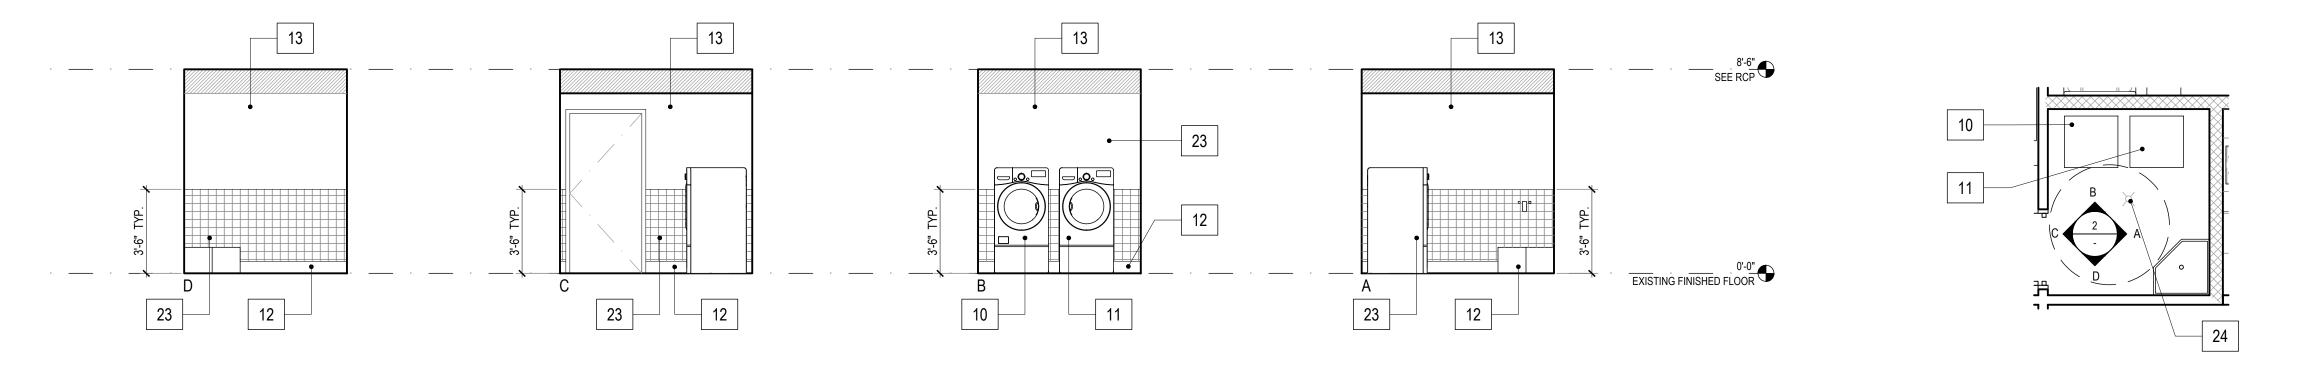

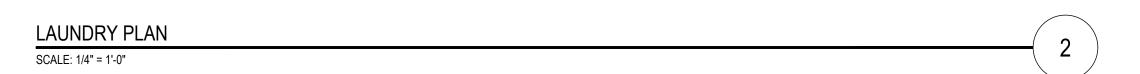

CHILD RESTROOM PLAN
SCALE: 1/4" = 1'-0"

#### **KEYNOTES**

- LAMINATE COUNTERTOP WITH INTEGRAL BACK SPLASH REFER TO FINISH SCHEDULE
- 2 UPPER CABINETRY REFER TO FINISH SCHEDULE
- 3 BASE CABINETRY REFER TO FINISH SCHEDULE
- 4 COOKTOP
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- 9 REFRIGERATOR (UNDERCOUNTER)
- 10 WASHER
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- 14 LIGHT FIXTURE; REFER TO REFLECTED CEILING PLANS
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- 25 TEMPERED GLASS
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- 30 IDF CLOSET
- 31 BACKING REFER TO DETAIL 5/A10.01

#### NOTES

- 1. ALL DIMENSIONS FROM CENTERLINE OF PLUMBING FIXTURE ARE TO FACE OF FINISH.
- 2. SEE FLOOR PLANS (A2.01 A2.04) FOR DOOR AND WINDOW LOCATION.
- 3. MAX COUNTER HEIGHT FOR CABINETS SHALL NOT EXCEED 34".
- 4. CONTRACTOR SHALL PROVIDE SHOP DRAWINGS FOR ALL CABINETRY FOR APPROVAL PRIOR TO FABRICATION.
- 5. SEE ACCESSIBILITY SHEETS FOR MOUNTING HEIGHTS.
- 6. CONTRACTOR TO PROVIDE TOILET PAPER DISPENSER AND SEAT COVER DISPENSER INSIDE ALL RESTROOMS PER 5/G3.04, 2/G3.06, AND 1/G3.06 INSIDE EACH TOILET FACILITY. REFER TO SPECS FOR NON-ACCESSIBLE WC AND FOR ALL WHEELCHAIR ACCESSIBLE WC.
- 7. FOR TYPICAL AND CHILD ACCESSIBLE RESTROOM MOUNTING HEIGHTS SEE DETAILS 2/G3.04, 4/G3.04, 5/G3.04, 2/G3.06, AND 1/G3.06.
- 8. PROVIDE PAPERLESS GYPSUM WALLBOARD AT ALL RESTROOM AND KITCHEN WALLS.
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IDENTIFICATION STAMP DIV. OF THE STATE ARCHITECT

APP: 03-122151 INC:

REVIEWED FOR

SS FLS ACS D

DATE: 11/02/2022

# abode communities architecture

PROJECT:

## LAEP EARLY CHILDHOOD CENTER

13928 KORNBLUM AVE. HAWTHORNE, CA 90250

LIENT:

Los Angeles Education Partnership 1541 Wilshire Blvd., Suite 200

Los Angeles, CA 90017 T: 213.622.5237

ARCHITECT:

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CONSULTANTS:

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T: 310.464.8404

MECHANICAL/
ELECTRICAL/ PLUMBING


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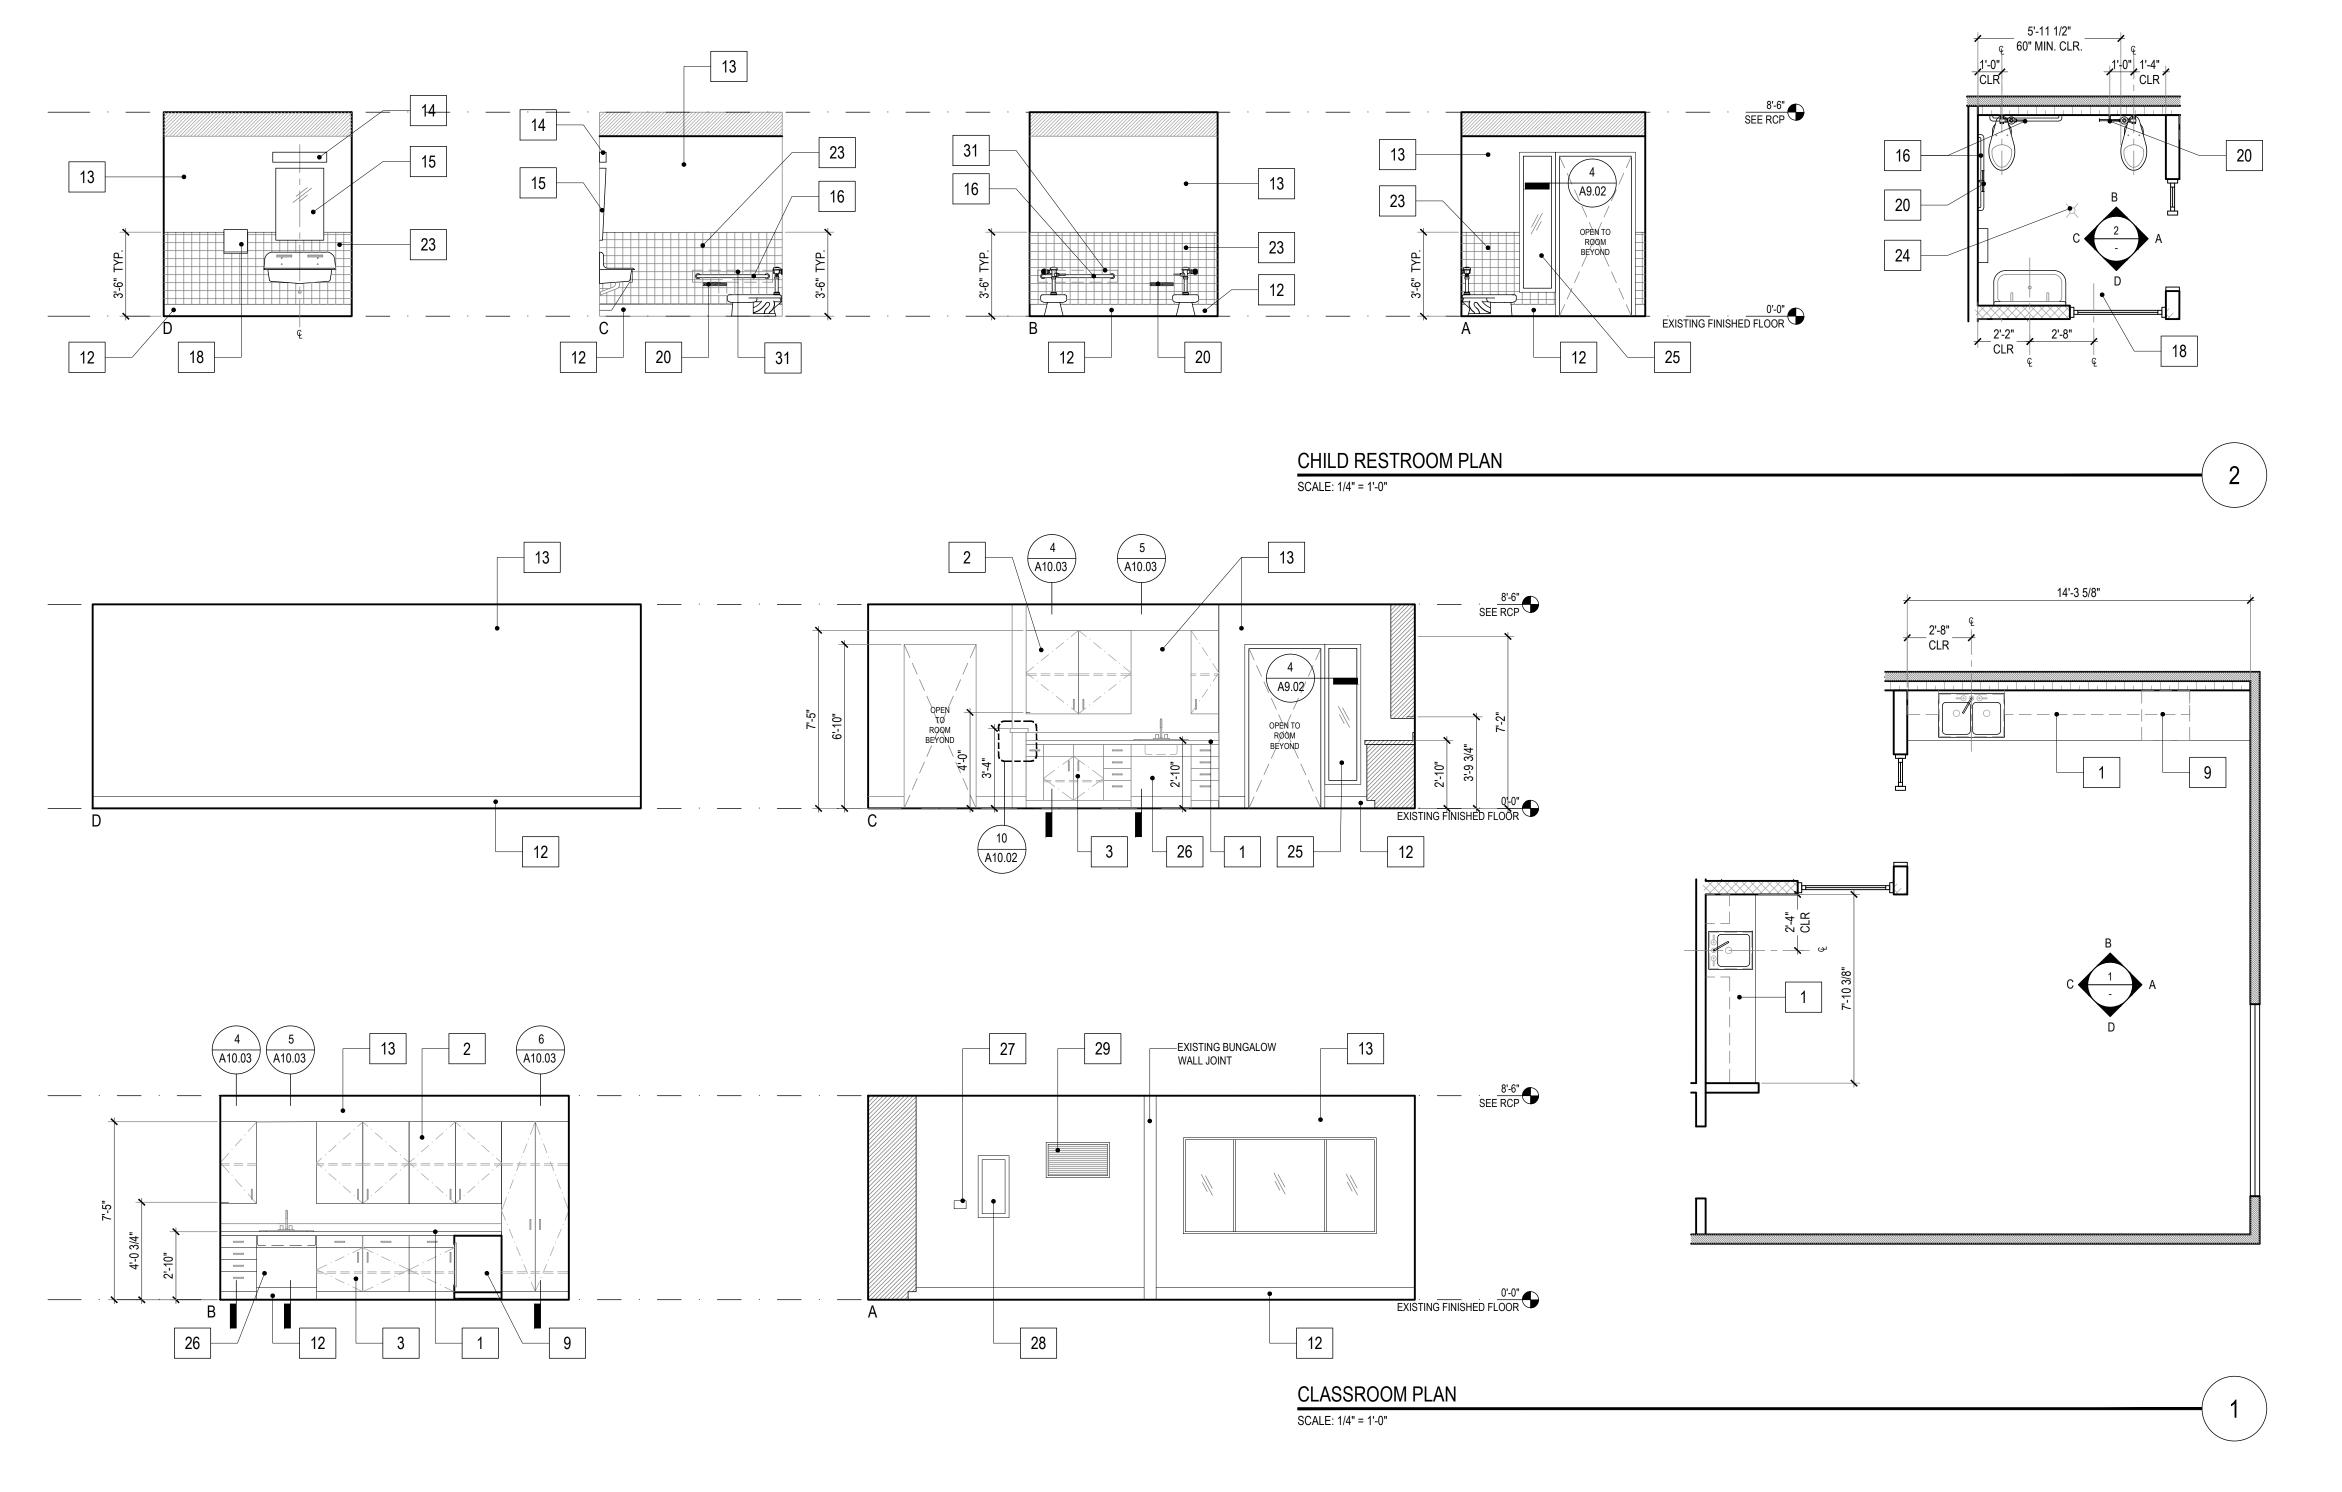


	DATE	REV
PROGRESS SET	02.01.22	
DSA PROGRESS SET	03.02.22	
DSA APPLICATION SET	04.01.22	
DSA BACK-CHECK SET	10.05.22	
DSA BACK-CHECK SET	10.24.22	
DSA BACK-CHECK SET	11.01.22	

SHEET NAME:
BUNGALOW 01
INTERIOR ELEVATIONS

SHEET NUMBER:

A5.01B

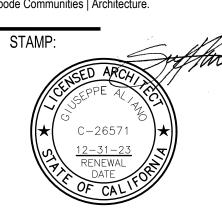

#### **KEYNOTES**

- LAMINATE COUNTERTOP WITH INTEGRAL BACK SPLASH REFER TO FINISH SCHEDULE
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#### NOTES

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IDENTIFICATION STAMP DIV. OF THE STATE ARCHITECT

APP: 03-122151 INC:

REVIEWED FOR

SS FLS ACS D

DATE: 11/02/2022

# abode communities architecture

PROJECT:

## LAEP EARLY CHILDHOOD CENTER

13928 KORNBLUM AVE. HAWTHORNE, CA 90250

CLIENT:

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CONSULTANTS:

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ELECTRICAL/ PLUMBING


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PROGRESS SET 02.01.22

DSA PROGRESS SET 03.02.22

DSA APPLICATION SET 04.01.22

DSA BACK-CHECK SET 10.05.22


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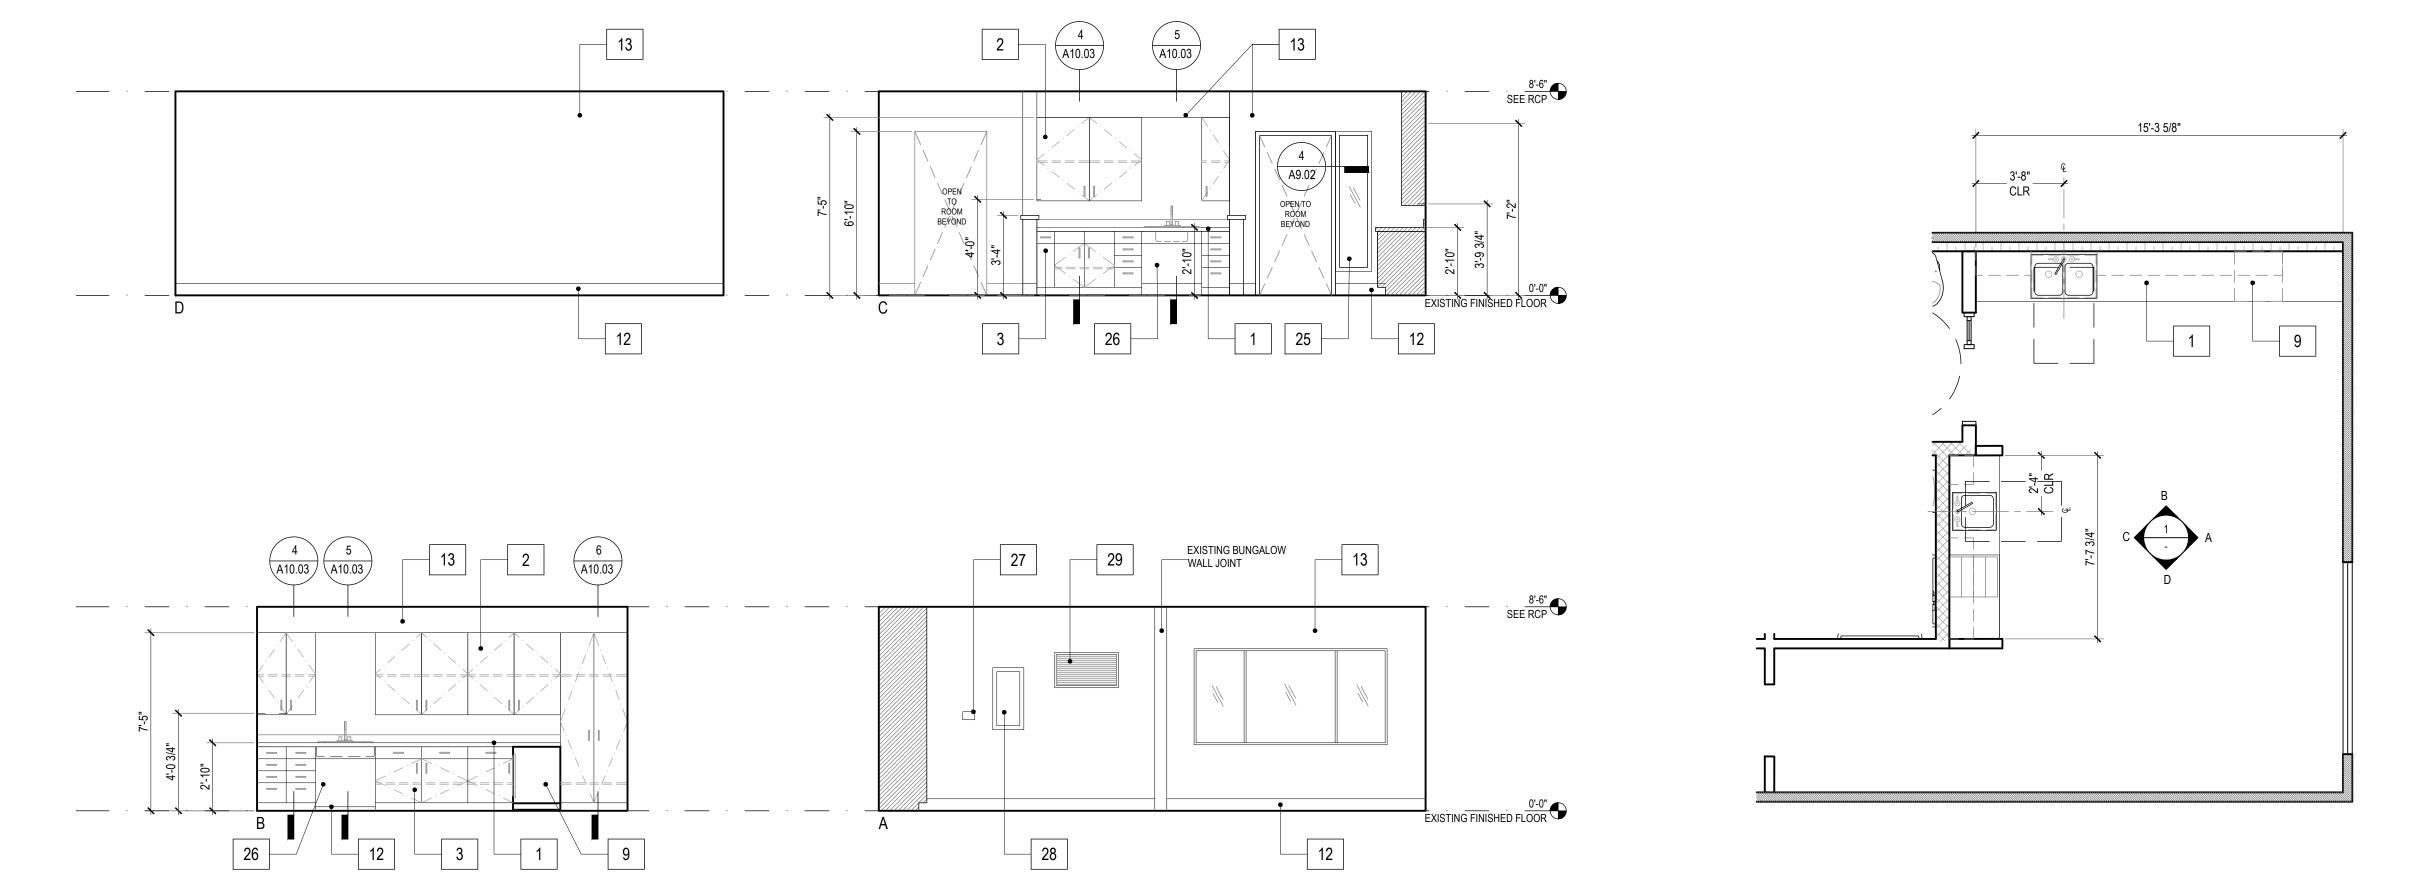
DSA BACK-CHECK SET 11.01.22

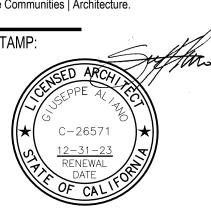SHEET NAME:
BUNGALOW 02
INTERIOR ELEVATIONS

SHEET NUMBER:

A5.02



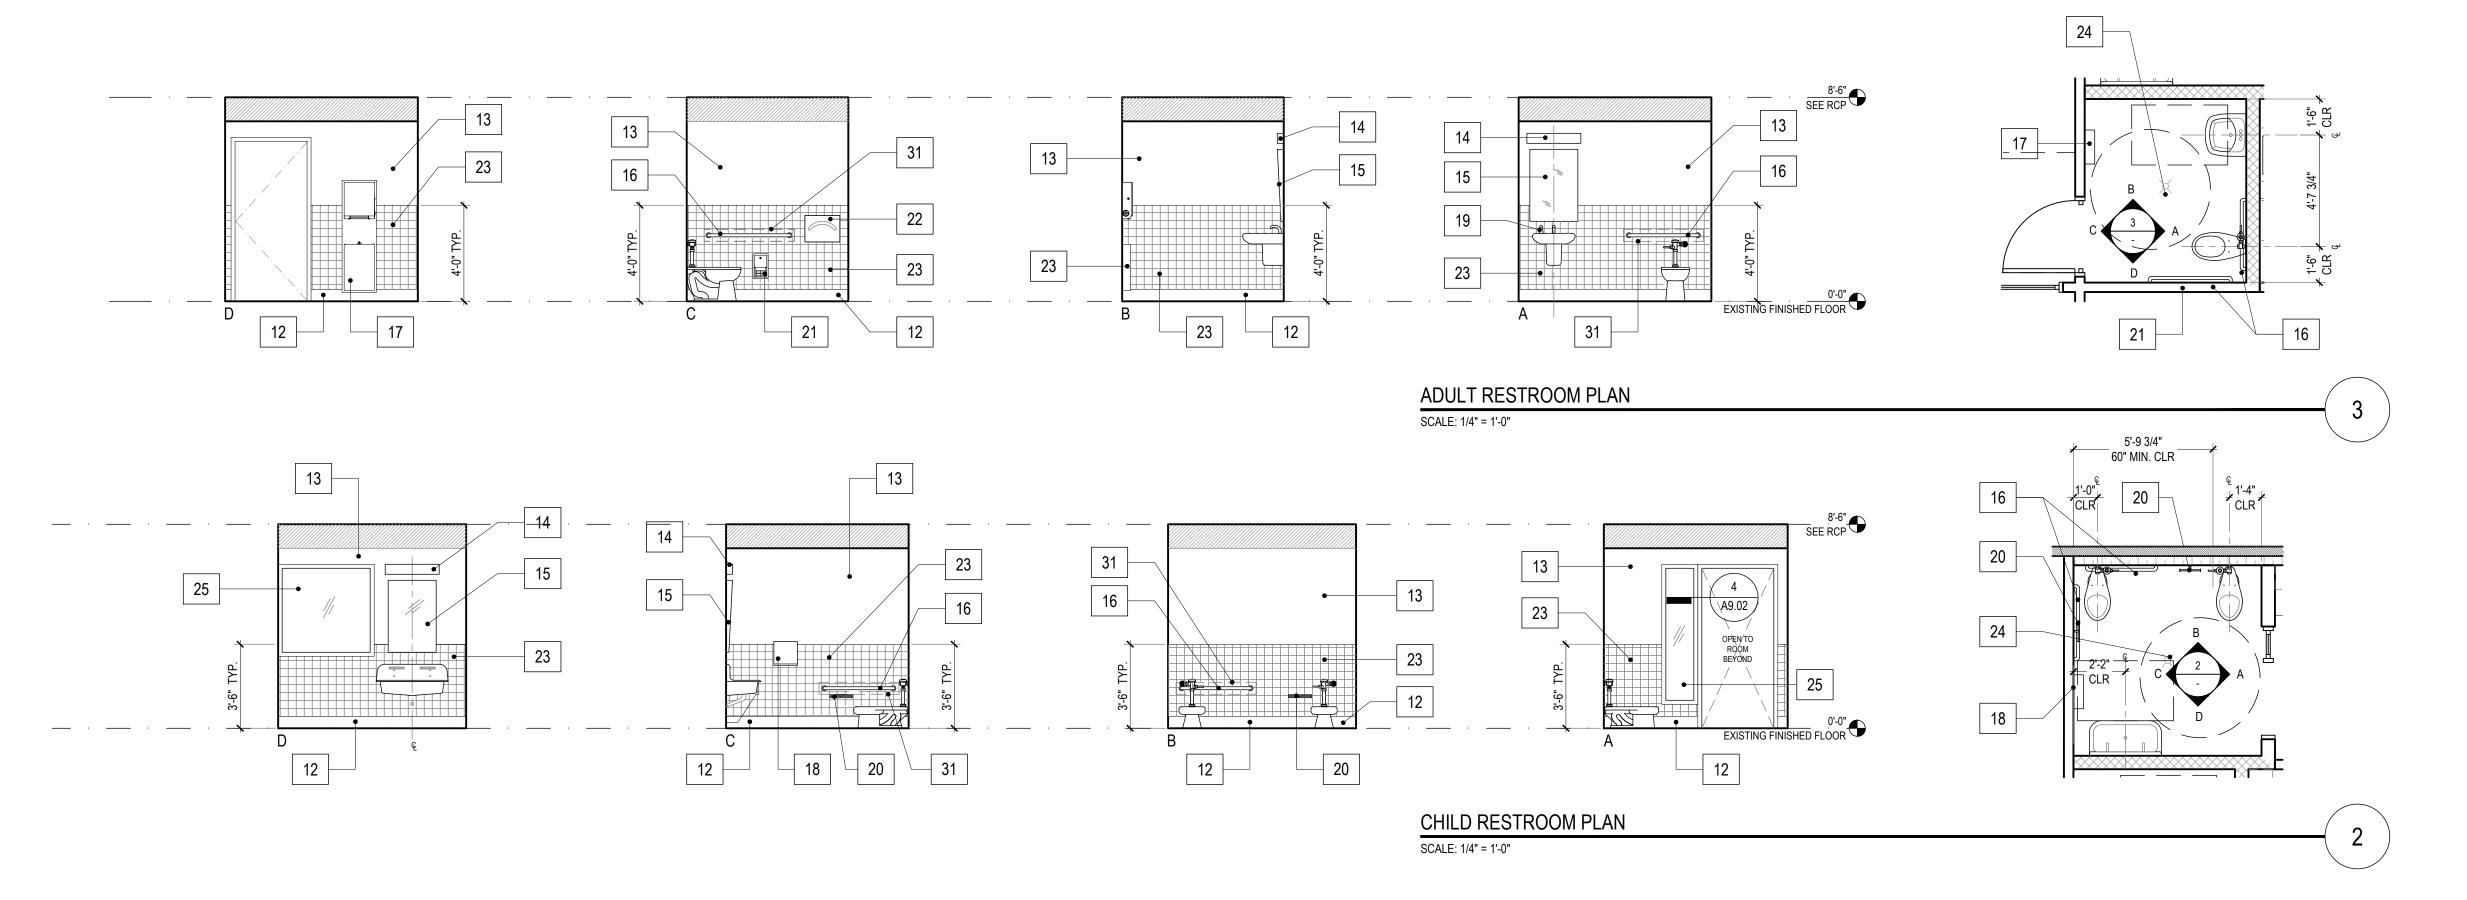

CLASSROOM AND CHILD RESTROOM PLAN

SCALE: 1/4" = 1'-0"

#### **KEYNOTES**

- LAMINATE COUNTERTOP WITH INTEGRAL BACK SPLASH REFER TO FINISH SCHEDULE
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- 19 SOAP DISPENSER
- 20 TOILET PAPER DISPENSER
- 21 RECESSED TOILET PAPER DISPENSER
- 22 SEAT COVER DISPENSER
- 23 FRP REFER TO FINISH SCHEDULE
- 24 | FLOOR DRAIN; REFER TO PLUMBING DRAWINGS
- 25 TEMPERED GLASS
- 26 COVER PANEL AT OPEN AREA UNDER SINK (TYP.)
- 27 THERMOSTAT
- 28 ELECTRIC PANEL
- 29 AIR RETURN
- 30 IDF CLOSET
- 31 BACKING REFER TO DETAIL 5/A10.01

#### NOTES

- ALL DIMENSIONS FROM CENTERLINE OF PLUMBING FIXTURE ARE TO FACE OF FINISH.
- 2. SEE FLOOR PLANS (A2.01 A2.04) FOR DOOR AND WINDOW LOCATION.
- 3. MAX COUNTER HEIGHT FOR CABINETS SHALL NOT EXCEED 34".
- 4. CONTRACTOR SHALL PROVIDE SHOP DRAWINGS FOR ALL CABINETRY FOR APPROVAL PRIOR TO FABRICATION.
- 5. SEE ACCESSIBILITY SHEETS FOR MOUNTING HEIGHTS.
- CONTRACTOR TO PROVIDE TOILET PAPER DISPENSER AND SEAT COVER DISPENSER INSIDE ALL RESTROOMS PER 5/G3.04, 2/G3.06, AND 1/G3.06 INSIDE EACH TOILET FACILITY. REFER TO SPECS FOR NON-ACCESSIBLE WC AND FOR ALL WHEELCHAIR ACCESSIBLE WC.
- 7. FOR TYPICAL AND CHILD ACCESSIBLE RESTROOM MOUNTING HEIGHTS SEE DETAILS 2/G3.04, 4/G3.04, 5/G3.04, 2/G3.06, AND 1/G3.06.
- 8. PROVIDE PAPERLESS GYPSUM WALLBOARD AT ALL RESTROOM AND KITCHEN WALLS.
- 9. PROVIDE 3/4" RADIUS QUARTER-ROUND TO ALL EXPOSED CABINETRY EDGES.
- 10. REFER TO G3.02, G3.02, G3.03, G3.04, G3.05, AND G3.06 FOR DISABLE ACCESS NOTES, DETAILS AND TYPICAL REQUIREMENTS.

IDENTIFICATION STAMP DIV. OF THE STATE ARCHITECT

APP: 03-122151 INC:

REVIEWED FOR

SS FLS ACS D

DATE: 11/02/2022

# abode communities architecture

PROJECT:

## LAEP EARLY CHILDHOOD CENTER

13928 KORNBLUM AVE. HAWTHORNE, CA 90250

LIFNT:

Los Angeles Education Partnership 1541 Wilshire Blvd., Suite 200

Los Angeles, CA 90017 T: 213.622.5237

ARCHITECT:

Abode Communities
1149 S. Hill Street, Suite 700
Los Angeles, CA 90015
T: 213.629.2702

CONSULTANTS:

Breen Engineering 1983 W. 190th St., Suite 200 Torrance, CA 90504 T: 310.464.8404

MECHANICAL/
ELECTRICAL/ PLUMBING


Breen Engineering
1983 W. 190th St., Suite 200
Torrance, CA 90504
T: 310.464.8404

STRUCTURAL

Breen Engineering
1983 W. 190th St., Suite 200
Torrance, CA 90504
T: 310.464.8404

DSA APPLICATION NUMBER: 03-122151


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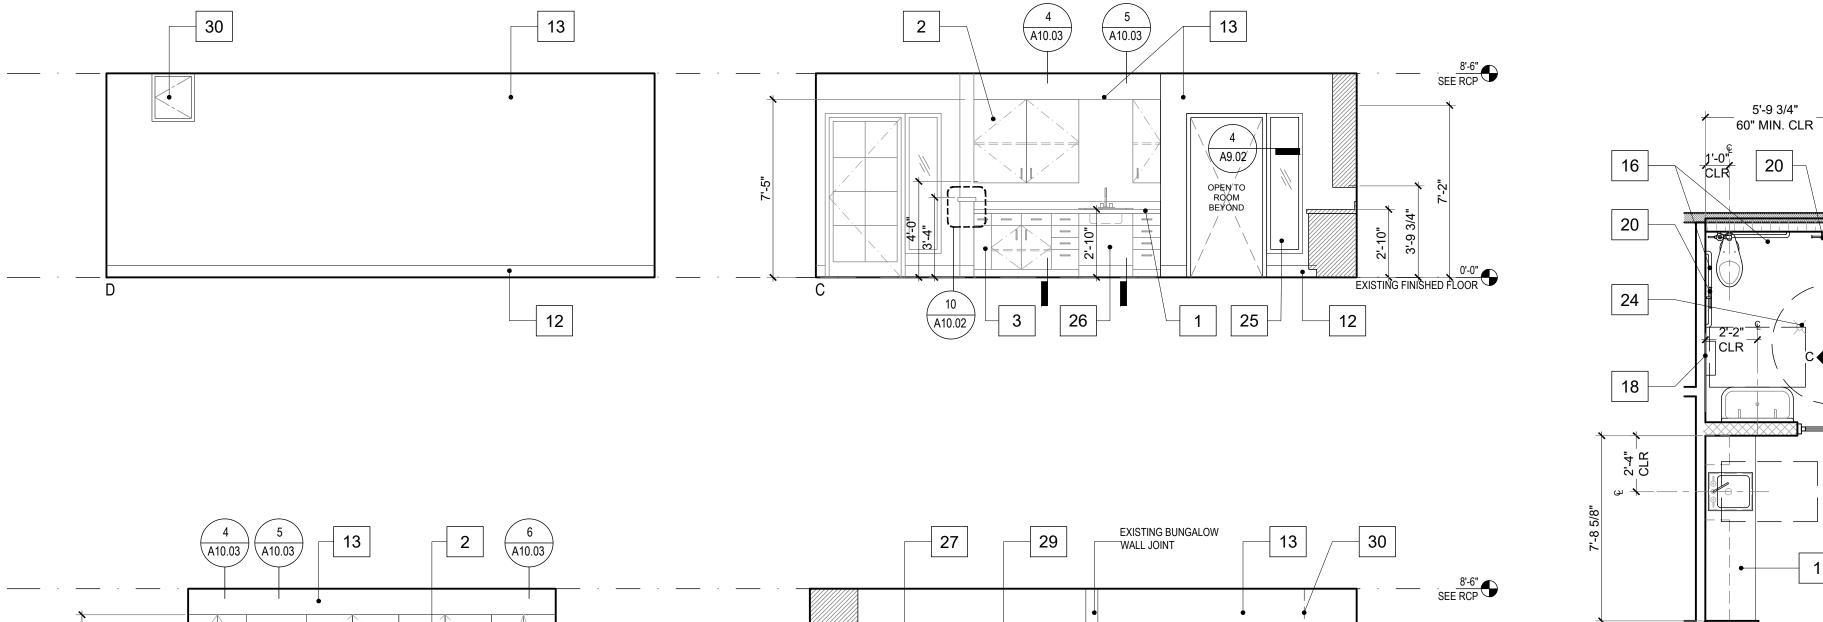


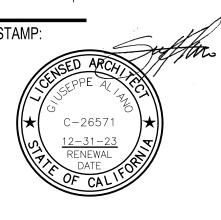DATE REV
PROGRESS SET 02.01.22
DSA PROGRESS SET 03.02.22
DSA APPLICATION SET 04.01.22
DSA BACK-CHECK SET 10.05.22
DSA BACK-CHECK SET 10.24.22
DSA BACK-CHECK SET 11.01.22

SHEET NAME:
BUNGALOW 03
INTERIOR ELEVATIONS


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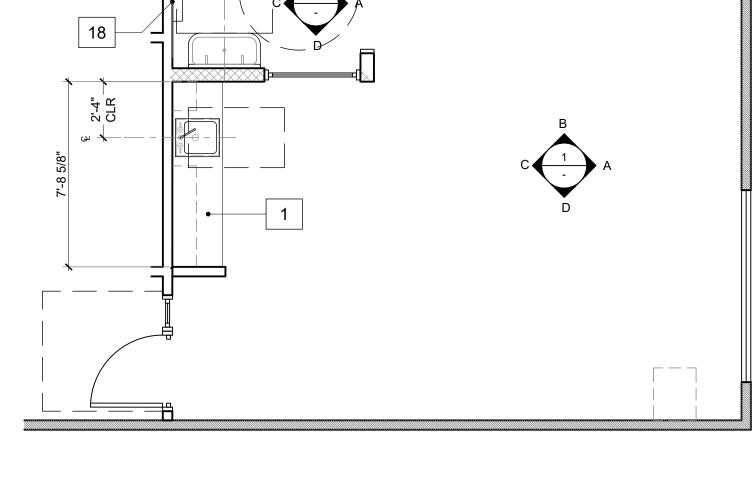


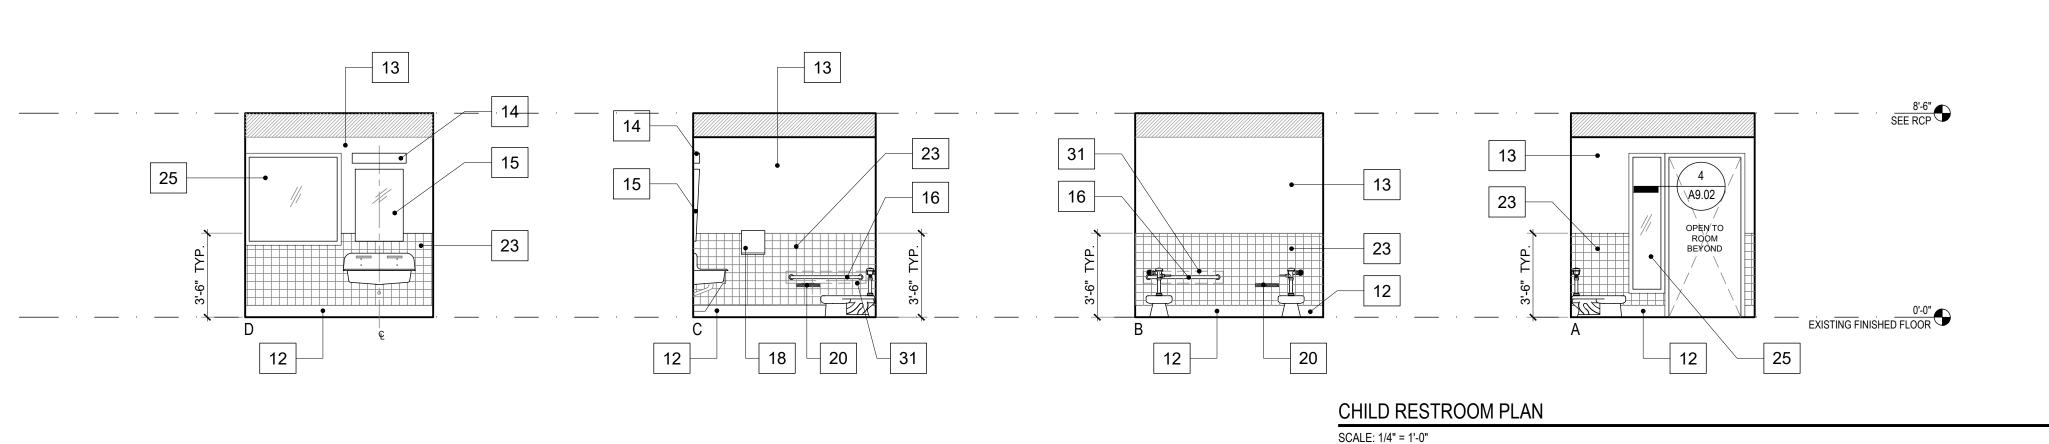

3

12



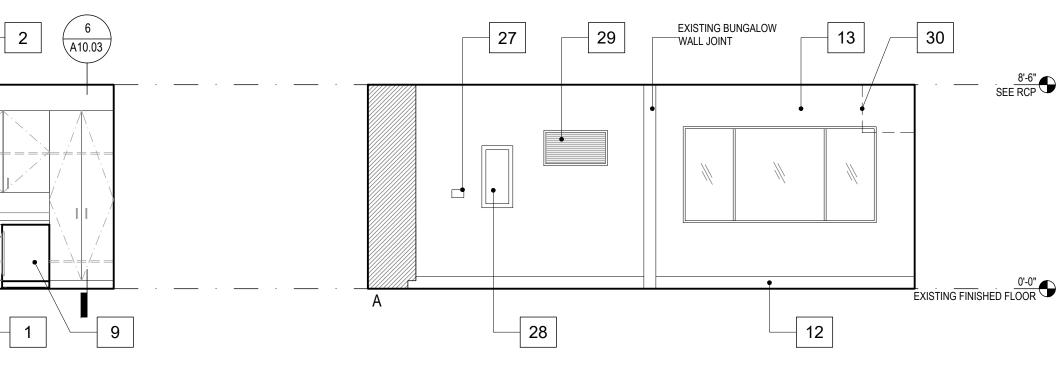

20

15'-3 7/8"

CLASSROOM AND CHILD RESTROOM PLAN

SCALE: 1/4" = 1'-0"

#### **KEYNOTES**

- LAMINATE COUNTERTOP WITH INTEGRAL BACK SPLASH -REFER TO FINISH SCHEDULE
- UPPER CABINETRY REFER TO FINISH SCHEDULE
- BASE CABINETRY REFER TO FINISH SCHEDULE
- 4 COOKTOP
- 5 OVEN
- RANGE HOOD
- DISHWASHER
- REFRIGERATOR
- REFRIGERATOR (UNDERCOUNTER)
- 10 WASHER
- 11 DRYER
- BASEBOARD REFER TO FINISH SCHEDULE
- 13 PAINT FINISH- REFER TO FINISH SCHEDULE
- LIGHT FIXTURE; REFER TO REFLECTED CEILING PLANS
- 15 TILT MIRROR
- **GRAB BAR**
- RECESSED PAPER TOWEL DISPENSER & WASTE RECEPTACLE
- PAPER TOWEL DISPENSER
- 19 SOAP DISPENSER
- TOILET PAPER DISPENSER
- RECESSED TOILET PAPER DISPENSER
- 22 SEAT COVER DISPENSER
- 23 FRP REFER TO FINISH SCHEDULE
- FLOOR DRAIN; REFER TO PLUMBING DRAWINGS
- 25 TEMPERED GLASS
- COVER PANEL AT OPEN AREA UNDER SINK (TYP.)
- 27 THERMOSTAT
- ELECTRIC PANEL
- 29 AIR RETURN
- IDF CLOSET
- 31 BACKING REFER TO DETAIL 5/A10.01

#### **NOTES**

- 1. ALL DIMENSIONS FROM CENTERLINE OF PLUMBING FIXTURE ARE TO FACE OF FINISH.
- 2. SEE FLOOR PLANS (A2.01 A2.04) FOR DOOR AND WINDOW LOCATION.
- MAX COUNTER HEIGHT FOR CABINETS SHALL NOT EXCEED 34".
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- SEE ACCESSIBILITY SHEETS FOR MOUNTING HEIGHTS.
- CONTRACTOR TO PROVIDE TOILET PAPER DISPENSER AND SEAT COVER DISPENSER INSIDE ALL RESTROOMS PER 5/G3.04, 2/G3.06, AND 1/G3.06 INSIDE EACH TOILET FACILITY. REFER TO SPECS FOR NON-ACCESSIBLE WC AND FOR ALL WHEELCHAIR ACCESSIBLE WC.
- 7. FOR TYPICAL AND CHILD ACCESSIBLE RESTROOM MOUNTING HEIGHTS SEE DETAILS 2/G3.04, 4/G3.04, 5/G3.04, 2/G3.06, AND 1/G3.06.
- PROVIDE PAPERLESS GYPSUM WALLBOARD AT ALL RESTROOM AND KITCHEN WALLS.
- PROVIDE 3/4" RADIUS QUARTER-ROUND TO ALL EXPOSED CABINETRY EDGES.
- 10. REFER TO G3.02, G3.02, G3.03, G3.04, G3.05, AND G3.06 FOR DISABLE ACCESS NOTES, DETAILS AND TYPICAL REQUIREMENTS.

IDENTIFICATION STAMP DIV. OF THE STATE ARCHITEC APP: 03-122151 INC: REVIEWED FOR SS 🗹 FLS 🗹 ACS 🗹 DATE: 11/02/2022

#### abode communities architecture

PROJECT:

#### LAEP EARLY **CHILDHOOD CENTER**

13928 KORNBLUM AVE. HAWTHORNE, CA 90250

CLIENT:

Los Angeles Education Partnership 1541 Wilshire Blvd., Suite 200 Los Angeles, CA 90017 T: 213.622.5237

ARCHITECT:

**Abode Communities** 1149 S. Hill Street, Suite 700 Los Angeles, CA 90015 T: 213.629.2702

CONSULTANTS:


**Breen Engineering** 1983 W. 190th St., Suite 200 Torrance, CA 90504 T: 310.464.8404 MECHANICAL/

**ELECTRICAL/ PLUMBING Breen Engineering** 1983 W. 190th St., Suite 200 Torrance, CA 90504 T: 310.464.8404

**STRUCTURAL Breen Engineering** 1983 W. 190th St., Suite 200 Torrance, CA 90504 T: 310.464.8404

#### DSA APPLICATION NUMBER: 03-122151

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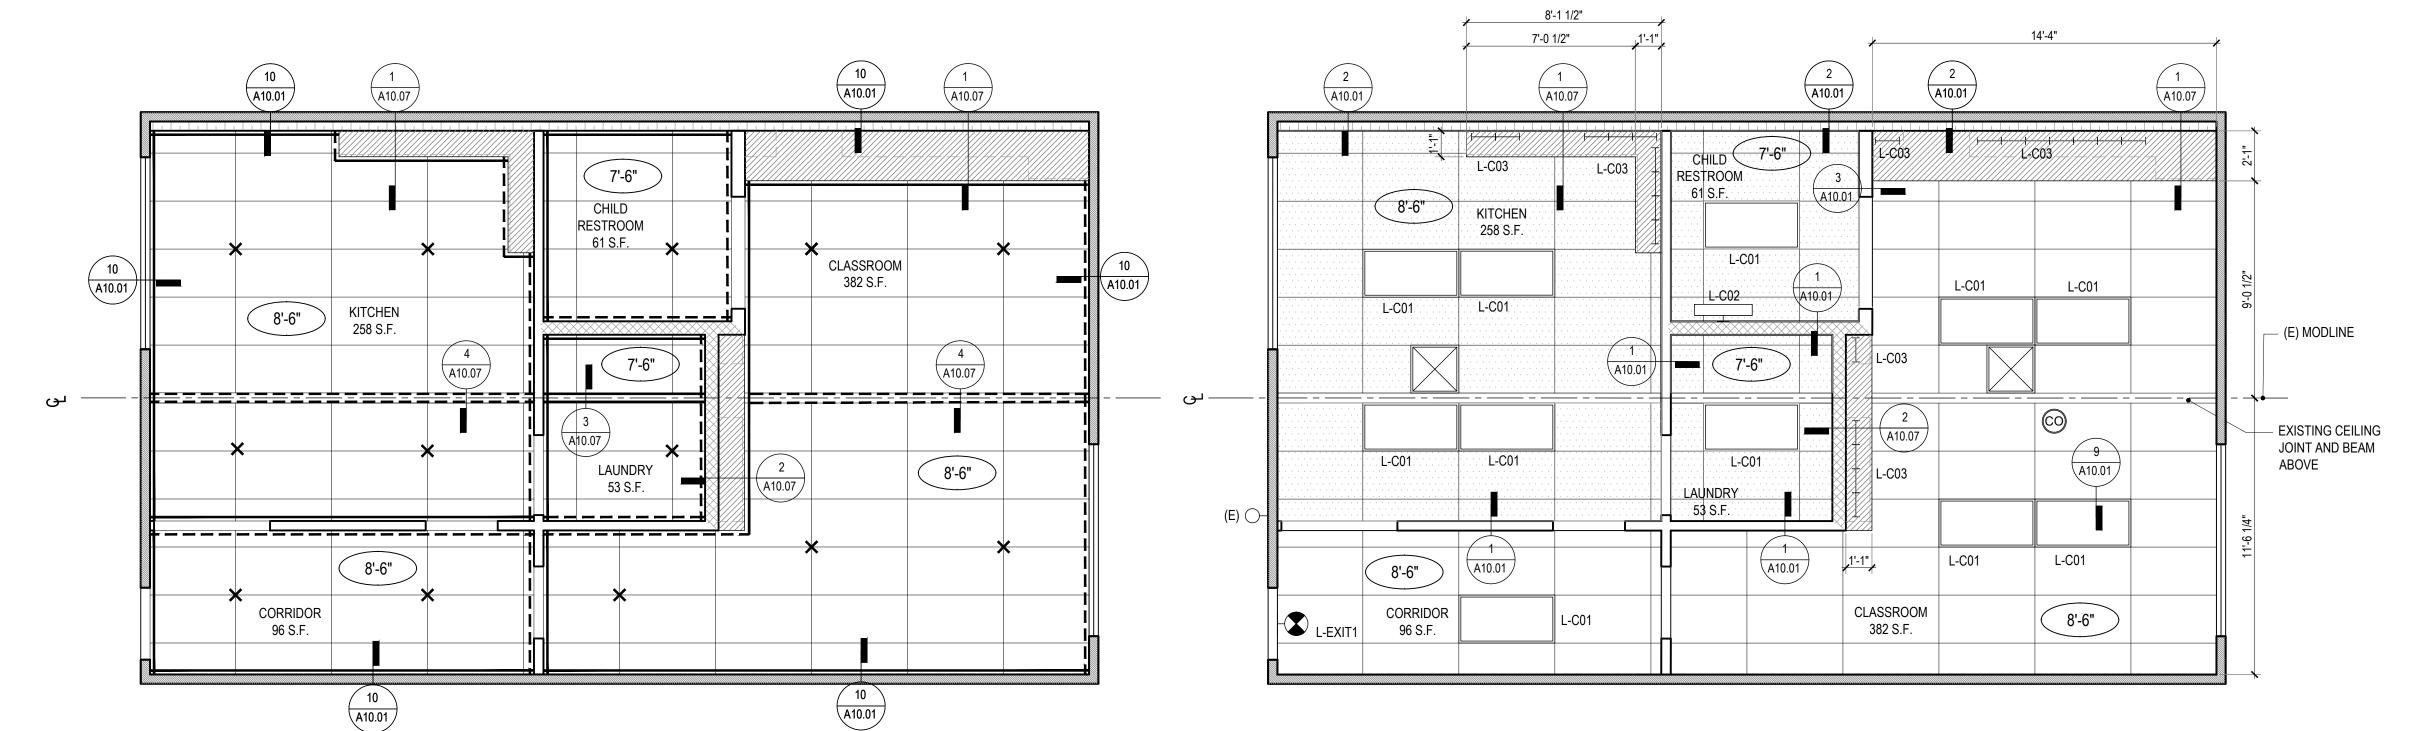
DATE REV PROGRESS SET 02.01.22 DSA PROGRESS SET 03.02.22 DSA APPLICATION SET 04.01.22 DSA BACK-CHECK SET 10.05.22 DSA BACK-CHECK SET 10.24.22 DSA BACK-CHECK SET 11.01.22

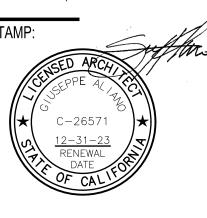SHEET NAME: **BUNGALOW 04** INTERIOR ELEVATIONS

SHEET NUMBER:

A5.04

SUED: 08/08	/2022											Abode Communities Architecture
ITEM	FIXTURE TYPE	LOCATION	MANUFACTURER	PRODUCT NAME	MODEL#	COLOR/FINISH	DIMENSIONS	COLOR TEMP.	LUMENS	WATTS	BUG	NOTES
OMMOI	N AREA FIXTUR	ES										
C01	2x4 LIGHT	TYPICAL CEILING FIXTURE	LITHONIA	BLC CENTER BASKET TROFFER	TBD	WHITE	24"x48"	3500K	TBD	TBD	N/A	
L-C02	VANITY LIGHT	RESTROOM	PROGRESS	CCT SLECTABLE BATH LIGHT	P300239-060-CS	FROSTED ACRYLIC	26" x 6" (APPROX.)	3000K	2124	24	N/A	
L-C03	UNDERMOUNT CABINET LIGHT	KITCHEN	BRUCK	wUndercab	138546-16-3000K-90-120V-WH	WHITE	16" x 1"	3000K	650	10	N/A	
T												
EXIT1	EXIT SIGN	CEILING	LITHONIA	EDG amd EDGR	EDG-G/EDGR-G-EL	BRUSHED ALUMINUM	8" x 13"	GREEN	N/A	2.2/4.5	N/A	provide battery back-up; ceiling (recessed) of wall mount, per plans and elevations



#### BUNGALOW 01 BRACING DIAGRAM

SCALE: 1/4" = 1'-0"

BUNGALOW 01 REFLECTED CEILING PLAN


SCALE: 1/4" = 1'-0"

1



#### **LEGEND**



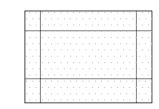

NEW T-BAR CEILING WITH 2'X4' VINYL COATED "WASHABLE" ACOUSTICAL PANELS @ 8'-6" MIN., U.N.O. REPLACE PANELS AS NEEDED.



NEW SOFFIT @ 7'-0" MIN., U.N.O.



RIGID VERTICAL CEILING STRUT, REFER TO DETAIL 8/A10.01



L-C01 NEW 24" X 48" TROFFER



L-C02 NEW 36" VANITY LIGHT



LC-03 NEW UNDERCABINET LIGHT




EXISTING EXTERIOR LIGHTING



L-EXIT1 NEW EXIT SIGNAGE (WALL MOUNTED) , SEE ELECTRICAL DWG.



NEW CARBON MONOXIDE DETECTOR (CEILING MOUNTED), SEE ELECTRICAL DWG.

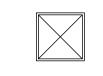

2'X2' CEILING SUPPLY DIFFUSER, SEE MECHANICAL PLANS



## ---- INDICATES FREE SIDE, REFER TO DETAIL 10/A10.01

#### **NOTES**

- 1. ALL DIMENSIONS ARE TO CENTERLINE OF ELECTRICAL FIXTURE OR TO FACE OF FINISH MATERIAL UNLESS NOTED OTHERWISE.
- 2. CEILING HEIGHTS, AND LOCATIONS OF CEILING JOINTS AND GRID TO BE VERIFIED IN FIELD.
- 3. ALL FIXTURES TO BE HIGH EFFICIENCY AND/OR ENERGY STAR RATED, AND COMPLY WITH TITLE 24 REQUIREMENTS.
- 4. EXIT SIGNS AND DIRECTIONAL SIGNS SHALL HAVE A MINIMUM HEIGHT OF 6" HIGH BY 3/4" STROKE BLOCK LETTERS ON A CONTRASTING BACKGROUND. SPACING BETWEEN SIGNS SHALL NOT EXCEED 100 FEET.
- 5. REFER TO MECHANICAL PLANS FOR HEATING AND VENTING EQUIPMENT LOCATIONS.
- 6. J-BOX LOCATIONS ABOVE SUSPENDED UP-LIGHTS TO BE COORDINATED WITH FIXTURE CONNECTION TO PROVIDE MINIMAL TRAVEL PATH OF ELECTRICAL WIRE. APPROXIMATE LOCATIONS ARE SHOWN ON REFLECTED CEILING PLANS.

IDENTIFICATION STAMP
DIV. OF THE STATE ARCHITECT

APP: 03-122151 INC:

REVIEWED FOR
SS FLS ACS 
DATE: 11/02/2022

# abode communities architecture

PROJECT:

## LAEP EARLY CHILDHOOD CENTER

13928 KORNBLUM AVE. HAWTHORNE, CA 90250

CLIENT:

Los Angeles Education Partnership 1541 Wilshire Blvd., Suite 200 Los Angeles, CA 90017

ARCHITECT:

T: 213.622.5237

Abode Communities
1149 S. Hill Street, Suite 700
Los Angeles, CA 90015
T: 213.629.2702

CONSULTANTS:

Breen Engineering
1983 W. 190th St., Suite 200
Torrance, CA 90504
T: 310.464.8404


MECHANICAL/ ELECTRICAL/ PLUMBING Breen Engineering 1983 W. 190th St., Suite 200 Torrance, CA 90504 T: 310.464.8404

STRUCTURAL

Breen Engineering
1983 W. 190th St., Suite 200
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T: 310.464.8404

#### DSA APPLICATION NUMBER: 03-122151

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PROGRESS SET 02.01.22

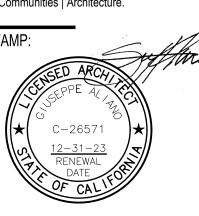DSA PROGRESS SET 03.02.22

DSA APPLICATION SET 04.01.22

DSA BACK-CHECK SET 10.05.22

DSA BACK-CHECK SET 10.24.22


SHEET NAME:
BUNGALOW 01
REFLECTED
CEILING PLAN

DSA BACK-CHECK SET 11.01.22

SHEET NUMBER:

A6.01

SUED: 08/08	LDCARE											Abode Communities Architecture
ITEM	FIXTURE TYPE	LOCATION	MANUFACTURER	PRODUCT NAME	MODEL #	COLOR/FINISH	DIMENSIONS	COLOR TEMP.	LUMENS	WATTS	BUG	NOTES
ОММО	N AREA FIXTUR	ES						<u>'</u>				
L-C01	2x4 LIGHT	TYPICAL CEILING FIXTURE	LITHONIA	BLC CENTER BASKET TROFFER	TBD	WHITE	24"x48"	3500K	TBD	TBD	N/A	
L-C02	VANITY LIGHT	RESTROOM	PROGRESS	CCT SLECTABLE BATH LIGHT	P300239-060-CS	FROSTED ACRYLIC	26" x 6" (APPROX.)	3000K	2124	24	N/A	
L-C03	UNDERMOUNT CABINET LIGHT	KITCHEN	BRUCK	wUndercab	138546-16-3000K-90-120V-WH	WHITE	16" x 1"	3000K	650	10	N/A	
EXIT1	EXIT \$IGN	CEILING	LITHONIA	EDG amd EDGR	EDG-G/EDGR-G-EL	BRUSHED ALUMINUM	8" x 13"	GREEN	N/A	2.2/4.5	N/A	provide battery back-up; ceiling (recessed) or wall mount, per plans and elevations
												T

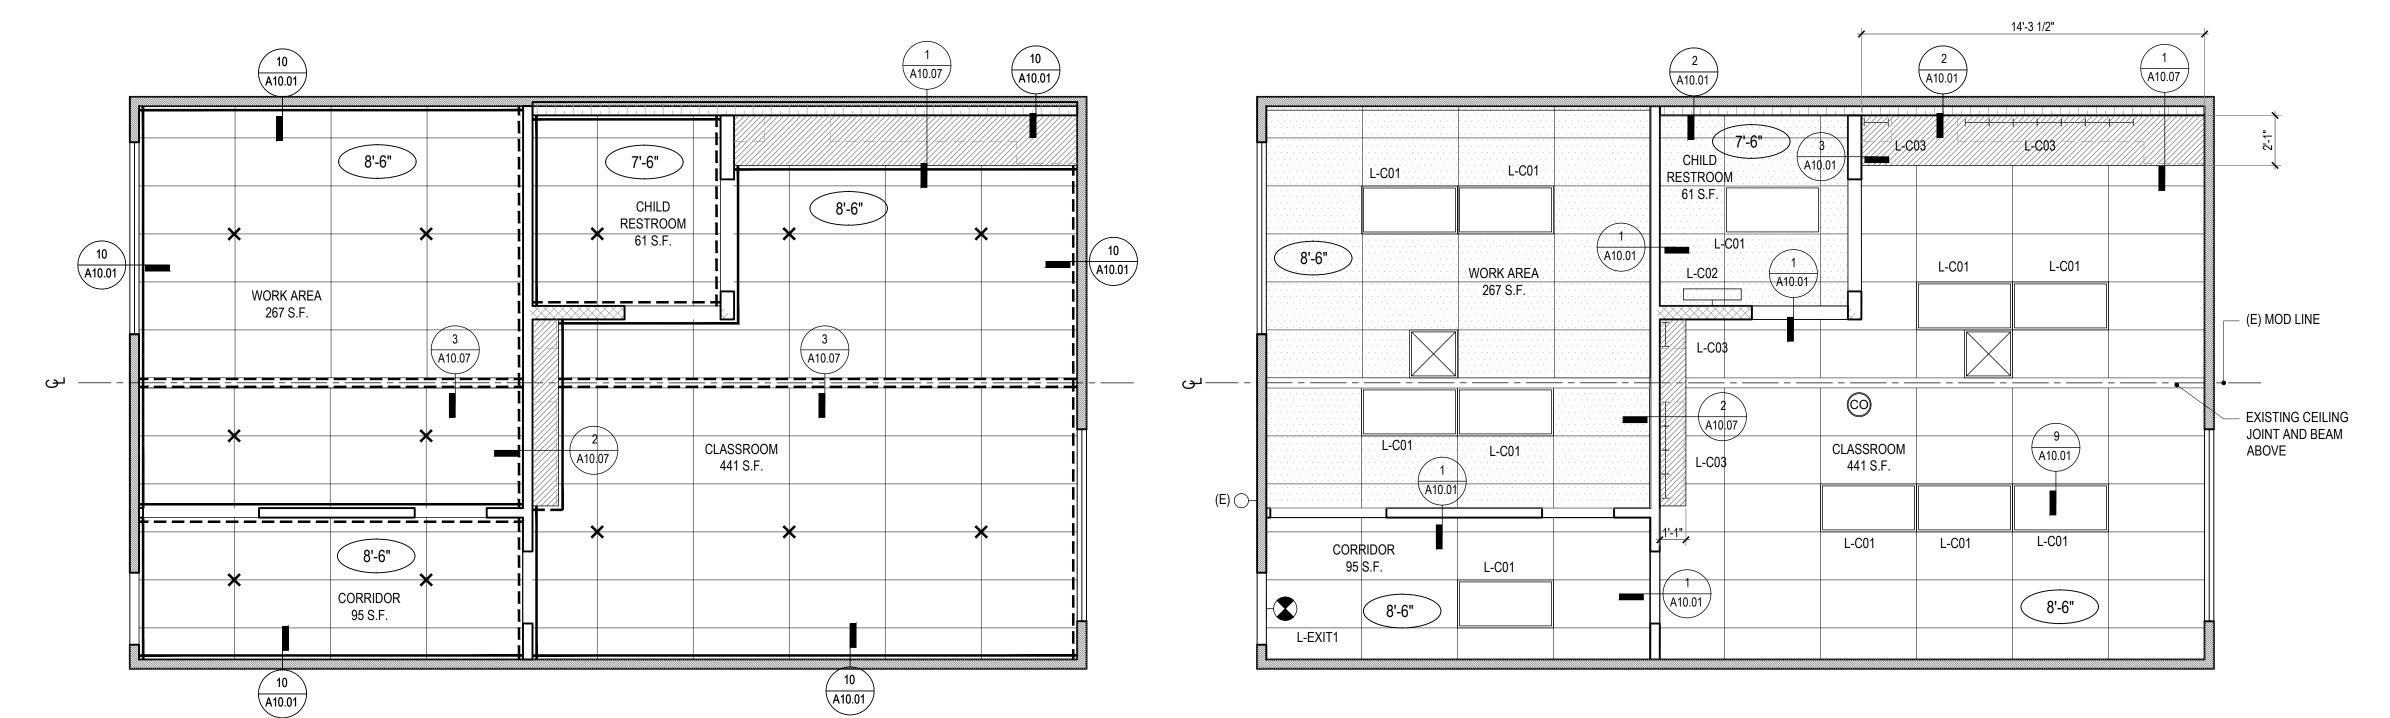

BUNGALOW 02 BRACING DIAGRAM

SCALE: 1/4" = 1'-0"

BUNGALOW 02 REFLECTED CEILING PLAN


SCALE: 1/4" = 1'-0"



#### **LEGEND**



EXISTING T-BAR CEILING WITH 2'X4'
ACOUSTICAL PANELS @ 8'-6" MIN., U.N.O.
REPLACE PANELS AS NEEDED.

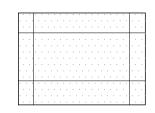

NEW T-BAR CEILING WITH 2'X4' VINYL COATED "WASHABLE" ACOUSTICAL PANELS @ 8'-6" MIN., U.N.O. REPLACE PANELS AS NEEDED.




NEW SOFFIT @ 7'-0" MIN., U.N.O.



RIGID VERTICAL CEILING STRUT, REFER TO DETAIL 8/A10.01



L-C01 NEW 24" X 48" TROFFER

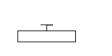

L-C02 NEW 36" VANITY LIGHT



LC-03 NEW UNDERCABINET LIGHT




EXISTING EXTERIOR LIGHTING




L-EXIT1
NEW EXIT SIGNAGE (WALL MOUNTED)
SEE ELECTRICAL DWG.



NEW CARBON MONOXIDE DETECTOR (CEILING MOUNTED), SEE ELECTRICAL DWG.

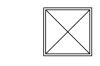

2'X2' CEILING SUPPLY DIFFUSER, SEE MECHANICAL PLANS

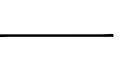

DETAIL 10/A10.01

INDICATES FIXED SIDE, REFER TO

#### 

#### **NOTES**

- 1. ALL DIMENSIONS ARE TO CENTERLINE OF ELECTRICAL FIXTURE OR TO FACE OF FINISH MATERIAL UNLESS NOTED OTHERWISE.
- 2. CEILING HEIGHTS, AND LOCATIONS OF CEILING JOINTS AND GRID TO BE VERIFIED IN FIELD.
- 3. ALL FIXTURES TO BE HIGH EFFICIENCY AND/OR ENERGY STAR RATED, AND COMPLY WITH TITLE 24 REQUIREMENTS.
- 4. EXIT SIGNS AND DIRECTIONAL SIGNS SHALL HAVE A MINIMUM HEIGHT OF 6" HIGH BY 3/4" STROKE BLOCK LETTERS ON A CONTRASTING BACKGROUND. SPACING BETWEEN SIGNS SHALL NOT EXCEED 100 FEET.
- 5. REFER TO MECHANICAL PLANS FOR HEATING AND VENTING EQUIPMENT LOCATIONS.
- 6. J-BOX LOCATIONS ABOVE SUSPENDED UP-LIGHTS TO BE COORDINATED WITH FIXTURE CONNECTION TO PROVIDE MINIMAL TRAVEL PATH OF ELECTRICAL WIRE. APPROXIMATE LOCATIONS ARE SHOWN ON REFLECTED CEILING PLANS.

IDENTIFICATION STAMP DIV. OF THE STATE ARCHITECT APP: 03-122151 INC:

REVIEWED FOR
SS FLS ACS D
DATE: 11/02/2022

# abode communities architecture

PROJECT:

## LAEP EARLY CHILDHOOD CENTER

13928 KORNBLUM AVE. HAWTHORNE, CA 90250

CLIENT:

Los Angeles Education Partnership 1541 Wilshire Blvd., Suite 200 Los Angeles, CA 90017 T: 213.622.5237

ARCHITECT:

Abode Communities 1149 S. Hill Street, Suite 700 Los Angeles, CA 90015 T: 213.629.2702

<u>CIVIL</u> **Breen Engineering** 

CONSULTANTS:

1983 W. 190th St., Suite 200 Torrance, CA 90504 T: 310.464.8404

ELECTRICAL/ PLUMBING

Breen Engineering

1983 W. 190th St., Suite 200

Torrance, CA 90504


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STRUCTURAL

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#### DSA APPLICATION NUMBER: 03-122151

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PROGRESS SET 02.01.22

DSA PROGRESS SET 03.02.22

DSA APPLICATION SET 04.01.22

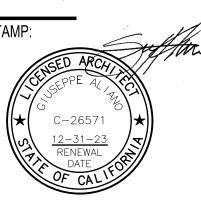DSA BACK-CHECK SET 10.05.22


DSA BACK-CHECK SET 10.24.22

SHEET NAME:
BUNGALOW 02
REFLECTED
CEILING PLAN

SHEET NUMBER: A6.02

DSA BACK-CHECK SET 11.01.22

SUED: 08/08,	/2022											Abode Communities Architecture
ITEM	FIXTURE TYPE	LOCATION	MANUFACTURER	PRODUCT NAME	MODEL #	COLOR/FINISH	DIMENSIONS	COLOR TEMP.	LUMENS	WATTS	BUG	NOTES
OMMO	N AREA FIXTURI	ES										
-C01	2x4 LIGHT	TYPICAL CEILING FIXTURE	LITHONIA	BLC CENTER BASKET TROFFER	TBD	WHITE	24"x48"	3500K	TBD	TBD	N/A	
L-C02	VANITY LIGHT	RESTROOM	PROGRESS	CCT SLECTABLE BATH LIGHT	P300239-060-CS	FROSTED ACRYLIC	26" x 6" (APPROX.)	3000K	2124	24	N/A	
L-C03	UNDERMOUNT CABINET LIGHT	KITCHEN	BRUCK	wUndercab	138546-16-3000K-90-120V-WH	WHITE	16"×1"	3000K	650	10	N/A	
EXIT1	EXIT SIGN	CEILING	LITHONIA	EDG amd EDGR	EDG-G/EDGR-G-EL	BRUSHED ALUMINUM	8" x 13"	GREEN	N/A	2.2/4.5	N/A	provide battery back-up; ceiling (recessed) or wall mount, per plans and elevations

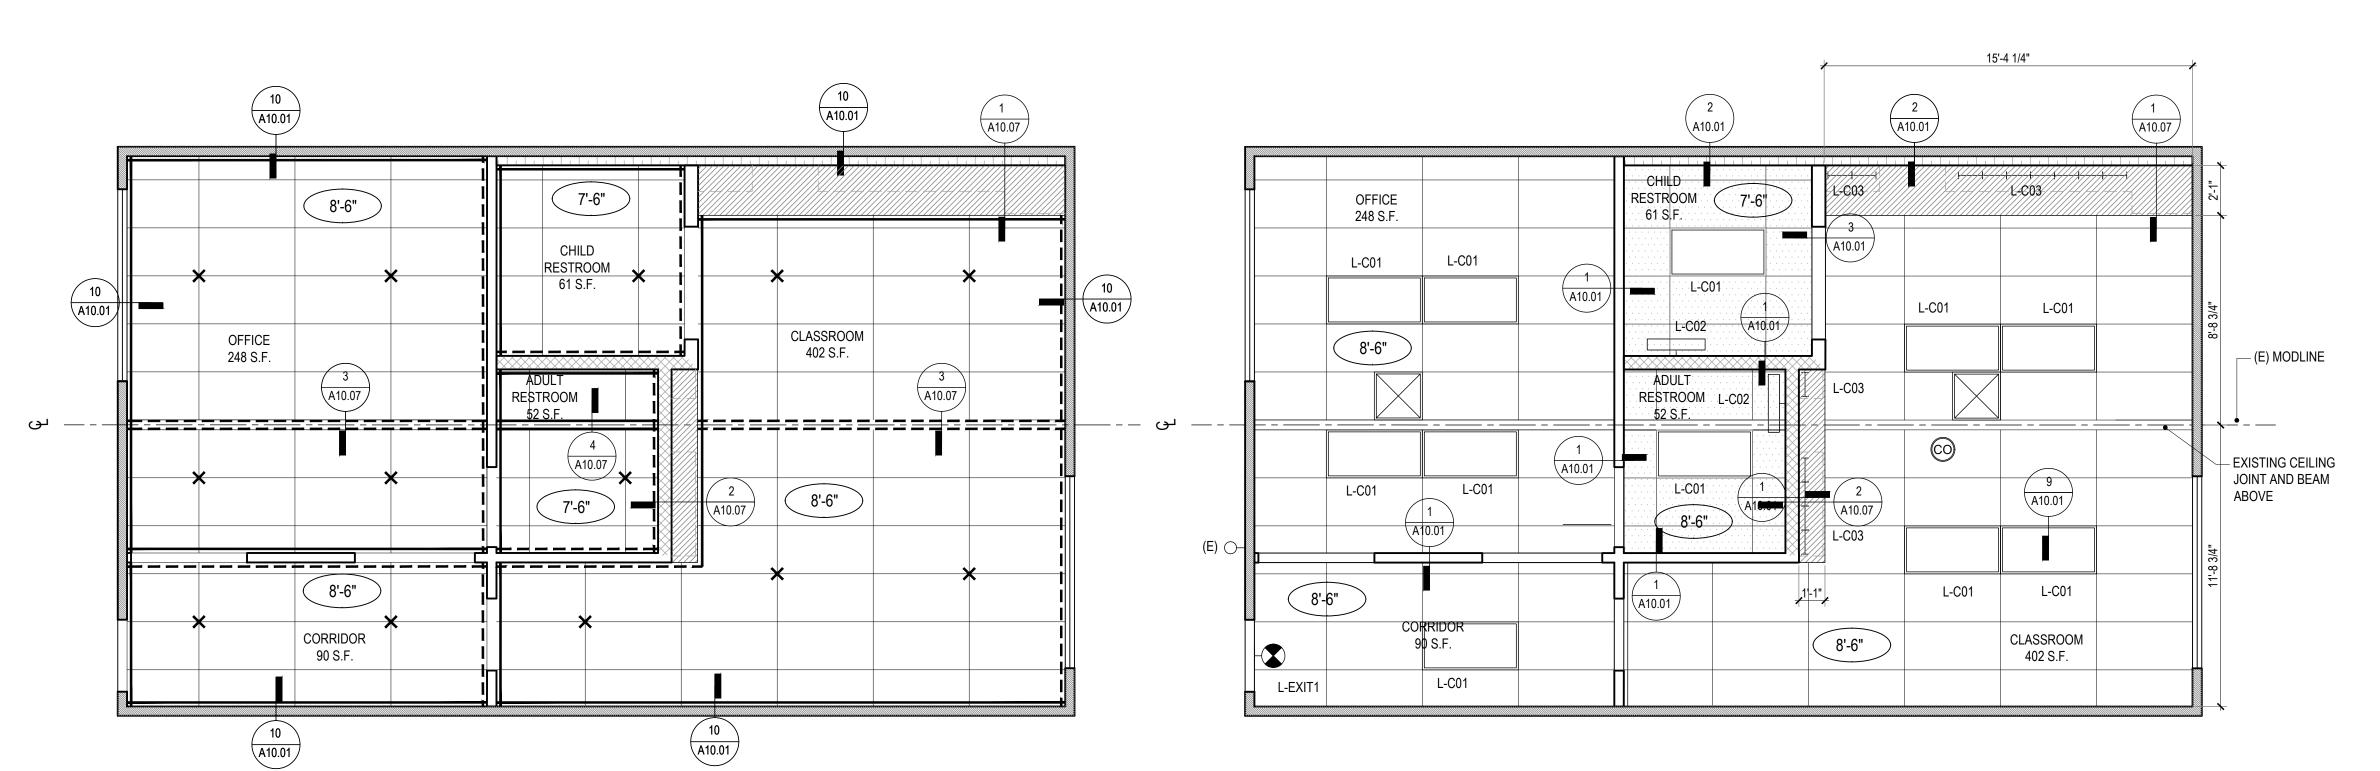


BUNGALOW 03 BRACING DIAGRAM SCALE: 1/4" = 1'-0"

BUNGALOW 03 REFLECTED CEILING PLAN SCALE: 1/4" = 1'-0"



#### **LEGEND**



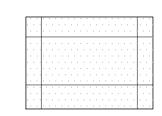

NEW T-BAR CEILING WITH 2'X4' VINYL COATED "WASHABLE" ACOUSTICAL PANELS @ 8'-6" MIN., U.N.O. REPLACE PANELS AS NEEDED.




NEW SOFFIT @ 7'-0" MIN., U.N.O.

X

RIGID VERTICAL CEILING STRUT, REFER TO **DETAIL 8/A10.01** 



L-C01 NEW 24" X 48" TROFFER

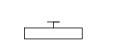

 $\overline{\phantom{a}}$ 

L-C02 NEW 36" VANITY LIGHT





EXISTING EXTERIOR LIGHTING

NEW UNDERCABINET LIGHT



L-EXIT1 NEW EXIT SIGNAGE (WALL MOUNTED), SEE ELECTRICAL DWG.



NEW CARBON MONOXIDE DETECTOR (CEILING MOUNTED), SEE ELECTRICAL DWG.



2'X2' CEILING SUPPLY DIFFUSER, SEE MECHANICAL PLANS

INDICATES FIXED SIDE, REFER TO DETAIL 40/A40.04

#### **NOTES**

- 1. ALL DIMENSIONS ARE TO CENTERLINE OF ELECTRICAL FIXTURE OR TO FACE OF FINISH MATERIAL UNLESS NOTED OTHERWISE.
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- 5. REFER TO MECHANICAL PLANS FOR HEATING AND VENTING EQUIPMENT LOCATIONS.
- 6. J-BOX LOCATIONS ABOVE SUSPENDED UP-LIGHTS TO BE COORDINATED WITH FIXTURE CONNECTION TO PROVIDE MINIMAL TRAVEL PATH OF ELECTRICAL WIRE. APPROXIMATE LOCATIONS ARE SHOWN ON REFLECTED CEILING PLANS.

IDENTIFICATION STAMP DIV. OF THE STATE ARCHITEC APP: 03-122151 INC: REVIEWED FOR SS 🗹 FLS 🗹 ACS 🗹 DATE: <u>11/02/2022</u>

#### abode communities architecture

PROJECT:

#### LAEP EARLY CHILDHOOD CENTER

13928 KORNBLUM AVE. HAWTHORNE, CA 90250

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T: 213.622.5237 ARCHITECT:

**Abode Communities** 1149 S. Hill Street, Suite 700 Los Angeles, CA 90015 T: 213.629.2702

CONSULTANTS:


**Breen Engineering** 1983 W. 190th St., Suite 200 Torrance, CA 90504 T: 310.464.8404

MECHANICAL/ ELECTRICAL/ PLUMBING **Breen Engineering** 1983 W. 190th St., Suite 200 Torrance, CA 90504 T: 310.464.8404

STRUCTURAL **Breen Engineering** 1983 W. 190th St., Suite 200 Torrance, CA 90504 T: 310.464.8404

#### DSA APPLICATION NUMBER: 03-122151

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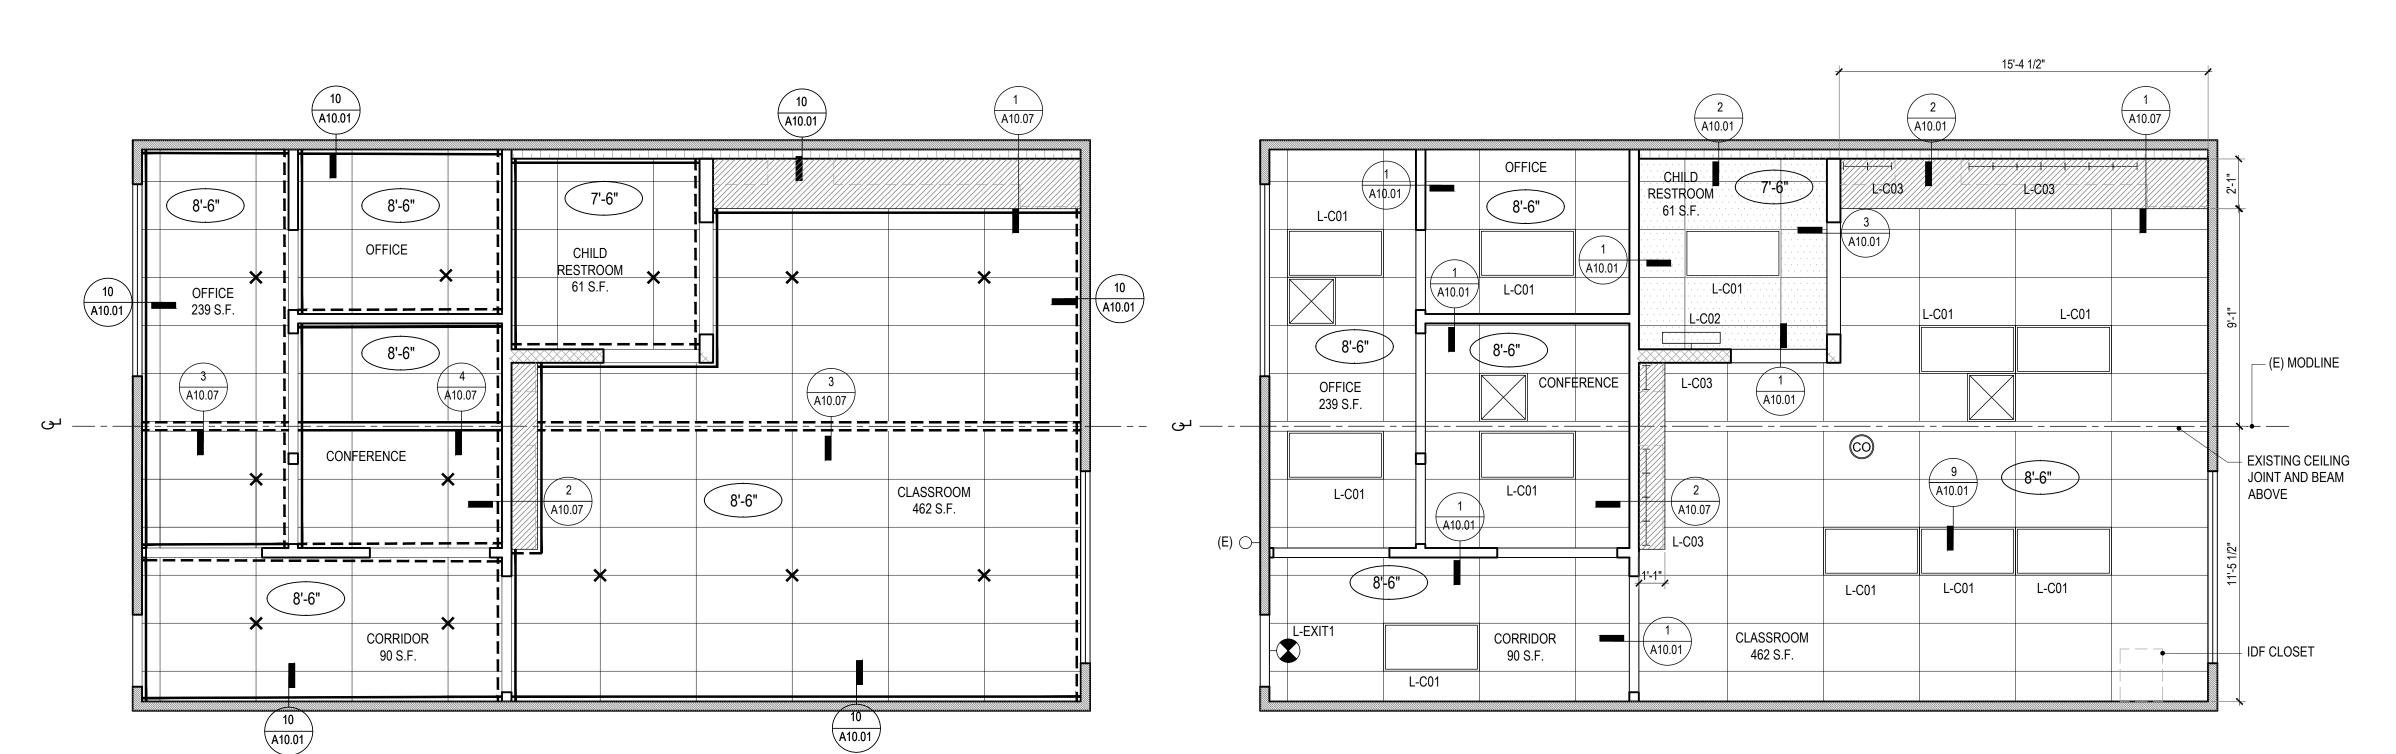
DATE REV PROGRESS SET 02.01.22 DSA PROGRESS SET 03.02.22 DSA APPLICATION SET 04.01.22 DSA BACK-CHECK SET 10.05.22 DSA BACK-CHECK SET 10.24.22 DSA BACK-CHECK SET 11.01.22
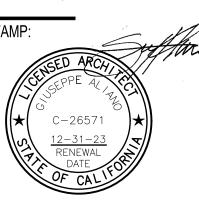
> SHEET NAME: BUNGALOW 03 REFLECTED **CEILING PLAN**

SHEET NUMBER:

A6.03

FIXTURE TYPE  REA FIXTURES 2x4 LIGHT  'ANITY LIGHT	LOCATION  S  TYPICAL CEILING FIXTURE  RESTROOM	MANUFACTURER  LITHONIA	PRODUCT NAME  BLC CENTER BASKET	MODEL#	COLOR/FINISH	DIMENSIONS	COLOR TEMP.	LUMENS	WATTS	BUG	Abode Communities Architecture  NOTES
REA FIXTURES	S TYPICAL CEILING FIXTURE		BLC CENTER BASKET	MODEL#	COLOR/FINISH	DIMENSIONS	COLOR TEMP.	LUMENS	WATTS	BUG	NOTES
2x4 LIGHT	TYPICAL CEILING FIXTURE	LITHONIA	BLC CENTER BASKET		l						
		LITHONIA	BLC CENTER BASKET								
'ANITY LIGHT	RESTROOM		TROFFER	TBD	WHITE	24"x48"	3500K	TBD	TBD	N/A	
	RESTROOM	PROGRESS	CCT SLECTABLE BATH LIGHT	P300239-060-CS	FROSTED ACRYLIC	26" x 6" (APPROX.)	3000K	2124	24	N/A	
NDERMOUNT ABINET LIGHT	KITCHEN	BRUCK	wUndercab	138546-16-3000K-90-120V-WH	WHITE	16" x 1"	3000K	650	10	N/A	
EVIT SICN	CELLING	LITHONIA	EDC and EDC2	EDC C/EDCB C F	PDIICHED ALLIAMANIA	9" v 19"	CREEN	NZA	22/45	NIA	provide battery back-up; ceiling (recessed) or wall mount, per plans and elevations
	UT SIGN										




#### BUNGALOW 04 BRACING DIAGRAM

SCALE: 1/4" = 1'-0"


SCALE: 1/4" = 1'-0"



#### **LEGEND**

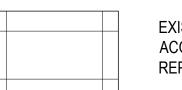

EXISTING T-BAR CEILING WITH 2'X4' ACOUSTICAL PANELS @ 8'-6" MIN., U.N.O. REPLACE PANELS AS NEEDED.

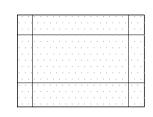

NEW T-BAR CEILING WITH 2'X4' VINYL COATED "WASHABLE" ACOUSTICAL PANELS @ 8'-6" MIN., U.N.O. REPLACE PANELS AS NEEDED.



NEW SOFFIT @ 7'-0" MIN., U.N.O.



X

RIGID VERTICAL CEILING STRUT, REFER TO **DETAIL 8/A10.01** 




L-C01 NEW 24" X 48" TROFFER



L-C02 **NEW 36" VANITY LIGHT** 



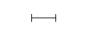

NEW UNDERCABINET LIGHT



 $\overline{\Box}$ 

NEW EXIT SIGNAGE (WALL MOUNTED) SEE ELECTRICAL DWG.

EXISTING EXTERIOR LIGHTING



NEW CARBON MONOXIDE DETECTOR (CEILING MOUNTED), SEE ELECTRICAL DWG.



2'X2' CEILING SUPPLY DIFFUSER, SEE MECHANICAL PLANS

INDICATES FIXED SIDE, REFER TO

#### **NOTES**

- 1. ALL DIMENSIONS ARE TO CENTERLINE OF ELECTRICAL FIXTURE OR TO FACE OF FINISH MATERIAL UNLESS NOTED OTHERWISE.
- 2. CEILING HEIGHTS, AND LOCATIONS OF CEILING JOINTS AND GRID TO BE VERIFIED IN FIELD.
- 3. ALL FIXTURES TO BE HIGH EFFICIENCY AND/OR ENERGY STAR RATED. AND COMPLY WITH TITLE 24 REQUIREMENTS.
- 4. EXIT SIGNS AND DIRECTIONAL SIGNS SHALL HAVE A MINIMUM HEIGHT OF 6" HIGH BY 3/4" STROKE BLOCK LETTERS ON A CONTRASTING BACKGROUND. SPACING BETWEEN SIGNS SHALL NOT EXCEED 100 FEET.
- 5. REFER TO MECHANICAL PLANS FOR HEATING AND VENTING EQUIPMENT LOCATIONS.
- 6. J-BOX LOCATIONS ABOVE SUSPENDED UP-LIGHTS TO BE COORDINATED WITH FIXTURE CONNECTION TO PROVIDE MINIMAL TRAVEL PATH OF ELECTRICAL WIRE. APPROXIMATE LOCATIONS ARE SHOWN ON REFLECTED CEILING PLANS.

IDENTIFICATION STAMP DIV. OF THE STATE ARCHITEC APP: 03-122151 INC: REVIEWED FOR SS 🗹 FLS 🗹 ACS 🗹 DATE: <u>11/02/2022</u>

#### abode communities architecture

PROJECT:

#### LAEP EARLY CHILDHOOD CENTER

13928 KORNBLUM AVE. HAWTHORNE, CA 90250

CLIENT:

#### Los Angeles Education Partnership 1541 Wilshire Blvd., Suite 200 Los Angeles, CA 90017 T: 213.622.5237

ARCHITECT:

**Abode Communities** 1149 S. Hill Street, Suite 700 Los Angeles, CA 90015 T: 213.629.2702

CONSULTANTS:


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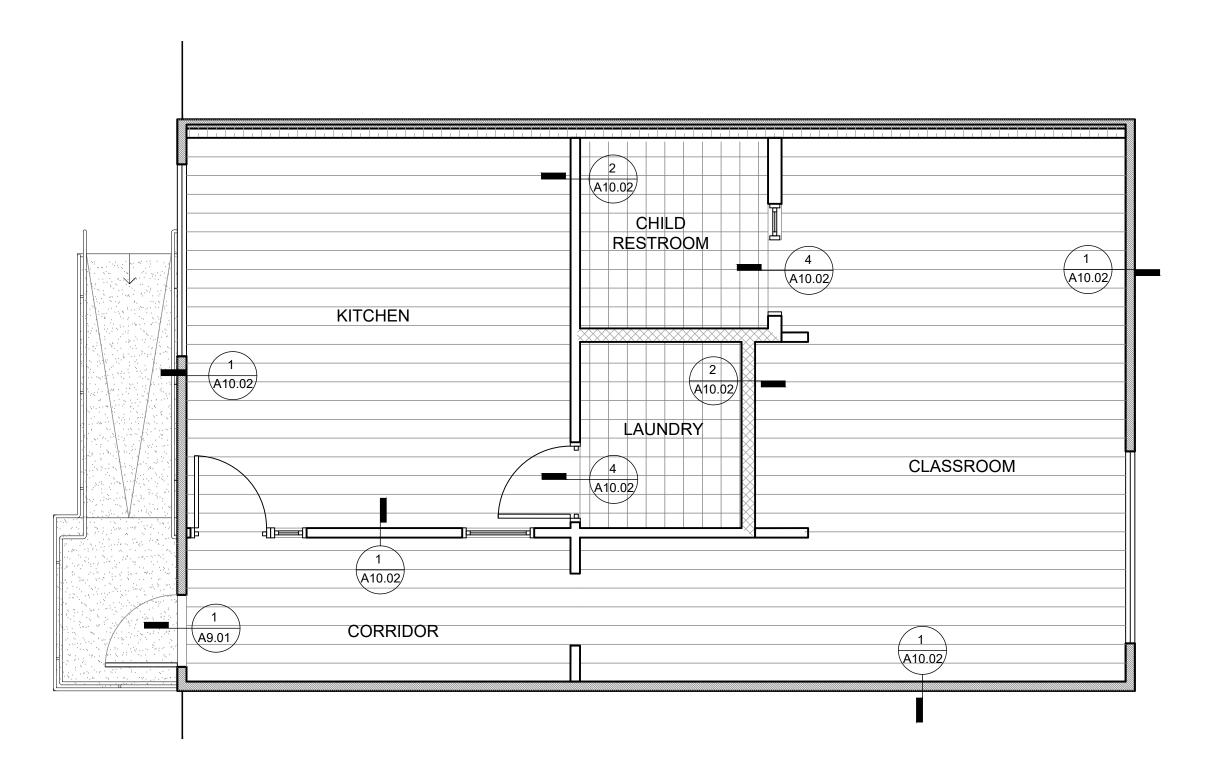
> SHEET NAME: **BUNGALOW 04** REFLECTED **CEILING PLAN**

SHEET NUMBER: A6.04

BUNGALOW 04 REFLECTED CEILING PLAN

PR	OJE	CT	FIN	ISHI	es t	ΑB	LE

AEP CHILDCARE										
3.08/2022									1	Abode Communities Architecture
MANUFACURER	COLOR	CODE	CSI	CHARACTERISTICS	FINISH	MANUFACURER	COLOR	CODE	CSI	CHARACTERISTICS
DUNN EDWARDS	WHITE	DEW380	99100	SEMI-GLOSS, WALL COLOR	RF-1	FORBO	TBD	51910	096517	STRIATO SHEET LINOLEUM
DUNN EDWARDS	TBD	TBD	99100	COMMON AREA ACCENT	RF-2	FORBO	TBD	51911	096517	STRIATO SHEET LINOLEUM
DUNN EDWARDS	TBD	TBD	99100	COMMON AREA ACCENT	RF-3	FORBO	TBD	H5408	096517	STRIATO SHEET LINOLEUM
DUNN EDWARDS	TBD	TBD	99100	COMMON AREA ACCENT						
DUNN EDWARDS	TBD	TBD	99100	COMMON AREA ACCENT	BA-1	TBD	TBD	TBD	062023	4" RUBBER BASE
DUNN EDWARDS	TBD	TBD	99100	COMMON AREA ACCENT						
DUNN EDWARDS	TBD	TBD	99100	TRIM						
WILSONART	TBD	TBD	064023	CABINET LAMINATE (LOWER)						
WILSONART	TBD	TBD	066423	CABINET LAMINATE (UPPER)						
HI-MACS	Tundra Quartz (G065)	TBD	066140	COUNTERTOPS, MATTE FINISH						
MARLITE	Symmetrix	TBD	66400	TILE PATTERN, AT RESTROOMS, SINKS						
DRAPER	TBD	TBD	122413	ROLLER SHADE (50%)						
DRAPER	TBD	TBD	122413	ROLLER SHADE (BLACKOUT)						
	MANUFACURER  DUNN EDWARDS  DUNN EDWARDS  DUNN EDWARDS  DUNN EDWARDS  DUNN EDWARDS  DUNN EDWARDS  WILSONART  WILSONART  HI-MACS  MARLITE  DRAPER	MANUFACURER  COLOR  DUNN EDWARDS  TBD  WILSONART  TBD  WILSONART  TBD  HI-MACS  TUNDRA QUARTZ (G065)  MARLITE  DRAPER  TBD	MANUFACURER  COLOR  CODE  DUNN EDWARDS  TBD  TBD  DUNN EDWARDS  TBD  TBD  DUNN EDWARDS  TBD  TBD  DUNN EDWARDS  TBD  TBD  TBD  DUNN EDWARDS  TBD  TBD  TBD  TBD  TBD  TBD  TBD  T	MANUFACURER         COLOR         CODE         CSI           DUNN EDWARDS         WHITE         DEW380         99100           DUNN EDWARDS         TBD         TBD         99100           WILSONART         TBD         TBD         064023           WILSONART         TBD         TBD         066140           MARLITE         SYMMETRIX         TBD         1BD         66400           DRAPER         TBD         TBD         122413	MANUFACURER  COLOR  CODE  CSI  CHARACTERISTICS  CHARACTERISTICS  DUNN EDWARDS  WHITE  DEW380  99100  SEMI-GLOSS, WALL COLOR  COMMON AREA ACCENT  DUNN EDWARDS  TBD  TBD  79100  TRIM  WILSONART  TBD  TBD  TBD  TBD  TBD  TBD  TBD  T	MANUFACURER COLOR CODE CSI CHARACTERISTICS FINISH  DUNN EDWARDS WHITE DEW380 P9100 SEMI-GLOSS, WALL COLOR RF-1  DUNN EDWARDS TBD TBD P9100 COMMON AREA ACCENT RF-2  DUNN EDWARDS TBD TBD P9100 COMMON AREA ACCENT RF-3  DUNN EDWARDS TBD TBD P9100 COMMON AREA ACCENT  BA-1  DUNN EDWARDS TBD TBD P9100 COMMON AREA ACCENT BA-1  DUNN EDWARDS TBD TBD P9100 TBD P9100 TRIM  WILSONART TBD TBD TBD TBD TBD TBD TBD TBD TBD TB	MANUFACURER COLOR CODE CSI CHARACTERISTICS FINISH MANUFACURER  DUNN EDWARDS WHITE DEW380 99100 SEMI-GLOSS, WALL COLOR RF-1 FORBO  DUNN EDWARDS TBD TBD 99100 COMMON AREA ACCENT RF-3 FORBO  DUNN EDWARDS TBD TBD TBD 99100 COMMON AREA ACCENT RF-3 FORBO  DUNN EDWARDS TBD TBD TBD 99100 COMMON AREA ACCENT BA-1 TBD  DUNN EDWARDS TBD TBD 99100 COMMON AREA ACCENT BA-1 TBD  DUNN EDWARDS TBD TBD 99100 TRIM  WILSONART TBD TBD TBD O64023 CABINET LAMINATE (LOWER)  HI-MACS TUNDRA QUARTZ (G065) TBD TBD O66140 COUNTERIOPS, MATTE FINISH MANUFACURER  MANUFACURER  FINISH MANUFACURER  MANUFACURER  FINISH MANUFACURER  MANUFACURER  FINISH MANUFACURER  FORBO  COMMON AREA ACCENT  RF-1 FORBO  RF-1 FORBO  RF-2 FORBO  RF-2 FORBO  RF-2 FORBO  RF-2 FORBO  RF-3 FORBO  RF-3 FORBO  RF-2 FORBO  RF-2 FORBO  RF-2 FORBO  RF-2 FORBO  RF-2 FORBO  RF-2 FORBO  RF-1 FORBO  RF-2 FORBO  RF-3 FORBO	COLOR	MANUFACURER   COLOR   CODE   CSI	CODE   CSI

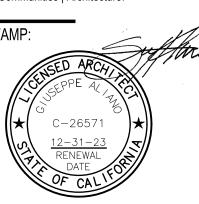

BUNGALOW 01 FINISH PLAN SCALE: 1/4" = 1'-0"





#### LEGEND



LINOLEUM FLOOR W/ 6" COVE BASE (RB-1) SEE FINISH SCHEDULE



RF-2 LINOLEUM FLOOR W/ 6" COVE BASE (RB-1) SEE FINISH SCHEDULE



(E) ELASTOMERIC WALKWAY (REPAIR AS NEEDED)

#### INTERIOR FINISH NOTES

- PROVIDE PAINT FINISHES IN THE COLORS LISTED ON THE FINISH PLANS AND ELEVATIONS. ALL PAINTS ARE DUNN-EDWARDS UNLESS OTHERWISE NOTED. THIS DOES NOT PRECLUDE THE APPROVAL OF SIMILAR PRODUCTS OF OTHER MANUFACTURERS.
- 2. ALL FLOOR TRANSITIONS BETWEEN CARPET AND V.C.T. SHALL BE MOULDING 710 BY BURKE-MERCER OR EQUAL. COLOR: BLACK
- 3. ALIGN FLOORING TRANSITION STRIP DIRECTLY BENEATH DOOR, WHERE OCCURS.
- 4. NOT USED
- 5. FOR PATTERNS AND ACCENT COLOR APPLICATION, SEE INTERIOR **ELEVATIONS & FLOOR FINISH DIAGRAMS.**
- 6. FULLY EXTEND RESILIENT FLOORS IN ALL CASEWORK WHERE KNEE ACCESS IS REQUIRED AT CLASSROOMS AND STAFF LOUNGE UNDER SINK AREA AND REFRIGERATOR AREA.
- MANUAL ROLLER SHADES W/ FACIA TO BE CUSTOM SIZED TO MATCH WINDOW OPENING AND SHALL HAVE AN OPERATOR ON EACH SIDE. WHEN MULTIPLE SHADES COVER A LARGE WINDOW OPENING, ALL SHADES IN THE WINDOW OPENING SHALL BE COORDINATED IN ORDER TO OPERATE SIMULTANEOUSLY WITH A SINGLE OPERATOR ON EACH SIDE.
- NOT USED
- 9. NEW HARDWOOD PLYWOOD, PARTICLE BOARD, AND MEDIUM DENSITY FIBERBOARD COMPOSITE WOOD PRODUCTS USED IN THE INTERIOR OR EXTERIOR OF THE BUILDING SHALL MEET THE FORMALDEHYDE LIMITS LISTED IN TABLE 5.504.4.5.
- 10. THE FORMALDEHYDE EMISSIONS VERIFICATION CHECKLIST, FORM GRN 3, SHALL BE COMPLETED PRIOR TO FINAL INSPECTION APPROVAL. THE MANUFACTURER'S SPECIFICATIONS SHOWING FORMALDEHYDE CONTENT FOR ALL APPLICABLE WOOD PRODUCTS SHALL BE READILY AVAILABLE AT THE JOB SITE AND BE PROVIDED TO THE FIELD INSPECTOR FOR VERIFICATION. (5.504.4.5)
- 11. THE VOC CONTENT VERIFICATION CHECKLIST, FORM GRN 2, SHALL BE COMPLETED AND VERIFIED PRIOR TO FINAL INSPECTION APPROVAL. THE MANUFACTURER'S SPECIFICATIONS SHOWING VOC CONTENT FOR ALL APPLICABLE PRODUCTS SHALL BE READILY AVAILABLE AT THE JOB SITE AND BE PROVIDED TO FIELD INSPECTOR FOR VERIFICATION.
- 12. 80% OF THE TOTAL AREA RECEIVING RESILIENT FLOORING SHALL COMPLY WITH ONE OR MORE OF THE FOLLOWING:
- 12.1.1. VOC emission limits defined in the CHPS High Performance Products Database.
- Products compliant with the CHPS criteria certified under the Greenguard Children & Schools Program.
- 12.1.3. Certification under the Resilient Floor Covering Institute (RFCI) Floor Score Program.
- Meet the California Department of Public Health's Specification 01350.

IDENTIFICATION STAMP DIV. OF THE STATE ARCHITEC APP: 03-122151 INC: REVIEWED FOR SS 🗹 FLS 🗹 ACS 🗹 DATE: 11/02/2022

#### abode communities architecture

#### LAEP EARLY CHILDHOOD CENTER

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ARCHITECT:

T: 213.622.5237

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CONSULTANTS: <u>CIVIL</u>

**Breen Engineering** 


1983 W. 190th St., Suite 200 Torrance, CA 90504 T: 310.464.8404 MECHANICAL/ **ELECTRICAL/ PLUMBING** 

**Breen Engineering** 1983 W. 190th St., Suite 200 Torrance, CA 90504 T: 310.464.8404 STRUCTURAL

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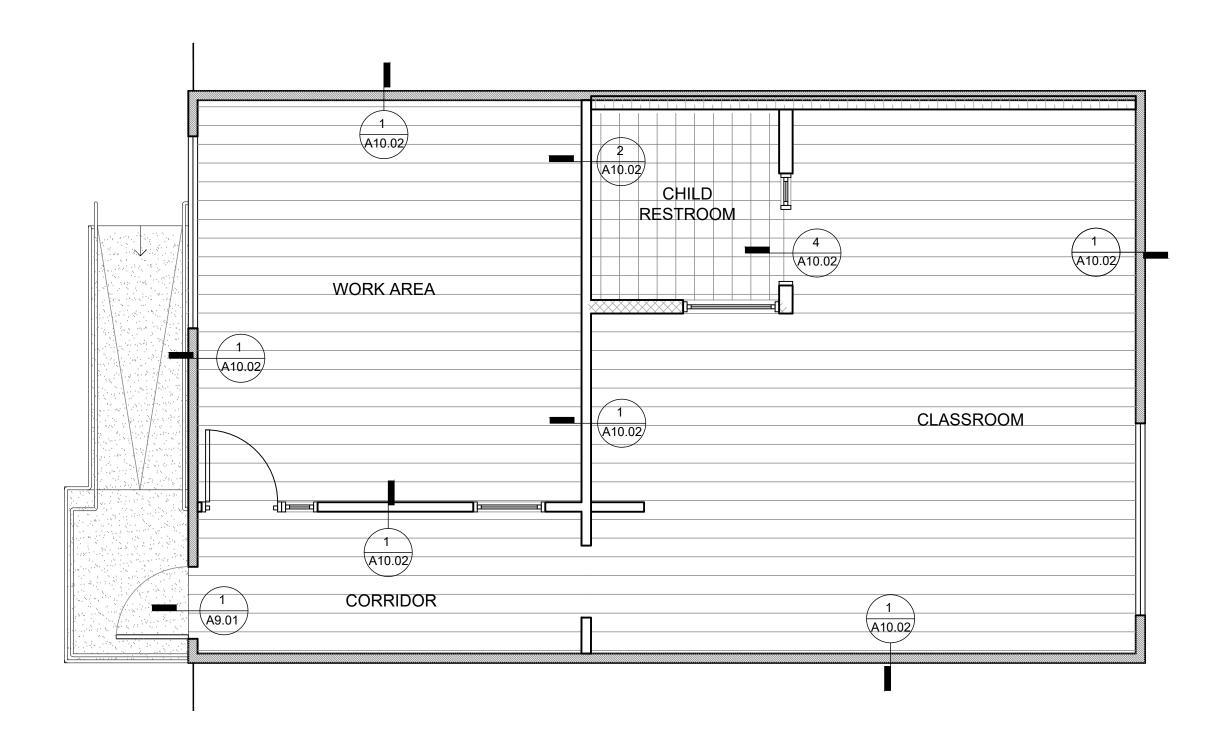
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SHEET NAME:

**BUNGALOW 01** FINISH PLAN

SHEET NUMBER:

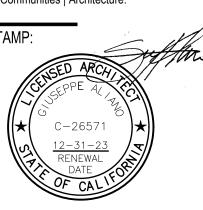LAEP	AEP CHILDCARE											
ISSUED:	08.08/2022		,			_						Abode Communities Architecture
	MANUFACURER	COLOR	CODE	CSI	CHARACTERISTICS		FINISH	MANUFACURER	COLOR	CODE	CSI	CHARACTERISTICS
									-			
P-1	DUNN EDWARDS	WHITE	DEW380	99100	SEMI-GLOSS, WALL COLOR		RF-1	FORBO	TBD	51910	096517	STRIATO SHEET LINOLEUM
P-2	DUNN EDWARDS	TBD	TBD	99100	COMMON AREA ACCENT		RF-2	FORBO	TBD	51911	096517	STRIATO SHEET LINOLEUM
P-3	DUNN EDWARDS	TBD	TBD	99100	COMMON AREA ACCENT		RF-3	FORBO	TBD	H5408	096517	STRIATO SHEET LINOLEUM
P-4	DUNN EDWARDS	TBD	TBD	99100	COMMON AREA ACCENT							
P-5	DUNN EDWARDS	TBD	TBD	99100	COMMON AREA ACCENT		BA-1	TBD	TBD	TBD	062023	4" RUBBER BASE
P-6	DUNN EDWARDS	TBD	TBD	99100	COMMON AREA ACCENT							
P-7	DUNN EDWARDS	TBD	TBD	99100	TRIM							
LM-1	WILSONART	TBD	TBD	064023	CABINET LAMINATE (LOWER)							
LM-2	WILSONART	TBD	TBD	066423	CABINET LAMINATE (UPPER)							
CT-1	HI-MACS	TUNDRA QUARTZ (G065)	TBD	066140	COUNTERTOPS, MATTE FINISH							
FRP-1	MARLITE	SYMMETRIX	TBD	66400	TILE PATTERN, AT RESTROOMS, SINKS							
RS-1	DRAPER	TBD	TBD	122413	ROLLER SHADE (50%)							
RS-1	DRAPER	TBD	TBD	122413	ROLLER SHADE (BLACKOUT)							
	,		,									



BUNGALOW 02 FINISH PLAN


SCALE: 1/4" = 1'-0"





#### LEGEND

LINOLEUM FLOOR W/ 6" COVE BASE (RB-1) SEE FINISH SCHEDULE

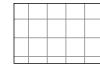

RF-2 LINOLEUM FLOOR W/ 6" COVE BASE (RB-1) SEE FINISH SCHEDULE



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- 4. NOT USED
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- 6. FULLY EXTEND RESILIENT FLOORS IN ALL CASEWORK WHERE KNEE ACCESS IS REQUIRED AT CLASSROOMS AND STAFF LOUNGE UNDER SINK AREA AND REFRIGERATOR AREA.
- 7. MANUAL ROLLER SHADES W/ FACIA TO BE CUSTOM SIZED TO MATCH WINDOW OPENING AND SHALL HAVE AN OPERATOR ON EACH SIDE. WHEN MULTIPLE SHADES COVER A LARGE WINDOW OPENING, ALL SHADES IN THE WINDOW OPENING SHALL BE COORDINATED IN ORDER TO OPERATE SIMULTANEOUSLY WITH A SINGLE OPERATOR ON EACH SIDE.
- 8. NOT USED
- 9. NEW HARDWOOD PLYWOOD, PARTICLE BOARD, AND MEDIUM DENSITY FIBERBOARD COMPOSITE WOOD PRODUCTS USED IN THE INTERIOR OR EXTERIOR OF THE BUILDING SHALL MEET THE FORMALDEHYDE LIMITS LISTED IN TABLE 5.504.4.5.
- 10. THE FORMALDEHYDE EMISSIONS VERIFICATION CHECKLIST, FORM GRN 3, SHALL BE COMPLETED PRIOR TO FINAL INSPECTION APPROVAL. THE MANUFACTURER'S SPECIFICATIONS SHOWING FORMALDEHYDE CONTENT FOR ALL APPLICABLE WOOD PRODUCTS SHALL BE READILY AVAILABLE AT THE JOB SITE AND BE PROVIDED TO THE FIELD INSPECTOR FOR VERIFICATION. (5.504.4.5)
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- 12. 80% OF THE TOTAL AREA RECEIVING RESILIENT FLOORING SHALL COMPLY WITH ONE OR MORE OF THE FOLLOWING:
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- 12.1.2. Products compliant with the CHPS criteria certified under the Greenguard Children & Schools Program.
- 12.1.3. Certification under the Resilient Floor Covering Institute
- (RFCI) Floor Score Program.
- Meet the California Department of Public Health's Specification 01350.

IDENTIFICATION STAMP DIV. OF THE STATE ARCHITECT

APP: 03-122151 INC:

REVIEWED FOR

SS FLS ACS D

DATE: 11/02/2022

# abode communities architecture

PROJECT:

## LAEP EARLY CHILDHOOD CENTER

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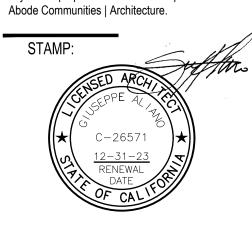
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DSA APPLICATION SET 04.01.22

DSA BACK-CHECK SET 10.05.22

DSA BACK-CHECK SET 10.24.22


DSA BACK-CHECK SET 11.01.22

SHEET NAME:
BUNGALOW 02
FINISH PLAN

SHEET NUMBER:

PROJECT FINIS	SHES TABLE
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LAEP	AEP CHILDCARE										
ISSUED:	08.08/2022										Abode Communities Architecture
	MANUFACURER	COLOR	CODE	CSI	CHARACTERISTICS	FINISH	MANUFACURER	COLOR	CODE	CSI	CHARACTERISTICS
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P-3	DUNN EDWARDS	TBD	TBD	99100	COMMON AREA ACCENT	RF-3	FORBO	TBD	H5408	096517	STRIATO SHEET LINOLEUM
P-4	DUNN EDWARDS	TBD	TBD	99100	COMMON AREA ACCENT						
P-5	DUNN EDWARDS	TBD	TBD	99100	COMMON AREA ACCENT	BA-1	TBD	TBD	TBD	062023	4" RUBBER BASE
P-6	DUNN EDWARDS	TBD	TBD	99100	COMMON AREA ACCENT						
P-7	DUNN EDWARDS	TBD	TBD	99100	TRIM						
LM-1	WILSONART	TBD	TBD	064023	CABINET LAMINATE (LOWER)						
LM-2	WILSONART	TBD	TBD	066423	CABINET LAMINATE (UPPER)						
CT-1	HI-MACS	TUNDRA QUARTZ (G065)	TBD	066140	COUNTERTOPS, MATTE FINISH						
FRP-1	MARLITE	SYMMETRIX	TBD	66400	TILE PATTERN, AT RESTROOMS, SINKS						
RS-1	DRAPER	TBD	TBD	122413	ROLLER SHADE (50%)						
RS-1	DRAPER	TBD	TBD	122413	ROLLER SHADE (BLACKOUT)						

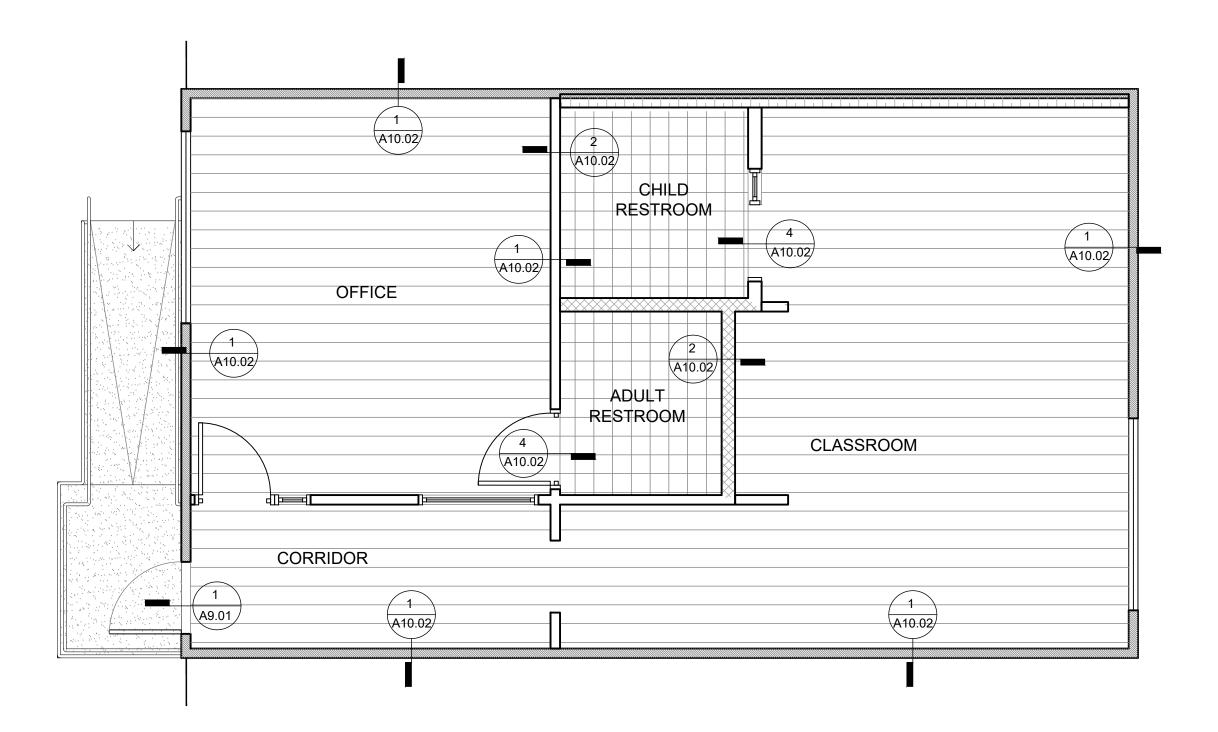

BUNGALOW 03 FINISH PLAN

SCALE: 1/4" = 1'-0"





#### LEGEND



LINOLEUM FLOOR
W/ 6" COVE BASE (RB-1)
SEE FINISH SCHEDULE



RF-2 LINOLEUM FLOOR W/ 6" COVE BASE (RB-1) SEE FINISH SCHEDULE



(E) ELASTOMERIC WALKWAY (REPAIR AS NEEDED)

#### INTERIOR FINISH NOTES

- 1. PROVIDE PAINT FINISHES IN THE COLORS LISTED ON THE FINISH PLANS AND ELEVATIONS. ALL PAINTS ARE DUNN-EDWARDS UNLESS OTHERWISE NOTED. THIS DOES NOT PRECLUDE THE APPROVAL OF SIMILAR PRODUCTS OF OTHER MANUFACTURERS.
- 2. ALL FLOOR TRANSITIONS BETWEEN CARPET AND V.C.T. SHALL BE MOULDING 710 BY BURKE-MERCER OR EQUAL. COLOR: BLACK (701)
- ALIGN FLOORING TRANSITION STRIP DIRECTLY BENEATH DOOR, WHERE OCCURS.
- 4. NOT USED
- 5. FOR PATTERNS AND ACCENT COLOR APPLICATION, SEE INTERIOR ELEVATIONS & FLOOR FINISH DIAGRAMS.
- 6. FULLY EXTEND RESILIENT FLOORS IN ALL CASEWORK WHERE KNEE ACCESS IS REQUIRED AT CLASSROOMS AND STAFF LOUNGE UNDER SINK AREA AND REFRIGERATOR AREA.
- 7. MANUAL ROLLER SHADES W/ FACIA TO BE CUSTOM SIZED TO MATCH WINDOW OPENING AND SHALL HAVE AN OPERATOR ON EACH SIDE. WHEN MULTIPLE SHADES COVER A LARGE WINDOW OPENING, ALL SHADES IN THE WINDOW OPENING SHALL BE COORDINATED IN ORDER TO OPERATE SIMULTANEOUSLY WITH A SINGLE OPERATOR ON EACH SIDE.
- 8. NOT USED
- 9. NEW HARDWOOD PLYWOOD, PARTICLE BOARD, AND MEDIUM DENSITY FIBERBOARD COMPOSITE WOOD PRODUCTS USED IN THE INTERIOR OR EXTERIOR OF THE BUILDING SHALL MEET THE FORMALDEHYDE LIMITS LISTED IN TABLE 5.504.4.5.
- 10. THE FORMALDEHYDE EMISSIONS VERIFICATION CHECKLIST, FORM GRN 3, SHALL BE COMPLETED PRIOR TO FINAL INSPECTION APPROVAL. THE MANUFACTURER'S SPECIFICATIONS SHOWING FORMALDEHYDE CONTENT FOR ALL APPLICABLE WOOD PRODUCTS SHALL BE READILY AVAILABLE AT THE JOB SITE AND BE PROVIDED TO THE FIELD INSPECTOR FOR VERIFICATION. (5.504.4.5)
- 11. THE VOC CONTENT VERIFICATION CHECKLIST, FORM GRN 2, SHALL BE COMPLETED AND VERIFIED PRIOR TO FINAL INSPECTION APPROVAL. THE MANUFACTURER'S SPECIFICATIONS SHOWING VOC CONTENT FOR ALL APPLICABLE PRODUCTS SHALL BE READILY AVAILABLE AT THE JOB SITE AND BE PROVIDED TO FIELD INSPECTOR FOR VERIFICATION.
- 12. 80% OF THE TOTAL AREA RECEIVING RESILIENT FLOORING SHALL COMPLY WITH ONE OR MORE OF THE FOLLOWING:
- 12.1.1. VOC emission limits defined in the CHPS High Performance Products Database.
- Products Database.

  12.1.2. Products compliant with the CHPS criteria certified under the
- Greenguard Children & Schools Program.
- 12.1.3. Certification under the Resilient Floor Covering Institute (RFCI) Floor Score Program.
- 12.1.4. Meet the California Department of Public Health's
  - Specification 01350.

IDENTIFICATION STAMP DIV. OF THE STATE ARCHITECT APP: 03-122151 INC:

REVIEWED FOR
SS FLS ACS DATE: 11/02/2022

# abode communities architecture

PROJECT:

## LAEP EARLY CHILDHOOD CENTER

13928 KORNBLUM AVE. HAWTHORNE, CA 90250

CLIENT:

Los Angeles Education Partnership 1541 Wilshire Blvd., Suite 200 Los Angeles, CA 90017

ARCHITECT:

T: 213.622.5237

Abode Communities 1149 S. Hill Street, Suite 700 Los Angeles, CA 90015 T: 213.629.2702

CONSULTANTS:

Breen Engineering
1983 W. 190th St., Suite 200
Torrance, CA 90504
T: 310.464.8404


MECHANICAL/ ELECTRICAL/ PLUMBING Breen Engineering 1983 W. 190th St., Suite 200 Torrance, CA 90504 T: 310.464.8404

STRUCTURAL

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#### DSA APPLICATION NUMBER: 03-122151

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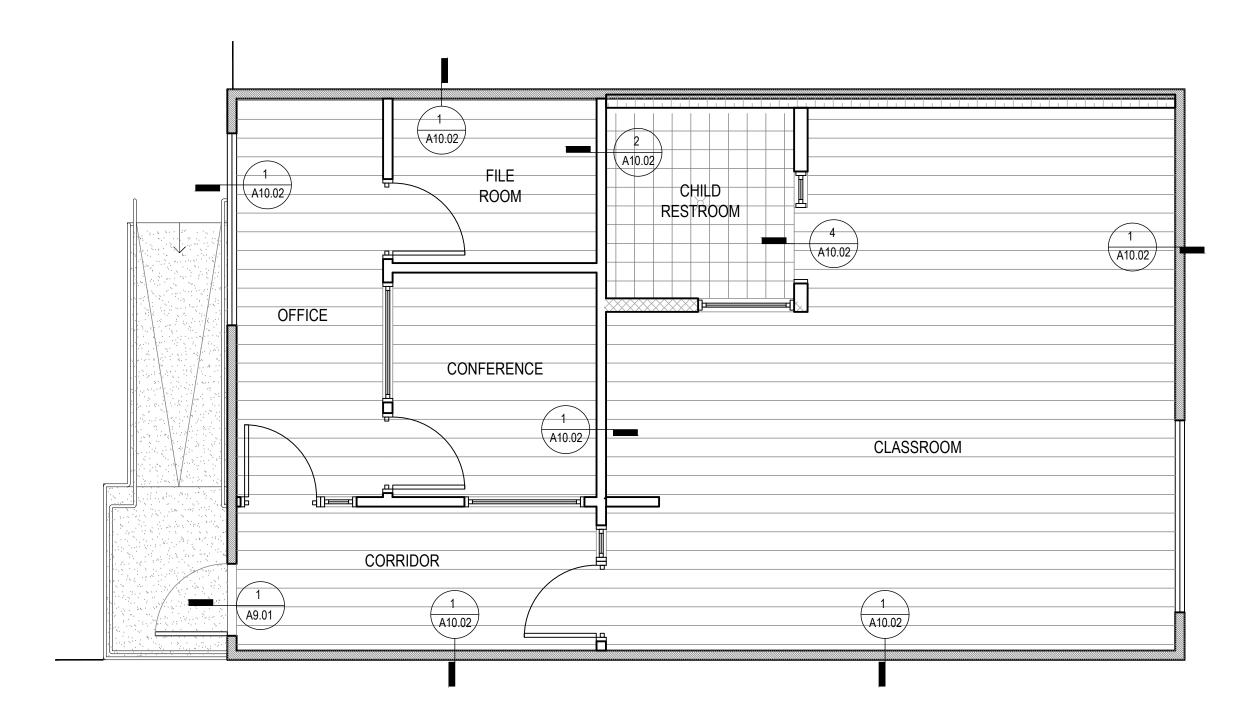
DATE REV
PROGRESS SET 02.01.22
DSA PROGRESS SET 03.02.22
DSA APPLICATION SET 04.01.22
DSA BACK-CHECK SET 10.05.22
DSA BACK-CHECK SET 10.24.22
DSA BACK-CHECK SET 11.01.22

SHEET NAME:
BUNGALOW 03
FINISH PLAN

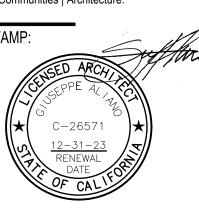SHEET NUMBER:

PROJECT FINISHE	E2 I	ARL	E
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LAEP	LAEP CHILDCARE											
ISSUED:	08.08/2022		,									Abode Communities Architecture
	MANUFACURER	COLOR	CODE	CSI	CHARACTERISTICS		FINISH	MANUFACURER	COLOR	CODE	CSI	CHARACTERISTICS
P-1	DUNN EDWARDS	WHITE	DEW380	99100	SEMI-GLOSS, WALL COLOR		RF-1	FORBO	TBD	51910	096517	STRIATO SHEET LINOLEUM
P-2	DUNN EDWARDS	TBD	TBD	99100	COMMON AREA ACCENT		RF-2	FORBO	TBD	51911	096517	STRIATO SHEET LINOLEUM
P-3	DUNN EDWARDS	TBD	TBD	99100	COMMON AREA ACCENT		RF-3	FORBO	TBD	H5408	096517	STRIATO SHEET LINOLEUM
P-4	DUNN EDWARDS	TBD	TBD	99100	COMMON AREA ACCENT							
P-5	DUNN EDWARDS	TBD	TBD	99100	COMMON AREA ACCENT		BA-1	TBD	TBD	TBD	062023	4" RUBBER BASE
P-6	DUNN EDWARDS	TBD	TBD	99100	COMMON AREA ACCENT							
P-7	DUNN EDWARDS	TBD	TBD	99100	TRIM							
LM-1	WILSONART	TBD	TBD	064023	CABINET LAMINATE (LOWER)				,			
LM-2	WILSONART	TBD	TBD	066423	CABINET LAMINATE (UPPER)							
CT-1	HI-MACS	TUNDRA QUARTZ (G065)	TBD	066140	COUNTERTOPS, MATTE FINISH				,			
FRP-1	MARLITE	Symmetrix	TBD	66400	TILE PATTERN, AT RESTROOMS, SINKS							
RS-1	DRAPER	TBD	TBD	122413	ROLLER SHADE (50%)							
RS-1	DRAPER	TBD	TBD	122413	ROLLER SHADE (BLACKOUT)							
			,									
			,									
			,									




BUNGALOW 04 FINISH PLAN


SCALE: 1/4" = 1'-0"





#### LEGEND

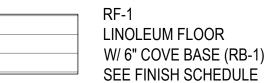

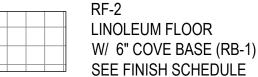



(E) ELASTOMERIC WALKWAY (REPAIR AS NEEDED)

#### INTERIOR FINISH NOTES

- 1. PROVIDE PAINT FINISHES IN THE COLORS LISTED ON THE FINISH PLANS AND ELEVATIONS. ALL PAINTS ARE DUNN-EDWARDS UNLESS OTHERWISE NOTED. THIS DOES NOT PRECLUDE THE APPROVAL OF SIMILAR PRODUCTS OF OTHER MANUFACTURERS.
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- 80% OF THE TOTAL AREA RECEIVING RESILIENT FLOORING SHALL COMPLY WITH ONE OR MORE OF THE FOLLOWING:
   12.1.1 VOC emission limits defined in the CHPS High Performance
- 12.1.1. VOC emission limits defined in the CHPS High Performance Products Database.
- 12.1.2. Products compliant with the CHPS criteria certified under the Greenguard Children & Schools Program.
- 12.1.3. Certification under the Resilient Floor Covering Institute (RFCI) Floor Score Program.
- 12.1.4. Meet the California Department of Public Health's Specification 01350.

IDENTIFICATION STAMP DIV. OF THE STATE ARCHITECT

APP: 03-122151 INC:

REVIEWED FOR

SS FLS ACS D

DATE: 11/02/2022

# abode communities architecture

PROJECT:

## LAEP EARLY CHILDHOOD CENTER

13928 KORNBLUM AVE. HAWTHORNE, CA 90250

CLIENT:

Los Angeles Education Partnership 1541 Wilshire Blvd., Suite 200 Los Angeles, CA 90017

ARCHITECT:

T: 213.622.5237

Abode Communities 1149 S. Hill Street, Suite 700 Los Angeles, CA 90015 T: 213.629.2702

CONSULTANTS:

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Torrance, CA 90504
T: 310.464.8404

MECHANICAL/

ELECTRICAL/ PLUMBING

Breen Engineering

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Torrance, CA 90504


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DATE REV
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DSA PROGRESS SET 03.02.22

DSA APPLICATION SET 04.01.22


DSA BACK-CHECK SET 10.05.22

DSA BACK-CHECK SET 10.24.22

DSA BACK-CHECK SET 11.01.22

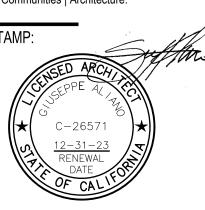SHEET NAME:
BUNGALOW 04
FINISH PLAN

SHEET NUMBER:

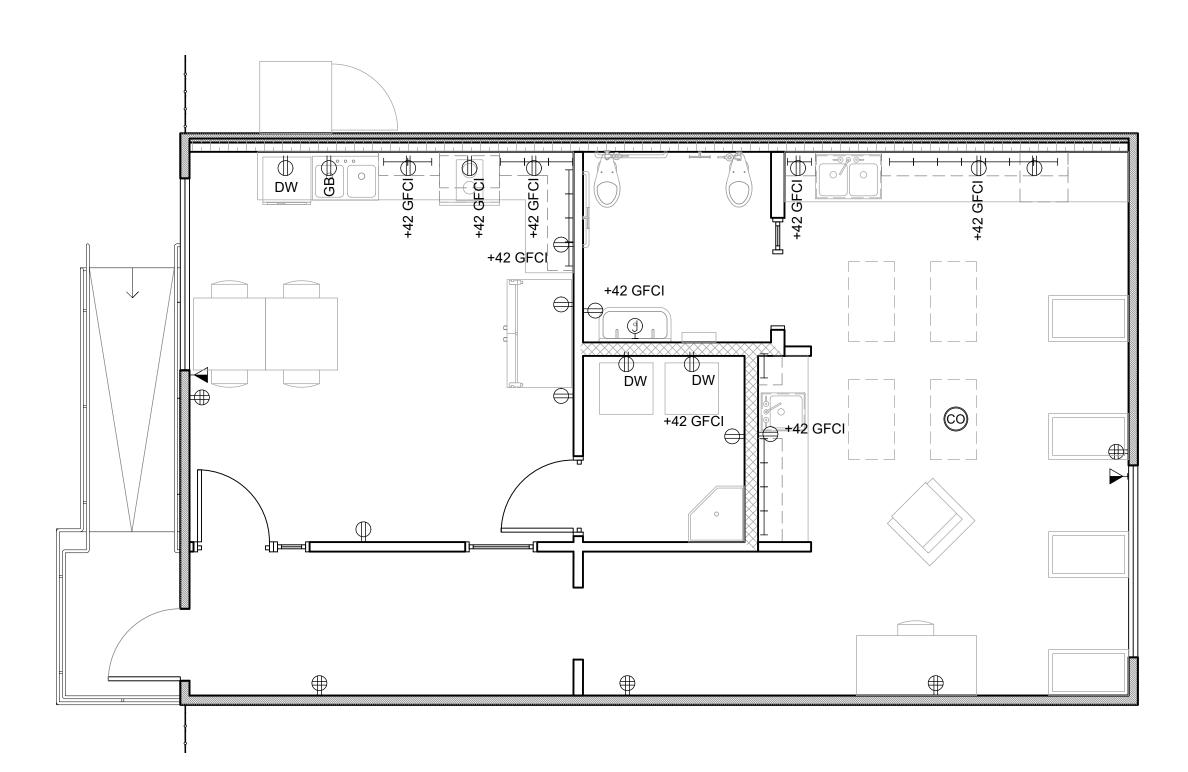

BUNGALOW 01 POWER AND COMMUNICATIONS PLAN

SCALE: 1/4" = 1'-0"





#### LEGEND

WALL MOUNTED DUPLEX MOUNT AT 18" A.F.F. U.O.N.

WALL MOUNTED DUPLEX FOR GARBAGE DISPOSAL

WALL MOUNTED DUPLEX FOR DISHWASHER, WASHER, AND DRYER

WALL MOUNTED QUADPLEX MOUNT AT 18" A.F.F. U.O.N.

> WALL MOUNTED TELEPHONE/DATA RECEPTACLE, MOUNT AT 18" A.F.F.

WALL MOUNTED J-BOX FOR RESTROOM WALL SCONCE

UNDERCABINET LIGHTING, SEE LIGHT FIXTURE SCHEDULE

IDENTIFICATION STAMP DIV. OF THE STATE ARCHITECT APP: 03-122151 INC: REVIEWED FOR SS 🗹 FLS 🗹 ACS 🗹 DATE: 11/02/2022

# abode communities architecture

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#### LAEP EARLY CHILDHOOD CENTER

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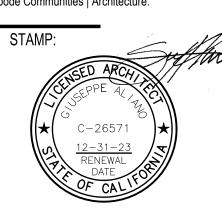
**STRUCTURAL Breen Engineering** 1983 W. 190th St., Suite 200 Torrance, CA 90504 T: 310.464.8404

#### NOTES

- 1. VERIFY ALL RECEPTACLE LOCATIONS WITH ARCHITECT AND CLIENT PRIOR TO FINAL INSTALLATION.
- 2. FURNITURE IS BY CLIENT UNDER SEPARATE CONTRACT AND IS NOT IN SCOPE. THEY ARE DEPICTED FOR PLANNING AND PLACEMENT OF FIXTURES AND RELATED SCOPE ITEMS ONLY.

#### DSA APPLICATION NUMBER: 03-122151


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DSA APPLICATION SET	04.01.22	
DSA BACK-CHECK SET	10.05.22	
DSA BACK-CHECK SET	10.24.22	
DSA BACK-CHECK SET	11.01.22	

SHEET NAME:
BUNGALOW 01 POWER AND COMMUNICATIONS PLAN

SHEET NUMBER:



BUNGALOW 02 POWER AND COMMUNICATIONS PLAN

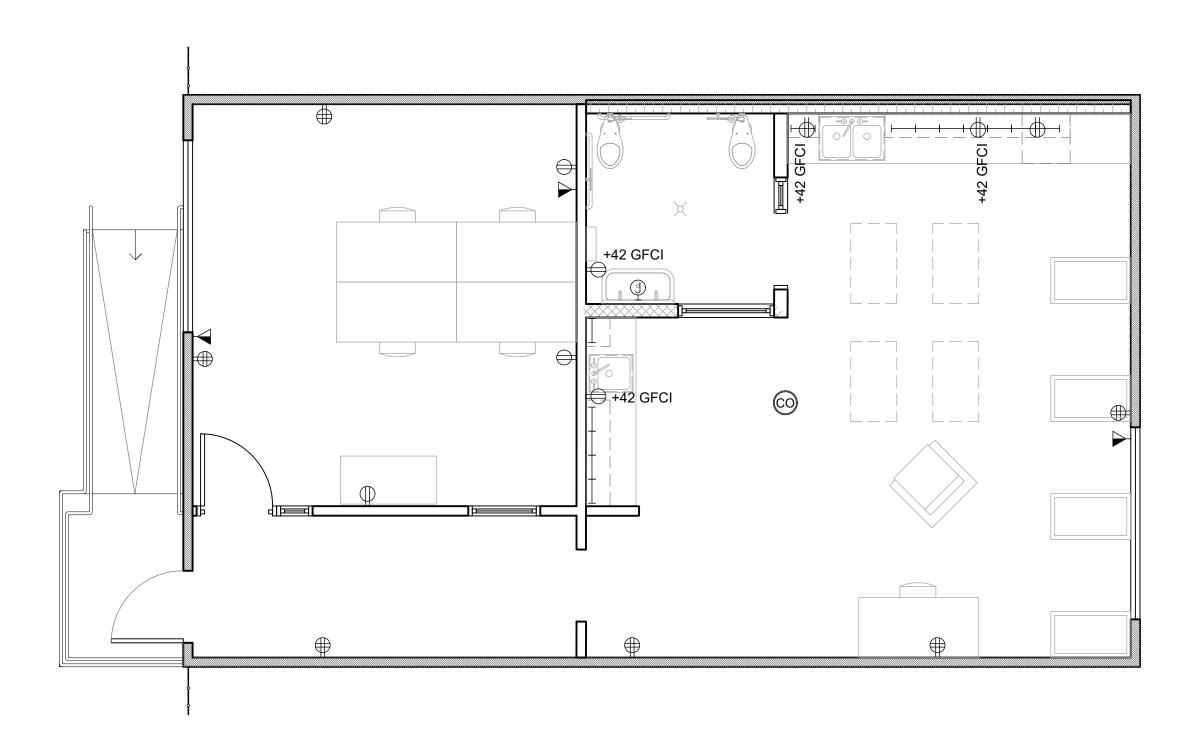SCALE: 1/4" = 1'-0"





#### LEGEND

- WALL MOUNTED DUPLEX MOUNT AT 18" A.F.F. U.O.N.
- WALL MOUNTED DUPLEX FOR GARBAGE DISPOSAL
- WALL MOUNTED DUPLEX FOR DISHWASHER, WASHER, AND DRYER
- WALL MOUNTED QUADPLEX MOUNT AT 18" A.F.F. U.O.N.
  - WALL MOUNTED TELEPHONE/DATA RECEPTACLE, MOUNT AT 18" A.F.F.
  - WALL MOUNTED J-BOX FOR RESTROOM WALL SCONCE
- UNDERCABINET LIGHTING, SEE LIGHT FIXTURE SCHEDULE

IDENTIFICATION STAMP DIV. OF THE STATE ARCHITECT APP: 03-122151 INC: REVIEWED FOR SS 🗹 FLS 🗹 ACS 🗹 DATE: 11/02/2022

# abode communities architecture

PROJECT:

#### LAEP EARLY CHILDHOOD CENTER

13928 KORNBLUM AVE. HAWTHORNE, CA 90250

CLIENT:

#### **Los Angeles Education Partnership** 1541 Wilshire Blvd., Suite 200 Los Angeles, CA 90017

ARCHITECT:

T: 213.622.5237

**Abode Communities** 1149 S. Hill Street, Suite 700 Los Angeles, CA 90015 T: 213.629.2702

CONSULTANTS:

**Breen Engineering** 1983 W. 190th St., Suite 200 Torrance, CA 90504 T: 310.464.8404

MECHANICAL/ ELECTRICAL/ PLUMBING **Breen Engineering** 1983 W. 190th St., Suite 200 Torrance, CA 90504 T: 310.464.8404


**STRUCTURAL Breen Engineering** 1983 W. 190th St., Suite 200 Torrance, CA 90504 T: 310.464.8404

#### NOTES

- 1. VERIFY ALL RECEPTACLE LOCATIONS WITH ARCHITECT AND CLIENT PRIOR TO FINAL INSTALLATION.
- 2. FURNITURE IS BY CLIENT UNDER SEPARATE CONTRACT AND IS NOT IN SCOPE. THEY ARE DEPICTED FOR PLANNING AND PLACEMENT OF FIXTURES AND RELATED SCOPE ITEMS ONLY.

#### DSA APPLICATION NUMBER: 03-122151


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DSA BACK-CHECK SET	10.05.22	
DSA BACK-CHECK SET	10.24.22	
DSA BACK-CHECK SET	11.01.22	

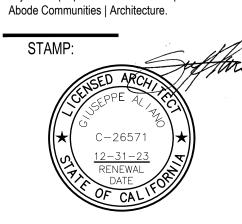SHEET NAME: **BUNGALOW 02 POWER** AND COMMUNICATIONS PLAN

SHEET NUMBER:



BUNGALOW 03 POWER AND COMMUNICATIONS PLAN

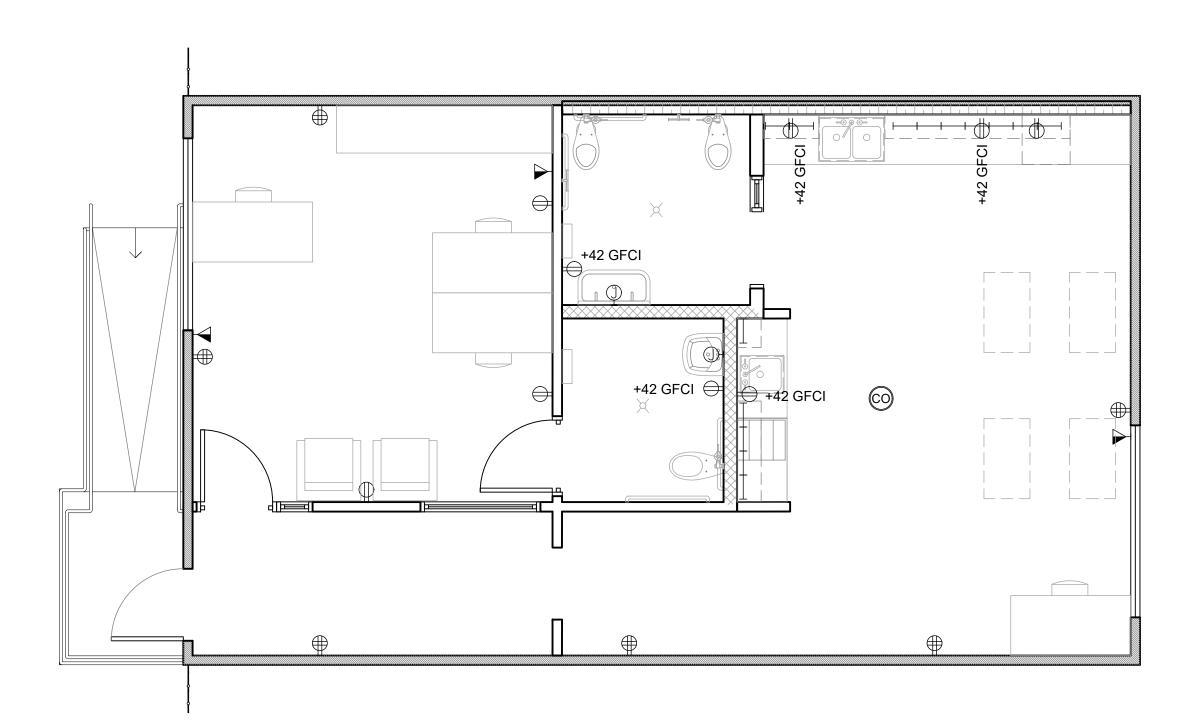SCALE: 1/4" = 1'-0"





#### LEGEND

WALL MOUNTED DUPLEX MOUNT AT 18" A.F.F. U.O.N.

WALL MOUNTED DUPLEX FOR GARBAGE DISPOSAL

WALL MOUNTED DUPLEX FOR DISHWASHER, WASHER, AND DRYER

WALL MOUNTED QUADPLEX MOUNT AT 18" A.F.F. U.O.N.

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WALL MOUNTED J-BOX FOR RESTROOM WALL SCONCE

UNDERCABINET LIGHTING, SEE LIGHT FIXTURE SCHEDULE

IDENTIFICATION STAMP DIV. OF THE STATE ARCHITECT APP: 03-122151 INC: REVIEWED FOR SS 🗹 FLS 🗹 ACS 🗹 DATE: 11/02/2022

# abode communities architecture

PROJECT:

#### LAEP EARLY CHILDHOOD CENTER

13928 KORNBLUM AVE. HAWTHORNE, CA 90250

CLIENT:

Los Angeles Education Partnership 1541 Wilshire Blvd., Suite 200 Los Angeles, CA 90017

ARCHITECT:

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MECHANICAL/ ELECTRICAL/ PLUMBING **Breen Engineering** 1983 W. 190th St., Suite 200 Torrance, CA 90504 T: 310.464.8404


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#### NOTES

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#### DSA APPLICATION NUMBER: 03-122151


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DSA BACK-CHECK SET	10.24.22	
DSA BACK-CHECK SET	11.01.22	

SHEET NAME: BUNGALOW 03 POWER AND COMMUNICATIONS PLAN

SHEET NUMBER:

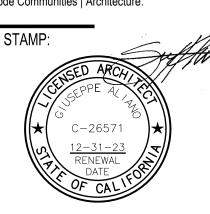

BUNGALOW 04 POWER AND COMMUNICATIONS PLAN

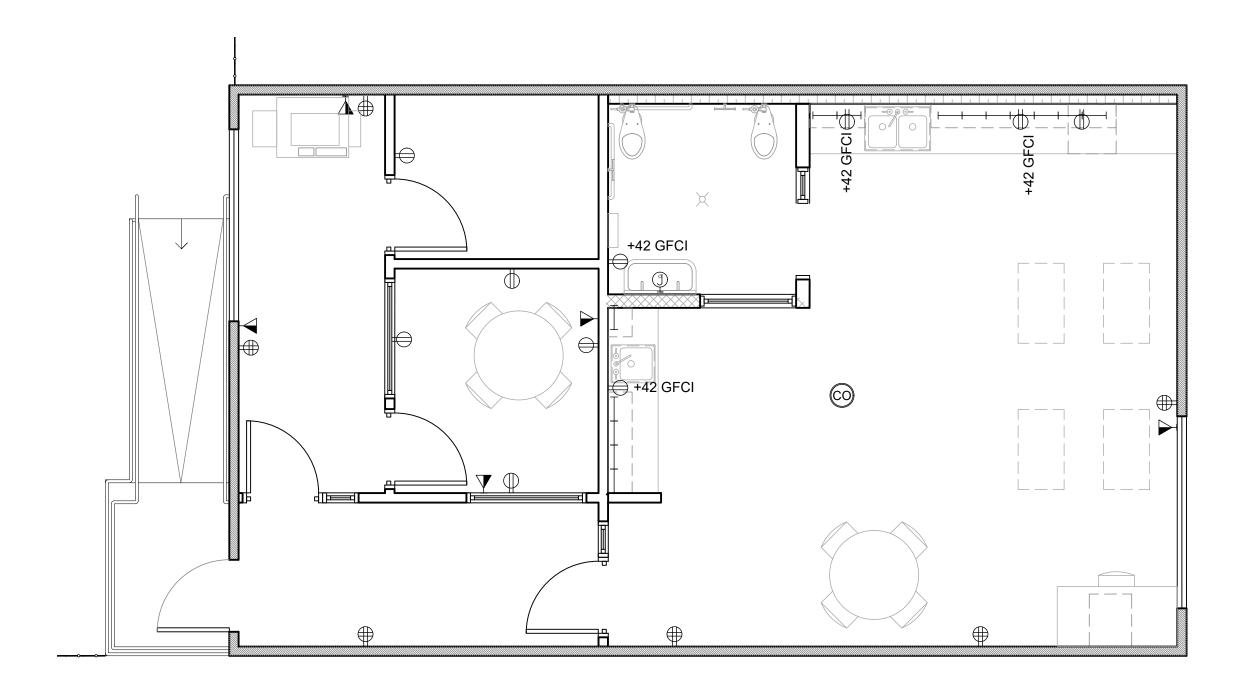SCALE: 1/4" = 1'-0"





#### LEGEND

- WALL MOUNTED DUPLEX MOUNT AT 18" A.F.F. U.O.N.
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- WALL MOUNTED DUPLEX FOR DISHWASHER, WASHER, AND DRYER
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# abode communities architecture

PROJECT:

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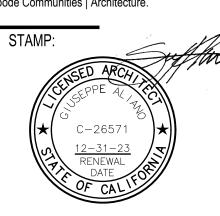
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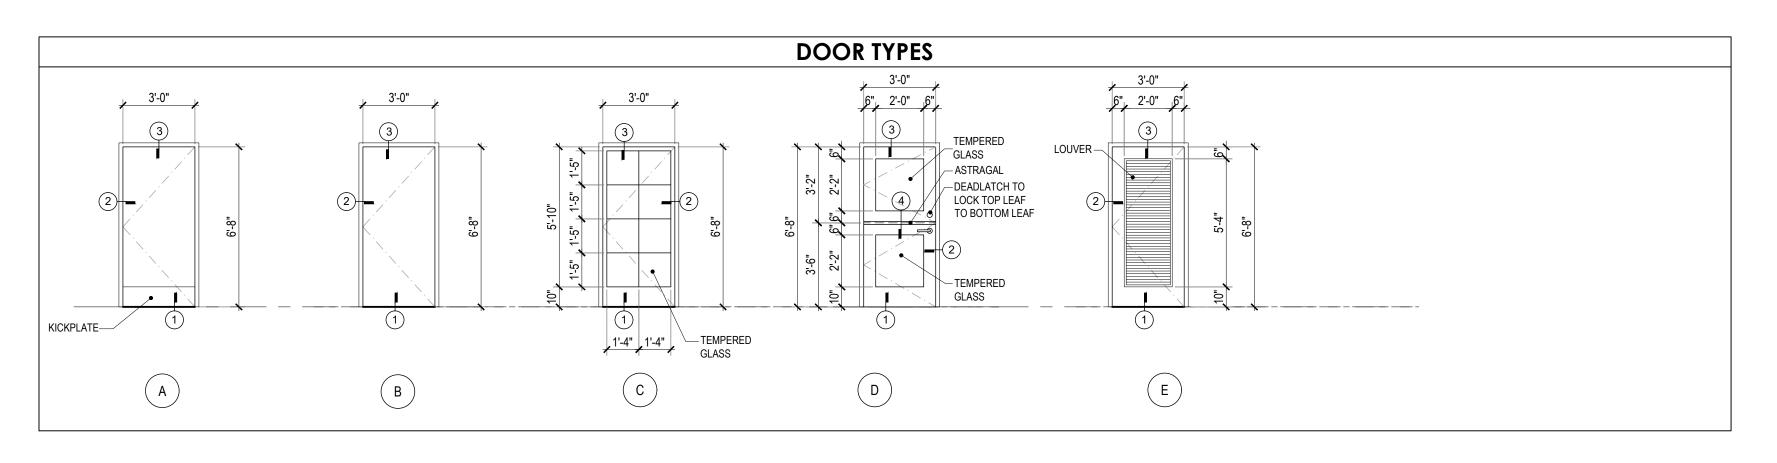
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REV


SHEET NAME: **BUNGALOW 04 POWER** AND COMMUNICATIONS PLAN

SHEET NUMBER:



								D	OOR SCI	HEDULE							
						DOOR			FRAME								
ΛARK	TYPE	ROOM		SIZE				FIRE				FIRE	RE DETAIL		HARDWARE NO.	REMARKS	
			WD	HGT	THK	CORE	MATERIAL	RATING	MFG.	MODEL	MATERIAL	RATING	HEAD	JAMB	SILL	NO.	
01	А	ENTRY	3'-0"	6'-8"	1-3/4"	SOLID CORE	FIBERGLASS	-	EXISTING		METAL	EQUAL TO DOOR	3/A9.01	2/A9.01	1/A9.01	1	EXISTING, PROVIDE KICK PLATE, NO THUMB-TURN LOCKS PERMITTED
02	Е	LAUNDRY	3'-0"	6'-8"	1-3/4"	SOLID CORE	LAMINATED WOOD	-	T.M. COBB OR EQ		METAL	EQUAL TO DOOR	3/A9.01	2/A9.01	-	4	NEW, PROVIDE KICK PLATE, NO THUMB-TURN LOCKS PERMITTED
03	С	KITCHEN	3'-0"	6'-8"	1-3/4"	SOLID CORE	LAMINATED WOOD	-	T.M. COBB OR EQ		METAL	EQUAL TO DOOR	3/A9.01	2/A9.01	-	2	NEW, PROVIDE KICK PLATE, NO THUMB-TURN LOCKS PERMITTED
04	А	ENTRY	3'-0"	6'-8"	1-3/4"	SOLID CORE	FIBERGLASS	-	EXISTING		METAL	EQUAL TO DOOR	3/A9.01	2/A9.01	1/A9.01	1	EXISTING, PROVIDE KICK PLATE, NO THUMB-TURN LOCKS PERMITTED
05	С	WORK AREA	3'-0"	6'-8"	1-3/4"	SOLID CORE	LAMINATED WOOD	-	T.M. COBB OR EQ		METAL	EQUAL TO DOOR	3/A9.01	2/A9.01	-	2	NEW, PROVIDE KICK PLATE, NO THUMB-TURN LOCKS PERMITTED
06	А	ENTRY	3'-0"	6'-8"	1-3/4"	SOLID CORE	FIBERGLASS	-	EXISTING		METAL	EQUAL TO DOOR	3/A9.01	2/A9.01	1/A9.01	1	EXISTING, PROVIDE KICK PLATE, NO THUMB-TURN LOCKS PERMITTED
07	С	OFFICE	3'-0"	6'-8"	1-3/4"	SOLID CORE	LAMINATED WOOD	-	T.M. COBB OR EQ.		METAL	EQUAL TO DOOR	3/A9.01	2/A9.01	-	2	NEW, PROVIDE KICK PLATE, NO THUMB-TURN LOCKS PERMITTED
08	В	ADULT RESTROOM	3'-0"	6'-8"	1-3/4"	SOLID CORE	LAMINATED WOOD	-	T.M. COBB OR EQ		METAL	EQUAL TO DOOR	3/A9.01	2/A9.01	-	2	NEW, PROVIDE KICK PLATE, NO THUMB-TURN LOCKS PERMITTED
09	А	ENTRY	3'-0"	6'-8"	1-3/4"	SOLID CORE	FIBERGLASS	-	EXISTING		METAL	EQUAL TO DOOR	3/A9.01	2/A9.01	1/A9.01	1	EXISTING, PROVIDE KICK PLATE, NO THUMB-TURN LOCKS PERMITTED
10	С	OFFICE	3'-0"	6'-8"	1-3/4"	SOLID CORE	LAMINATED WOOD	-	T.M. COBB OR EQ.		METAL	EQUAL TO DOOR	3/A9.01	2/A9.01	-	2	NEW, PROVIDE KICK PLATE, NO THUMB-TURN LOCKS PERMITTED
11	В	CONFERENCE ROOM	3'-0"	6'-8"	1-3/4"	SOLID CORE	LAMINATED WOOD	-	T.M. COBB OR EQ		METAL	EQUAL TO DOOR	3/A9.01	2/A9.01	-	2	NEW, PROVIDE KICK PLATE, NO THUMB-TURN LOCKS PERMITTED
12	В	FILE ROOM	3'-0"	6'-8"	1-3/4"	SOLID CORE	LAMINATED WOOD	-	T.M. COBB OR EQ		METAL	EQUAL TO DOOR	3/A9.01	2/A9.01	-	4	NEW, PROVIDE KICK PLATE, NO THUMB-TURN LOCKS PERMITTED
13	D	CLASSROOM	3'-0"	6'-8"	1-3/4"	SOLID CORE	LAMINATED WOOD	-	T.M. COBB OR EQ.		METAL	EQUAL TO DOOR	3/A9.01	2/A9.01	-	3	NEW, PROVIDE KICK PLATE, NO THUMB-TURN LOCKS PERMITTED


				DOC	OR HA	RDWA	RE SCHE	DULE		
NO	TVDE	CLOSER	SMOKE	KICK DOO	DOOR	DOOR TURESHOLD	DOODSWEED	FIN	ISH	ADDITIONAL ITEMS / COMMENTS
NO	ТҮРЕ	CLOSER	SEAL	PLATE	STOP	THRESHOLD	DOORSWEEP	OUTSIDE	INSIDE	
				REFER	TO DOOR H	ARDWARE SPEC	CIFICATION SECTION	ON 087100		
1	EXTERIOR	•	•	•		•	•	CHROME	CHROME	COORDINATE W/ SECURITY SYSTEM BY OWNE
2	PRIVACY LOCK	•		•	•			CHROME	CHROME	COORDINATE W/ SECURITY SYSTEM BY OWNE
3	CLASSROOM LOCK	•		•	•			CHROME	CHROME	COORDINATE W/ SECURITY SYSTEM BY OWNE
4	STOREROOM LOCK				•			CHROME	CHROME	COORDINATE W/ SECURITY SYSTEM BY OWNE
5	EXTERIOR GATE			•						COORDINATE W/ SECURITY SYSTEM BY OWNE
6	EXTERIOR GATE									COORDINATE W/ SECURITY SYSTEM BY OWNE

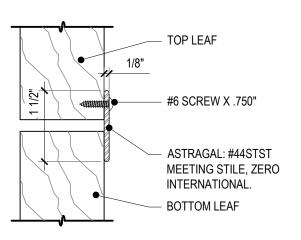



DUTCH DOOR DETAIL


6" = 1'-0"


4

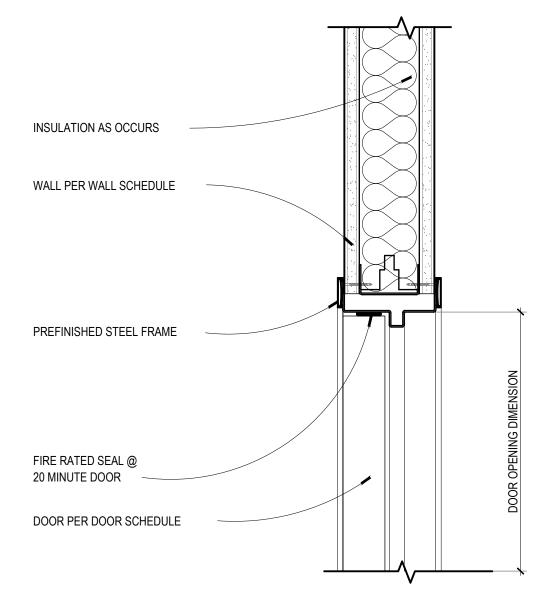

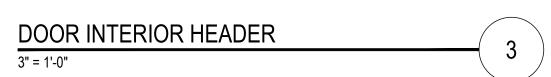

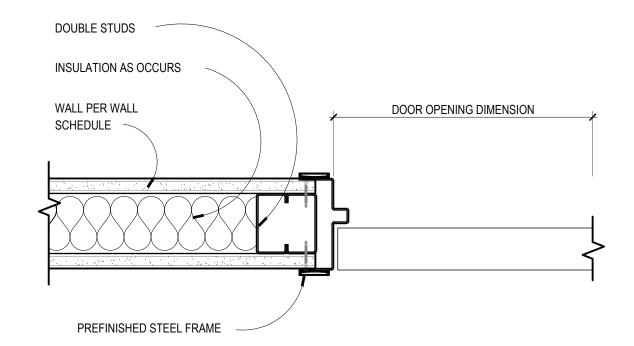

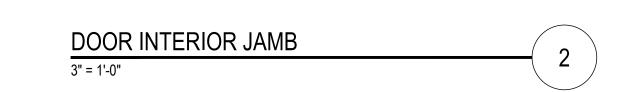

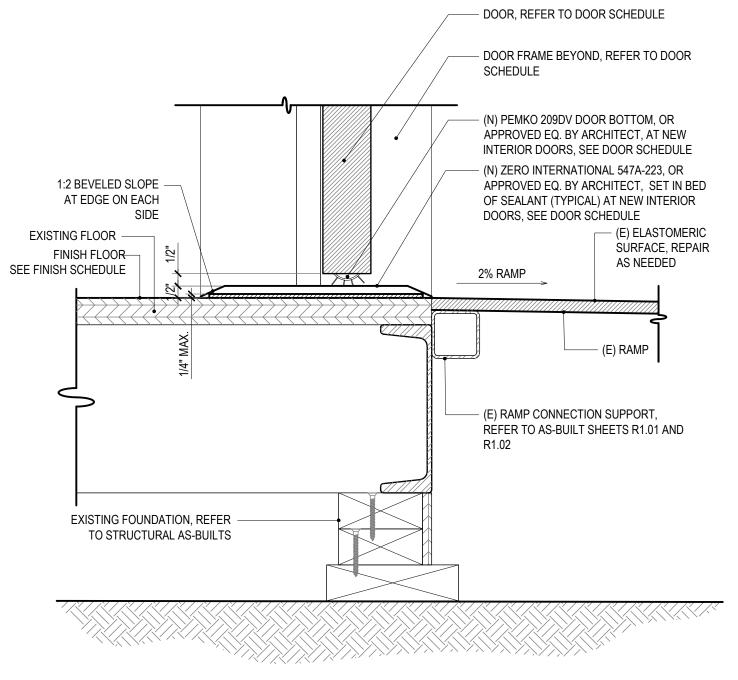

DOOR THRESHOLD DETAIL, TYP.

3" = 1'-0"

#### DOOR NOTES:

- 1. MAXIMUM EFFORT TO OPERATE DOORS SHALL NOT EXCEED 5 LBS (5LBS FOR B & E3 OCCUPANCIES) FOR EXTERIOR DOORS AND 5 LBS FOR INTERIOR DOORS, SUCH PULL OR PUSH EFFORT BEING APPLIED AT RIGHT ANGLES TO HINGED DOORS AND AT THE CENTER PLANE OF SLIDING OR FOLDING DOORS. WHEN FIRE DOORS ARE REQUIRED MAXIMUM EFFORT TO OPERATE DOOR MAY BE INCREASED TO MINIMUM ALLOWABLE BY THE APPROPRIATE AUTHORITY, NOT EXCEED 15 LBS.
- PROVIDE CLOSER AT RESTROOM DOORS. DOOR CLOSERS SHALL BE ADJUSTED SO THAT FROM AN OPEN POSITION OF 90 DEGREES, THE TIME REQUIRED TO MOVE THE DOOR TO A POSITION OF 12 DEGREES FROM THE LATCH IS 5 SECONDS MINIMUM.
- 3. DOOR CLOSERS AND DOOR STOPS ARE PERMITTED TO BE 78" MIN ABOVE THE FINISH FLOOR OR GROUND.
- 4. THE BOTTOM 10" FROM FINISH FLOOR OF ALL DOORS SHALL HAVE A SMOOTH, UNINTERRUPTED SURFACE TO ALLOW THE DOOR TO BE OPENED BY A WHEELCHAIR FOOTREST WITHOUT CREATING A TRAP OR HAZARDOUS CONDITION. PROVIDE AT ALL EXISTING INTERIOR DOORS.
- 5. EGRESS DOORS SHALL BE READILY OPENABLE FROM THE EGRESS SIDE WITHOUT THE USE OF A KEY OR SPECIAL KNOWLEDGE OR EFFORT.
- 6. THERE SHALL BE A FLOOR OR LANDING ON EACH SIDE OF A DOOR. SUCH FLOOR OR LANDING SHALL BE AT THE SAME ELEVATION ON EACH SIDE OF THE DOOR. LANDINGS SHALL BE LEVEL EXCEPT FOR EXTERIOR LANDINGS, WHICH ARE PERMITTED TO HAVE A SLOPE NOT TO EXCEED 0.25 UNIT VERTICAL IN 12 UNITS HORIZONTAL (2-PERCENT SLOPE). (CBC 1010.1.5)
- 7. THRESHOLDS AT DOORWAYS SHALL NOT EXCEED 1/2 INCH (12.7 MM) ABOVE THE FINISHED FLOOR OR LANDING FOR OTHER DOORS. RAISED THRESHOLDS AND FLOOR LEVEL CHANGES GREATER THAN 1/4 INCH (6.4 MM) AT DOORWAYS SHALL BE BEVELED WITH A SLOPE NOT GREATER THAN ONE UNIT VERTICAL IN TWO UNITS HORIZONTAL (50-PERCENT SLOPE). (CBC 11B-404.2.5)
- 8. DOOR HANDLES, PULLS, LATCHES, LOCKS AND OTHER OPERATING DEVICES ON DOORS REQUIRED TO BE ACCESSIBLE BY CHAPTER 11B SHALL NOT REQUIRE TIGHT GRASPING, TIGHT PINCHING OR TWISTING OF THE WRIST TO OPERATE. (CBC 11B-309.4)
- 9. HANDLES, PULLS, LATCHES, LOCKS, AND OTHER OPERABLE PARTS ON DOORS AND GATES SHALL COMPLY WITH SECTION 11B-309.4. OPERABLE PARTS OF SUCH HARDWARE SHALL BE 34 INCHES (864 MM) MINIMUM AND 44 INCHES (1118 MM) MAXIMUM ABOVE THE FINISH FLOOR OR GROUND. WHERE SLIDING DOORS ARE IN THE FULLY OPEN POSITION, OPERATING HARDWARE SHALL BE EXPOSED AND USABLE FROM BOTH SIDES. (CBC 11B-404.2.7)
- 10. NO THUMB TURN LOCKS PERMITTED
- 11. THE LOCKING DEVICE IS READILY DISTINGUISHABLE AS LOCKED.
- 12. A READILY VISIBLE DURABLE SIGN IS POSTED ON THE EGRESS SIDE ON OR ADJACENT TO THE DOOR STATING: THIS DOOR TO REMAIN UNLOCKED WHEN THIS SPACE IS OCCUPIED. THE SIGN SHALL BE IN LETTERS 1 INCH (25 MM) HIGH ON A CONTRASTING BACKGROUND.
- 13. THE USE OF THE KEY-OPERATED LOCKING DEVICE IS REVOKABLE BY THE FIRE CODE OFFICIAL FOR DUE CAUSE.

#### HARDWARE NOTES:

- . ALL ENTRY DOOR HARDWARE IS AND SHALL BE SINGLE ACTION. NO DOUBLE-KEYED DEADBOLTS PERMITTED.
- ALL HINGES SHALL MATCH THE FINISH OF THE EXTERIOR HARDWARE FINISH. ALL OVERHEAD DOOR CLOSERS SHALL MATCH THE INTERIOR HARDWARE FINISH.

IDENTIFICATION STAMP DIV. OF THE STATE ARCHITECT

APP: 03-122151 INC:

REVIEWED FOR

SS FLS ACS DATE: 11/02/2022

# abode communities architecture

PROJECT:

## LAEP EARLY CHILDHOOD CENTER

13928 KORNBLUM AVE. HAWTHORNE, CA 90250

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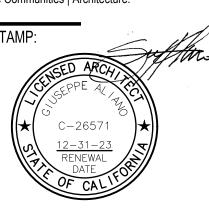
MECHANICAL/ ELECTRICAL/ PLUMBING Breen Engineering 1983 W. 190th St., Suite 200 Torrance, CA 90504 T: 310.464.8404

STRUCTURAL

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#### DSA APPLICATION NUMBER: 03-122151

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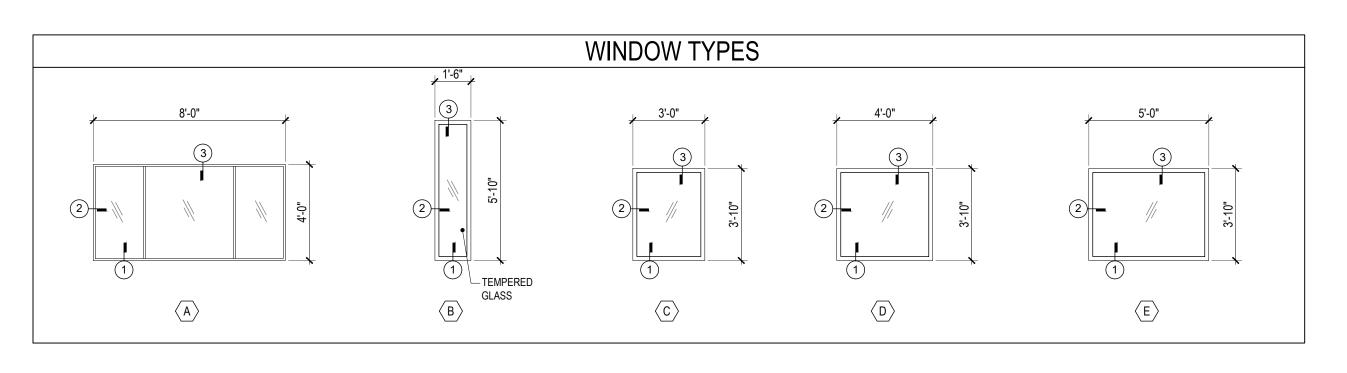


	DATE	REV
PROGRESS SET	02.01.22	
DSA PROGRESS SET	03.02.22	
DSA APPLICATION SET	04.01.22	
DSA BACK-CHECK SET	10.05.22	
DSA BACK-CHECK SET	10.24.22	
DSA BACK-CHECK SET	11.01.22	


SHEET NAME:

DOOR SCHEDULE

SHEET NUMBER:



								WI	NDO\	N SCH	IEDULE	•					
				WINDOW	!					<b></b>				FRAME			
MARK	TYPE	S	ZE	CLEAR EGRESS	STYLE	MFG.	MODEL		GLA	ZING		- MAT'L	FINISH		DETAIL		REMARKS
		WD	HGT	DIMENSION	STILL	WII G.	WODEL	TYPE	U-VALUE	SHGC	VT	IVIATE	TINIOTT	HEAD	JAMB	SILL	
1	Α	8'-0"	4'-0"	N/A	FIXED	EXISTING	-	DUAL LOW-E	.37 (MIN.)	.23 (MIN.)	.49 (MIN.)	VINYL	WHITE	-	-	-	-
2	Α	8'-0"	4'-0"	N/A	FIXED	EXISTING	-	DUAL LOW-E	.37 (MIN.)	.23 (MIN.)	.49 (MIN.)	VINYL	WHITE	-	-	-	-
3	В	1'-6"	5'-10"	N/A	FIXED	T.M. COBB OR EQ.	-	DUAL LOW-E	.37 (MIN.)	.23 (MIN.)	.49 (MIN.)	VINYL	WHITE	3/A9.02	2/A9.02	1/A9.02	-
4	В	1'-6"	5'-10"	N/A	FIXED	T.M. COBB OR EQ.	-	DUAL LOW-E	.37 (MIN.)	.23 (MIN.)	.49 (MIN.)	VINYL	WHITE	3/A9.02	2/A9.02	1/A9.02	-
5	С	3'-0"	3'-10"	N/A	FIXED	T.M. COBB OR EQ.	-	DUAL LOW-E	.37 (MIN.)	.23 (MN.)	.49 (MN.)	VINYL	WHITE	3/A9.02	2/A9.02	1/A9.02	
6	Α	8'-0"	4'-0"	N/A	FIXED	EXISTING	-	DUAL LOW-E	.37 (MIN.)	.23 (MN.)	.49 (MN.)	VINYL	WHITE	-	-	-	-
7	Α	8'-0"	4'-0"	N/A	FIXED	EXISTING	-	DUAL LOW-E	.37 (MIN.)	.23 (MN.)	.49 (MN.)	VINYL	WHITE	-	-	-	-
8	В	1'-6"	5'-10"	N/A	FIXED	T.M. COBB OR EQ.	-	DUAL LOW-E	.37 (MIN.)	.23 (MN.)	.49 (MN.)	VINYL	WHITE	3/A9.02	2/A9.02	1/A9.02	-
9	В	1'-6"	5'-10"	N/A	FIXED	T.M. COBB OR EQ.	-	DUAL LOW-E	.37 (MIN.)	.23 (MN.)	.49 (MN.)	VINYL	WHITE	3/A9.02	2/A9.02	1/A9.02	-
10	С	3'-0"	3'-10"	N/A	FIXED	T.M. COBB OR EQ.	-	DUAL LOW-E	.37 (MIN.)	.23 (MN.)	.49 (MN.)	VINYL	WHITE	3/A9.02	2/A9.02	1/A9.02	-
11	D	4'-0"	3'-10"	N/A	FIXED	T.M. COBB OR EQ.	-	DUAL LOW-E	.37 (MIN.)	.23 (MN.)	.49 (MN.)	VINYL	WHITE	3/A9.02	2/A9.02	1/A9.02	-
12	А	8'-0"	4'-0"	N/A	FIXED	EXISTING	-	DUAL LOW-E	.37 (MIN.)	.23 (MN.)	.49 (MN.)	VINYL	WHITE	-	-	-	-
13	Α	8'-0"	4'-0"	N/A	FIXED	EXISTING	-	DUAL LOW-E	.37 (MIN.)	.23 (MN.)	.49 (MN.)	VINYL	WHITE	-	-	-	-
14	В	1'-6"	5'-10"	N/A	FIXED	T.M. COBB OR EQ.	-	DUAL LOW-E	.37 (MIN.)	.23 (MN.)	.49 (MN.)	VINYL	WHITE	3/A9.02	2/A9.02	1/A9.02	-
15	В	1'-6"	5'-10"	N/A	FIXED	T.M. COBB OR EQ.	-	DUAL LOW-E	.37 (MIN.)	.23 (MN.)	.49 (MN.)	VINYL	WHITE	3/A9.02	2/A9.02	1/A9.02	-
16	E	5'-0"	3'-10"	N/A	FIXED	T.M. COBB OR EQ.	-	DUAL LOW-E	.37 (MIN.)	.23 (MN.)	.49 (MN.)	VINYL	WHITE	3/A9.02	2/A9.02	1/A9.02	-
17	Α	8'-0"	4'-0"	N/A	FIXED	EXISTING	-	DUAL LOW-E	.37 (MIN.)	.23 (MN.)	.49 (MN.)	VINYL	WHITE	-	-	-	-
18	А	8'-0"	4'-0"	N/A	FIXED	EXISTING	-	DUAL LOW-E	.37 (MIN.)	.23 (MN.)	.49 (MN.)	VINYL	WHITE	-	-	-	-
19	В	1'-6"	5'-10"	N/A	FIXED	T.M. COBB OR EQ.	-	DUAL LOW-E	.37 (MIN.)	.23 (MN.)	.49 (MN.)	VINYL	WHITE	3/A9.02	2/A9.02	1/A9.02	-
20	В	1'-6"	5'-10"	N/A	FIXED	T.M. COBB OR EQ.	-	DUAL LOW-E	.37 (MIN.)	.23 (MN.)	.49 (MN.)	VINYL	WHITE	3/A9.02	2/A9.02	1/A9.02	-
21	Е	5'-0"	3'-10"	N/A	FIXED	T.M. COBB OR EQ.	-	DUAL LOW-E	.37 (MIN.)	.23 (MN.)	.49 (MN.)	VINYL	WHITE	3/A9.02	2/A9.02	1/A9.02	-
22	В	1'-6"	5'-10"	N/A	FIXED	T.M. COBB OR EQ.	-	DUAL LOW-E	.37 (MIN.)	.23 (MN.)	.49 (MN.)	VINYL	WHITE	3/A9.02	2/A9.02	1/A9.02	-
23	D	4'-0"	3'-10"	N/A	FIXED	T.M. COBB OR EQ.	-	DUAL LOW-E	.37 (MIN.)	.23 (MN.)	.49 (MN.)	VINYL	WHITE	3/A9.02	2/A9.02	1/A9.02	-
24	E	5'-0"	3'-10"	N/A	FIXED	T.M. COBB OR EQ.	-	DUAL LOW-E	.37 (MIN.)	.23 (MN.)	.49 (MN.)	VINYL	WHITE	3/A9.02	2/A9.02	1/A9.02	-

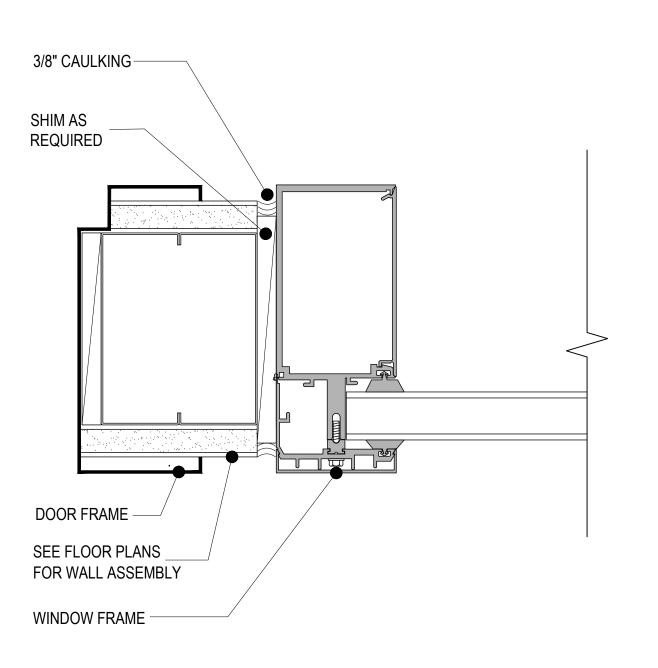

WINDOW / DOOR FRAMING DETAIL 6" = 1'-0"

#### **WINDOW NOTES:**

SEE FLOOR PLANS FOR

WALL ASSEMBLY

- SHIM AS REQUIRED

ALUMINUM FRAMED

WINDOW SYSTEM

- 3/8" CAULKING

WINDOW INTERIOR HEADER

3/8" CAULKING -

SHIM AS REQUIRED

SEE FLOOR PLANS FOR

6" = 1'-0"

WALL ASSEMBLY

3/8" CAULKING

"J" TRIM

6" = 1'-0"

- HEADER, S.S.D.

- EGRESS (ESCAPE OR RESCUE) WINDOWS SHALL HAVE A MIN. NET CLEAR OPERABLE AREA OF 5.7 SQ. FT. THE MIN. NET CLEAR OPERABLE HEIGHT DIMENSION SHALL BE 24 IN. THE MINIMUM NET CLEAR OPERABLE WIDTH SHALL BE 20 IN. WHEN WINDOWS ARE PROVIDED AS A MEANS OF ESCAPE OR RESCUE, THEY SHALL HAVE A FINISHED SILL HEIGHT NOT MORE THAN 44 IN. ABOVE THE FLOOR (CBC 310.4).
- ALL WINDOW AND EXTERIOR DOOR LABELS SHALL REMAIN IN PLACE UNTIL FINAL BUILDING INSPECTION, AND FINAL ARCHITECTURAL PUNCH LIST INSPECTION.
- CONTRACTOR SHALL VERIFY WITH MANUFACTURER, BEFORE INSTALLATION, THAT EGRESS WINDOWS SATISFY EGRESS REQUIREMENTS.

IDENTIFICATION STAMP DIV. OF THE STATE ARCHITECT APP: 03-122151 INC: REVIEWED FOR SS 🗹 FLS 🗹 ACS 🗹 DATE: 11/02/2022

## abode communities architecture

#### LAEP EARLY CHILDHOOD CENTER

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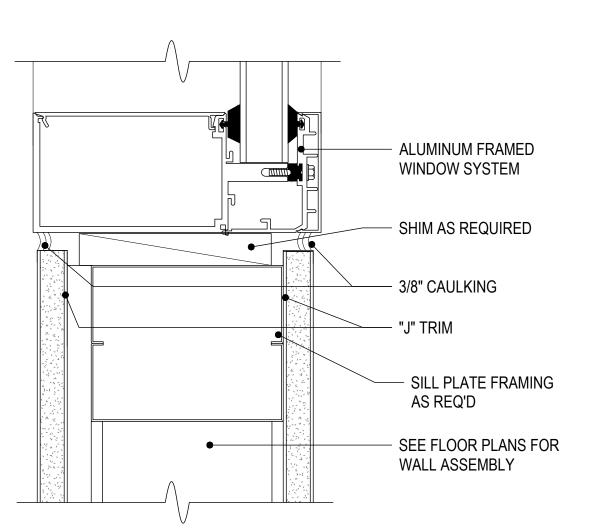
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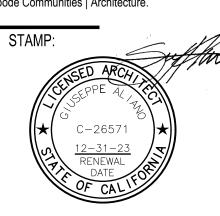
# WINDOW INTERIOR JAMB



WINDOW INTERIOR SILL 6" = 1'-0"

#### DSA APPLICATION NUMBER: 03-122151

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	DATE	REV
PROGRESS SET	02.01.22	
DSA PROGRESS SET	03.02.22	
DSA APPLICATION SET	04.01.22	
DSA BACK-CHECK SET	10.05.22	
DSA BACK-CHECK SET	10.24.22	
DSA BACK-CHECK SET	11.01.22	

SHEET NAME: WINDOW SCHEDULE

SHEET NUMBER:

A9.02

APPLIANC	CE SCHEDULE				
ISSUED: 08/08/2	2022				Abode Communities Architecture
ITEM	FIXTURE	IMAGE	PRODUCT NAME	FINISH/ COLOR	NOTES
COMMON	AREA APPLIANCES				
AP-C01	COOKTOP (INDUCTION)		SUMMIT INDUCTION STOVE SINC2B120	BLACK	AT BREAKROOM KITCHEN
AP-C02	OVEN		FRIGIDARE OVERN FFEW3026T D / S / W / B	STAINLESS STEEL	AT BREAKROOM KITCHEN
AP-C03	RANGEHOOD		AIRKING ESADA 30" WITH WALL SWITCH	STAINLESS STEEL	AT BREAKROOM KITCHEN
AP-C04	REFRIGERATOR (FREE STANDING)		MOTAK MSD-2DR-BAL-54-X	STAINLESS STEEL	AT BREAKROOM KITCHEN
AP-C05	REFRIGERATOR (UNDERCOUNTER)		SUMMIT AL54	STAINLESS STEEL	AT EACH CLASSROOM, IN CONFERENCE ROOM
AP-C06	STERILIZER	E ZONO Travel to and	ZONO SC2 WH	STAINLESS STEEL	AT KITCHEN AREA
AP-C07	WASHER		GE WASHER GFW550SSN/SPN	WHITE	AT LAUNDRY
AP-C08	ELECTRIC DRYER		GE DRYER GFD55ES\$N/ESPN	WHITE	AT LAUNDRY
AP-C09	DISHWASHER		GE DISHWASHER GDT225SSLSS	STAINLESS STEEL	AT KITCHEN

ISSUED: 0808/20	022				Abode Communities Architect
ITEM	FIXTURE	IMAGE	PRODUCT NAME	FINISH/ COLOR	NOTES
COMMON	AREA RESTROOM A	ACCESSORIES			
PL-C01	SINGLE BASIN SINK		JUST SINGLE BOWL 1821-A	STAINLESS STEEL	AT CLASSROOM CHANGING AREA, REAR DRAIN
PL-C02	DOUBLE BASIN SINK		JUST DOUBLE BOWL UD-ADA-1632	STAINLESS STEEL	AT CLASSROOM FOOD PREP AREA, REAR DRAIL
PL-C03	KITCHEN SINK		JUST SINGLE BOWL 1830-a	STAINLESS STEEL	REAR DRAIN WITH GARBAGE DISPOSAL
PL-C04	TROUGH SINK		KOHLER BROCKWAY UTILITY SINK K-3200	WHITE	PAIRED WITH TRITON, PROVIDE BOOT FOR P-TRAP
AP-C05	WALL HUNG SINK	Shown with 0059,020EC shroud	AMERICAN STANDARD MURRO UNIVERSAL DESIGN WALL-HUNG LAVATORY WITH EVERCLEAN 0958.008EC WITH SHROUD 0059.020EC	WHITE	AT RESTROOM
PL-C06	COUNTER FAUCET		DELTA TRINSIC KITCHEN FAUCET 9159-DST	CHROME	AT CLASSROOM SINKS

ISSUED: 08/08/2	2022				Abode Communities Architecture
ITEM	FIXTURE	IMAGE	PRODUCT NAME	FINISH/ COLOR	NOTES
COMMON	AREA RESTROOM	ACCESSORIES			
AC-01	MIRROR		BOBRICK B-294	STAINLESS STEEL	AT EACH SINK
AC-C02	TOILET PAPER DISPENSER (SURFACE)		BOBRICK B-9547	SATIN	AT ALL RESTROOMS
AC-C03	TOILET PAPER DISPENSER (RECESSED)		BOBRICK B-3888	SATIN	NOT USED
AC-C04	SOAP DISPENSER (SURFACE)	TC	BOBRICK B-8263	SATIN	at each classroom sink, hardwire
AC-05	PAPER TOWEL WASTE AND DISPENSER		BOBRICK 3961	SATIN	WITH LINERMATE AND TOWELMATE
AC-06	Paper Tower Dispenser (Touchless)	- Control of the cont	GEORGIA PACIFIC ENMOTION	GRAY/WHITE	AT ADULT RESTROOM

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# abode communities architecture

#### LAEP EARLY CHILDHOOD CENTER

13928 KORNBLUM AVE. HAWTHORNE, CA 90250

CLIENT:

#### Los Angeles Education Partnership 1541 Wilshire Blvd., Suite 200 Los Angeles, CA 90017 T: 213.622.5237

ARCHITECT:

**Abode Communities** 1149 S. Hill Street, Suite 700 Los Angeles, CA 90015 T: 213.629.2702

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**STRUCTURAL** Breen Engineering 1983 W. 190th St., Suite 200 Torrance, CA 90504 T: 310.464.8404

#### DSA APPLICATION NUMBER: 03-122151


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	DATE	REV
PROGRESS SET	02.01.22	
DSA PROGRESS SET	03.02.22	
DSA APPLICATION SET	04.01.22	
DSA BACK-CHECK SET	10.05.22	
DSA BACK-CHECK SET	10.24.22	
DSA BACK-CHECK SET	11.01.22	

SHEET NAME: **APPLIANCES &** PLUMBING FIXTURES SCHEDULES

SHEET NUMBER:



	GATE SCHEDULE											
		SI	ZE			PANIC	KNOX	CALL	HARDWARE			
MARK	LOCATION	WD	HGT	MATERIAL	FINISH	HARDWARE	BOX	BOX	NO.	DETAIL	REMARKS	
G01	KORNBLUM ENTRY	3'-0"	8'-0"	GALV. STEEL	HIGH PERFORMANCE COATING	YES	NO	NO	5	-	NEW GATE	
G02	KORNBLUM ENTRY	3'-0"	8'-0"	GALV. STEEL	HIGH PERFORMANCE COATING	NO	NO	NO	6	-	EXISTING DOUBLE GATE TO CHANGE TO SINGLE GATE	
G02	PARKING LOT ENTRY	3'-0"	8'-0"	GALV. STEEL	HIGH PERFORMANCE COATING	YES	NO	NO	5	-	EXISTING GATE	
G03	PERIMETER CORRIDOR	3'-0"	7'-0"	GALV. STEEL	HIGH PERFORMANCE COATING	YES	NO	NO	5	-	EXISTING GATE	
G04	PLAYGROUND	3'-0"	7'-0"	GALV. STEEL	HIGH PERFORMANCE COATING	YES	NO	NO	5	-	EXISTING GATE	

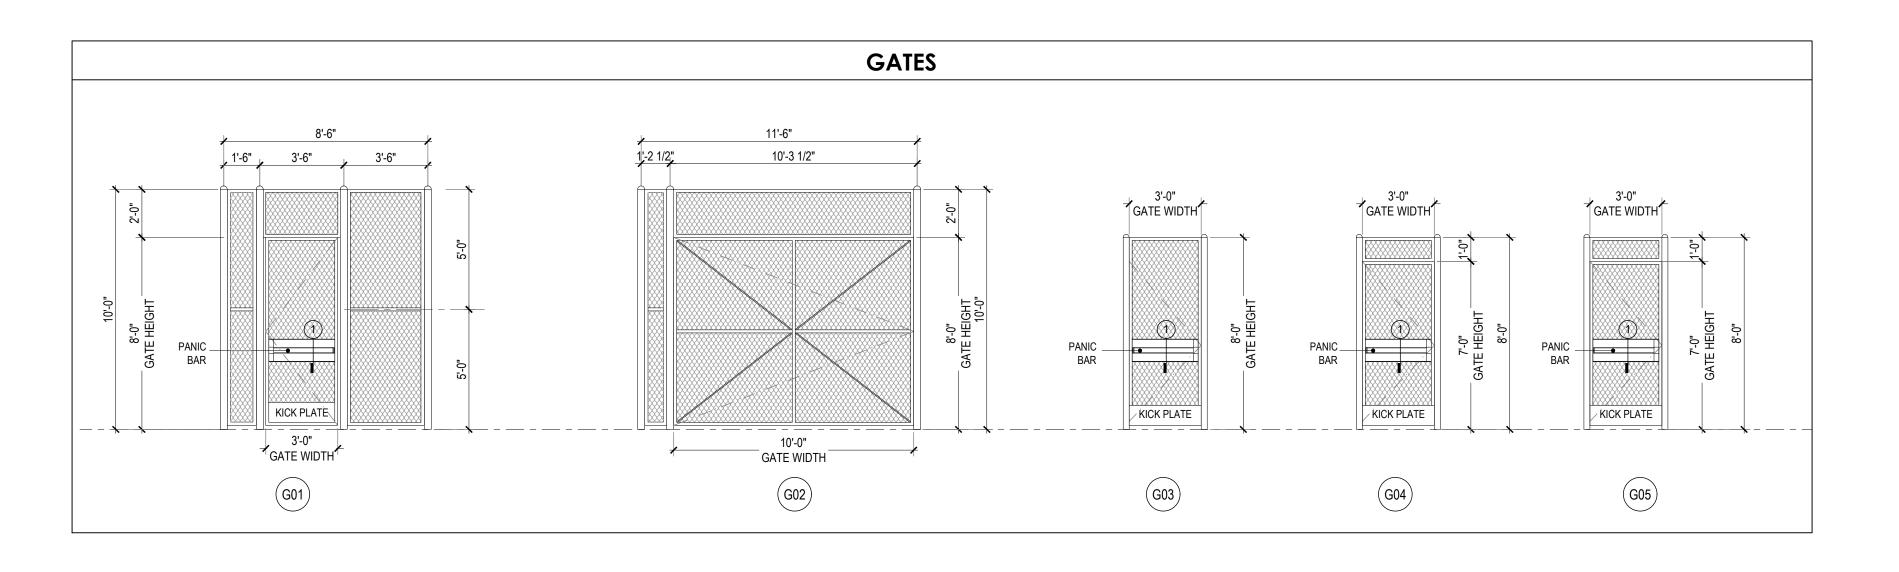	DOOR HARDWARE SCHEDULE											
	FINISH ADDITIONAL ITEMS / COMME											
NO	ТҮРЕ	CLOSER	SEAL	PLATE	STOP	THRESHOLD	DOORSWEEP	OUTSIDE	INSIDE			
	REFER TO DOOR HARDWARE SPECIFICATION SECTION 087100											
1	EXTERIOR	•	•	•		•	•	CHROME	CHROME	COORDINATE W/ SECURITY SYSTEM BY OWNER		
2	PRIVACY LOCK	•		•	•			CHROME	CHROME	COORDINATE W/ SECURITY SYSTEM BY OWNER		
3	CLASSROOM LOCK	•		•	•			CHROME	CHROME	COORDINATE W/ SECURITY SYSTEM BY OWNER		
4	STOREROOM LOCK				•			CHROME	CHROME	COORDINATE W/ SECURITY SYSTEM BY OWNER		
5	EXTERIOR GATE			•						COORDINATE W/ SECURITY SYSTEM BY OWNER		
6	EXTERIOR GATE									COORDINATE W/ SECURITY SYSTEM BY OWNER		

#### GATE NOTES:

- EXIT DOORS SHALL BE OPENABLE FROM THE INSIDE WITHOUT THE USE OF KEYS, SPECIAL KNOWLEDGE OR EFFORT. FLUSH BOLTS OR SURFACE BOLTS ARE PROHIBITED.
- 2. PANIC HARDWARE TO COMPLY WITH REQUIREMENTS OF UBC STANDARD 10-4. THE ACTIVATING MEMBER SHALL BE MOUNTED AT A HEIGHT OF NOT LESS THAN 30" NOR MORE THAN 44" ABOVE THE FLOOR. THE UNLATCHING FORCE SHALL NOT EXCEED 15 POUNDS WHEN APPLIED IN THE DIRECTION OF TRAVEL.
- 3. MAXIMUM EFFORT TO OPERATE DOORS SHALL NOT EXCEED 5
  LBS AS PER ADA 404.2.9 FOR EXTERIOR DOORS AND 5 LBS FOR
  INTERIOR DOORS, SUCH PULL OR PUSH EFFORT BEING APPLIED
  AT RIGHT ANGLES TO HINGED DOORS AND AT THE CENTER
  PLANE OF SLIDING OR FOLDING DOORS. WHEN FIRE DOORS ARE
  REQUIRED MAXIMUM EFFORT TO OPERATE DOOR MAY BE
  INCREASED TO MINIMUM ALLOWABLE BY THE APPROPRIATE
  AUTHORITY, NOT EXCEED 15 LBS.
- 4. THE BOTTOM 10" OF ALL DOORS AND GATES EXCEPT AUTOMATIC AND SLIDING SHALL HAVE A SMOOTH, UNINTERRUPTED SURFACE TO ALLOW THE DOOR TO BE OPENED BY A WHEELCHAIR FOOTREST WITHOUT CREATING A TRAP OR HAZARDOUS CONDITION. WHERE NARROW FRAME DOORS ARE USED, A 10" HIGH SMOOTH PANEL SHALL BE INSTALLED ON THE PUSH SIDE OF THE DOOR. WHICH WILL ALLOW THE DOOR TO BE OPENED BY A WHEELCHAIR FOOTREST WITHOUT CREATING A TRAP OR HAZARDOUS CONDITION. INCLUDE METAL GRATER IN PATH OF TRAVEL.
- 5. ALL SITE METAL FENCES AND GATES ARE DESIGN BUILD BT G. C. INCLUDING STAMPED SHOP DRAWINGS BY PROFESSIONAL ENGINEER BASED ON ARCHITECTURAL ELEVATIONS.

#### HARDWARE NOTES:

- 1. ALL ENTRY DOOR HARDWARE IS AND SHALL BE SINGLE ACTION. NO DOUBLE-KEYED DEADBOLTS PERMITTED.
- 2. ALL HINGES SHALL MATCH THE FINISH OF THE EXTERIOR HARDWARE FINISH.

IDENTIFICATION STAMP DIV. OF THE STATE ARCHITECT

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PROJECT:

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PROGRESS SET 02.01.22

DSA PROGRESS SET 03.02.22

DSA APPLICATION SET 04.01.22

DSA BACK-CHECK SET 10.05.22

DSA BACK-CHECK SET 10.24.22

DSA BACK-CHECK SET 11.01.22

SHEET NAME:

GATE SCHEDULE

SHEET NUMBER:

PANIC HARDWARE PROTECTOR AT GATE
1-1/2" = 1'-0"

GATE SURFACE

- 14 GA. THICK STEEL PLATE,

PLATE (1/2" RADIUS)


PANIC HARDWARE

14 GA. THICK STEEL PLATE,

PLATE (1/2" RADIUS)

POWDERCOAT AND MATCH TO GATE FINISH. ROUND CORNER EDGES OF

POWDERCOAT AND MATCH TO GATE FINISH. ROUND CORNER EDGES OF

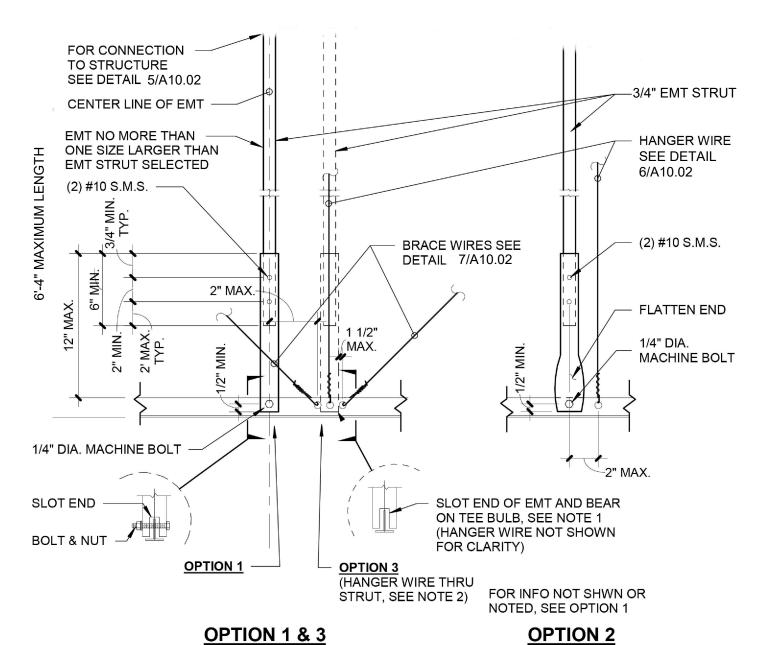

MACHINE BOLT IS NOT REQUIRED ON OPTION 3.

OPTION 3 IS PERMITTED ONLY WHERE THE ROOF OR FLOOR STRUCTURE IS SAWN TIMBER WITHOUT GYPSUM BOARD. STRUT SHALL BE MIN. 6" AWAY FROM ANY UNBRACED DUCTS, PIPES, CONDUITS, ETC.

#### **COMPRESSION STRUT - EMT TYPE**

DSA IR 25-2 APPENDIX A DETAIL 3.20


DSA IR 25-2 APPENDIX A DETAIL 2.60

**CEILING PERIMETER** 

NOT TO SCALE


NOT TO SCALE

MAIN OR CROSS RUNNER -ALTERNATE STABILIZER LOCATION WITHOUT NAIL (SEE NOTE 3) HANGER WIRE, TYP. -8" MAX. (SEE NOTE 1 BELOW) (SEE NOTE 1 BELOW) SEE NOTE 4 CLR. CEILING PANEL 1"x 2" x 25 GA. MIN. CONT. ANGLE: FASTEN TO WALL PER NOTE 4 BELOW 1/4" MIN.-CONT. SLOTTED ANGLE STABILIZER STEEL POP RIVET BAR WITH HORIZ. 6d RINGSHANK NAIL @ 4'-0" O.C. MAX. (SEE NOTE 2). OMIT STRUT WHERE RUNNER IS WITHIN 8" OF WALI 1"x 2" x 25 GA. MIN. 1"X 2" X 25 GA. IVIIIN. CONT. ANGLE THUS: 1" **FREE JOINT** FASTEN TO WALL PER NOTE 4 BELOW **ATTACHED JOINT** PROVIDE #12 GAGE HANGER WIRES AT THE ENDS OF ALL MAIN AND CROSS RUNNERS WITHIN EIGHT (8) INCHES OF THE SUPPORT OR WITHIN ONE-FOURTH (1/4) OF THE LENGTH OF THE END TEE, WHICHEVER CHANNEL IS LESS, FOR THE PERIMETER OF THE CEILING AREA. SECTION AS PERIMETER WIRES ARE NOT REQUIRED WHEN THE STABILIZER LENGTH OF THE END TEE IS EIGHT (8) INCHES OR NAILS AT ENDS OF HORIZONTAL STABILIZERS ARE TO BE PLACED WITH NAIL HEAD TOWARD CENTER LINE OF SPAN OF STRUT. STABILIZER BAR MAY BE SLOTTED APPROVED ANGLES OR CHANNELS WITH "DIAMOND POINTS" OF SPRING STEEL WHICH SNAP TIGHT TO PREVENT 4. FASTEN ANGLE TO WALL STUD OR BLOCKING AS METAL STUD (20 GA. MIN.) WALL: (1) #10 SMS AT 24" O.C. MAX. WOOD STUD WALL: #10x2" LONG WOOD SCREW AT 16" O.C. MAX.

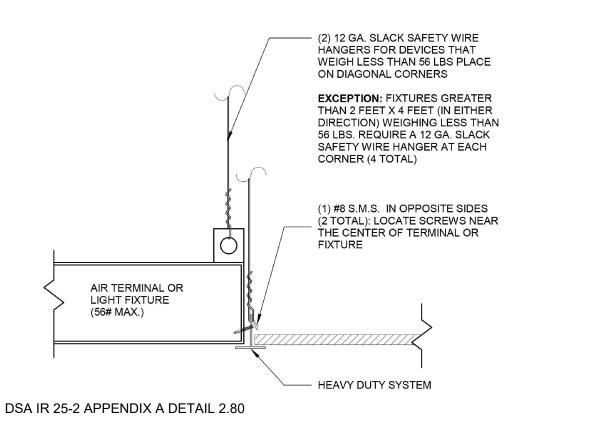

LUMINAIRE / AIR TERMINAL SUPPORT (TYP.)

NOT TO SCALE

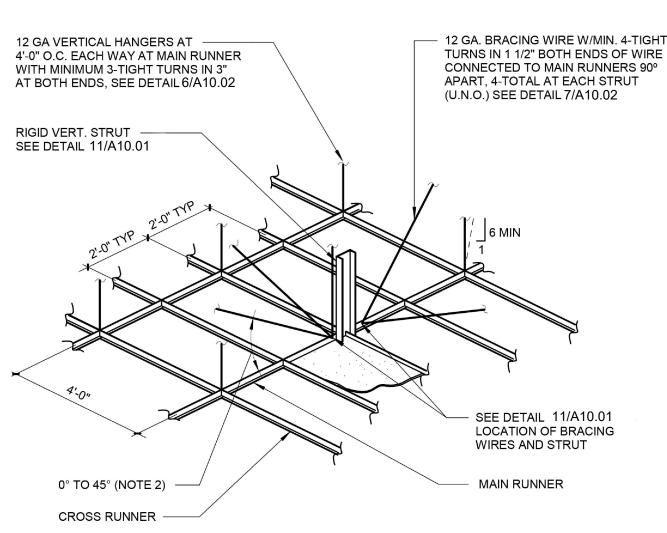

STRUTS SHALL NOT REPLACE HANGER WIRES. THE MINIMUM ACCEPTABLE ANGLE IS DETERMINED SUCH THAT THE WIRES DO NOT INTERFERE WITH THE RUNNERS, LIGHT


UNOBSTRUCTED.

DSA IR 25-2 APPENDIX A DETAIL 2.35 PRODUCT: ARMSTRONG CALLA ACOUSTIC CEILING SYSTEM EVALUATION REPORT NUMBER: ESR-1308 CATALOG NUMBER: 7501 SERIES


FIXTURES, ETC. AND REMAIN STRAIGHT AND

#### SUSPENDED CEILING WITH COMPRESSION STRUT

NOT TO SCALE

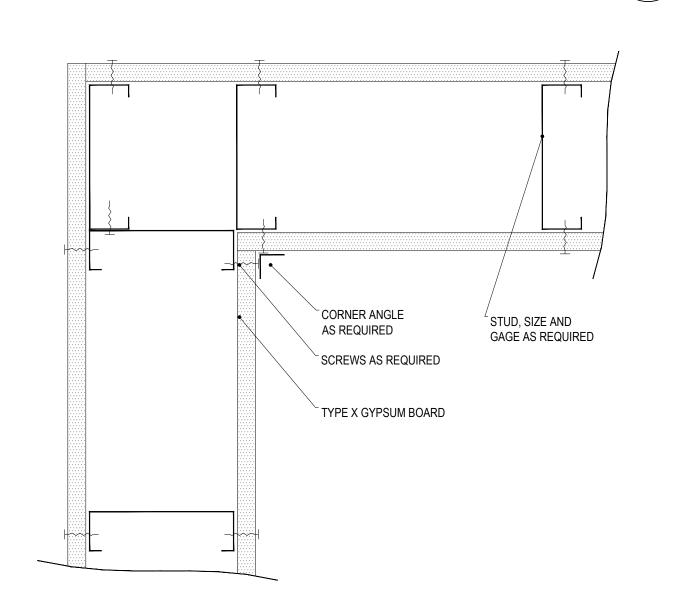


GYPSUM CORNER DETAIL 1-1/2" = 1'-0" REFER TO STRUCTURAL DETAIL 14/S3.10

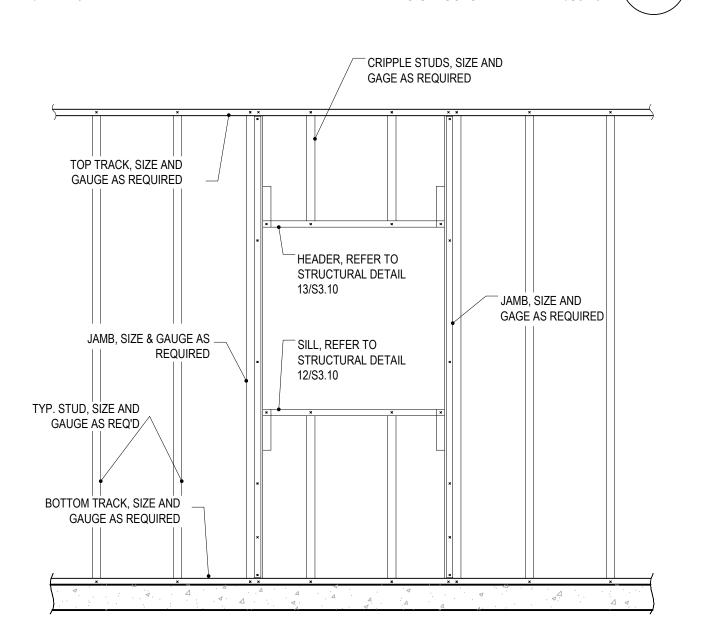


NON LOAD WINDOW OPENING 1-1/2" = 1'-0" REFER TO STRUCTURAL DRAWINGS


3" = 1'-0"

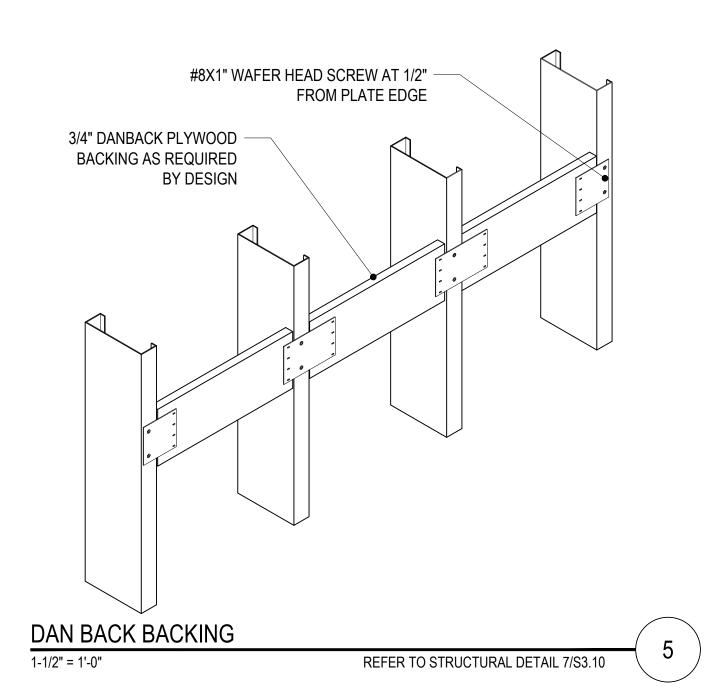


1. 20 GA METAL STUDS WHERE TILE FINISH IS SCHEDULED, REFER TO PLANS AND FINISH SCHEDULE. REFER TO MANUFACTURER SPECS.

2. PROVIDE 1 LAYER OF 1/2" DENSSHIELD® TILE BACKER OR EQUAL WHERE TILE IS SCHEDULED

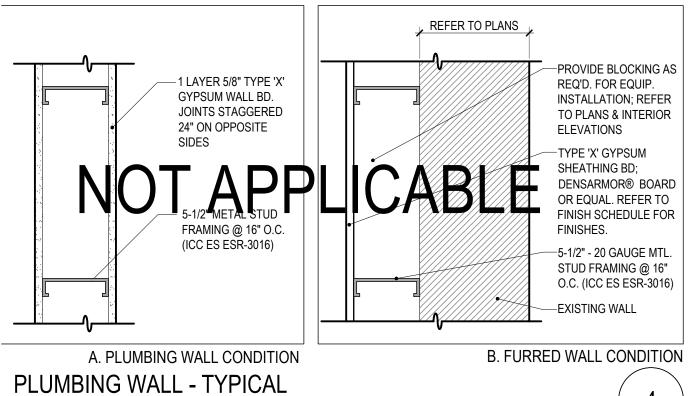

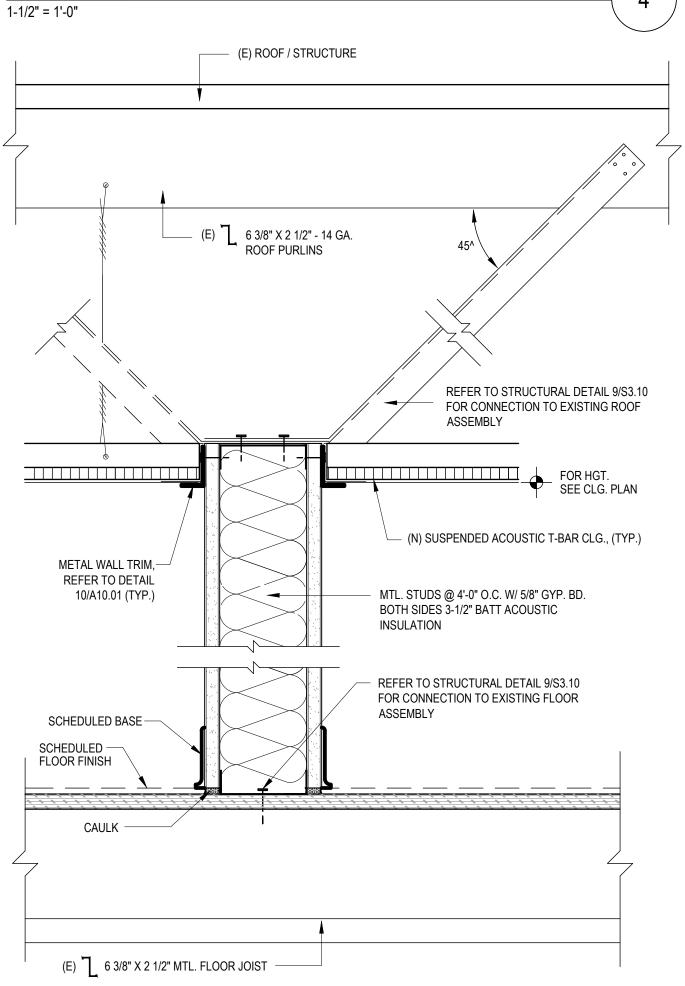


TYP. INTERIOR WALL NON-RATED REFER TO STRUCTURAL DETAIL 9/S3.10

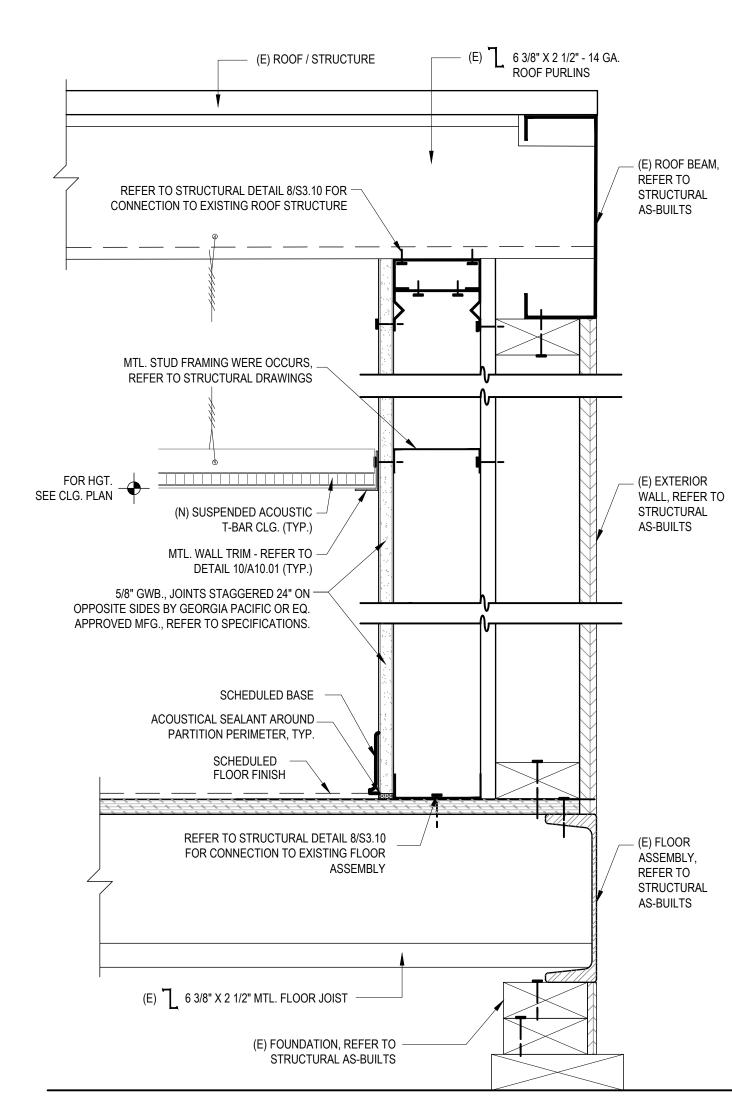



REFER TO STRUCTURAL DETAIL 8/S3.10

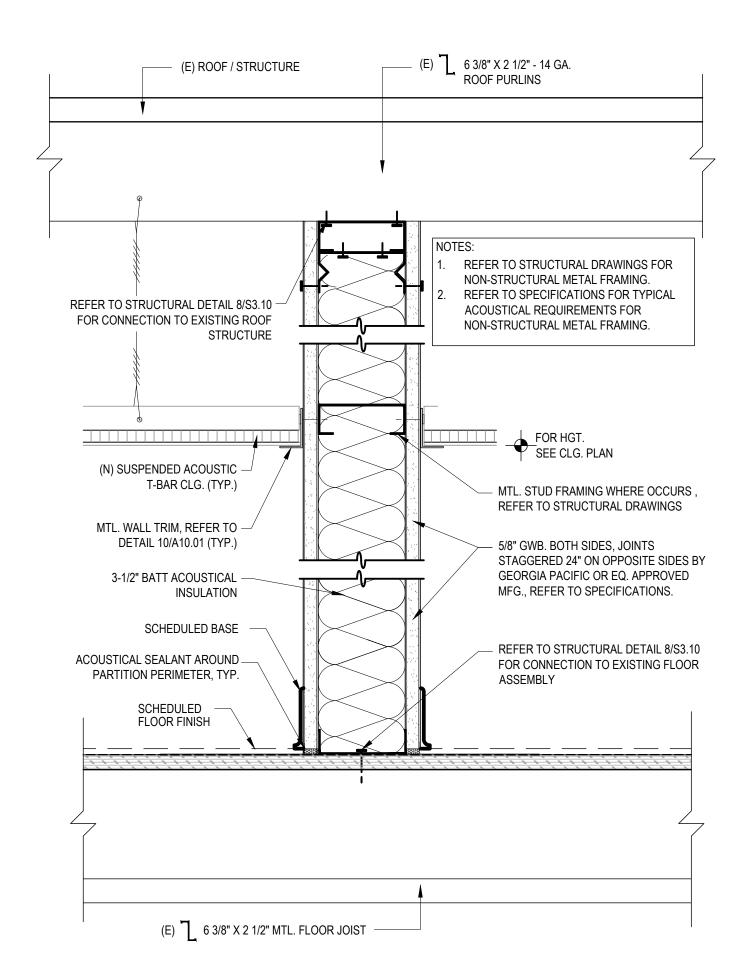

TYP. INTERIOR WALL NON-RATED

3" = 1'-0"

REFER TO STRUCTURAL DETAIL 8/S3.10

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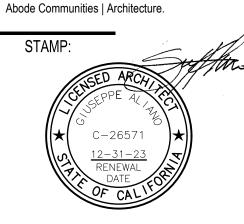
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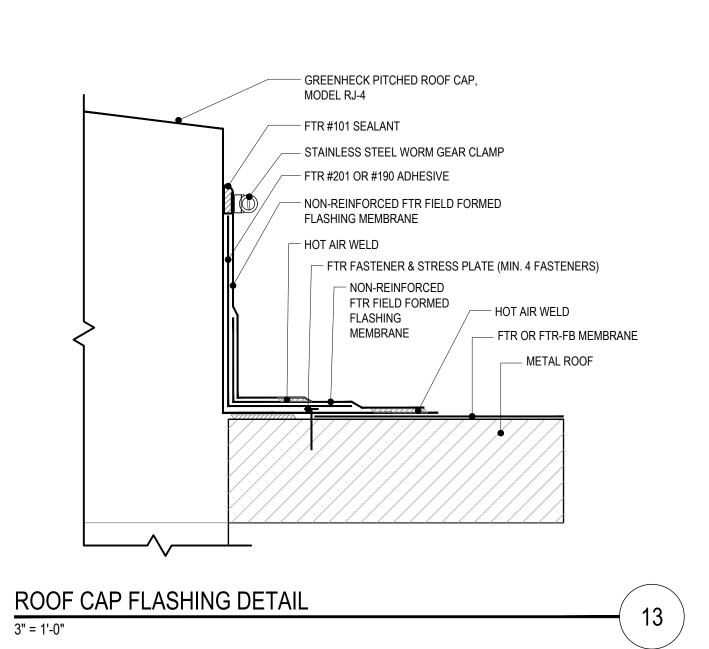
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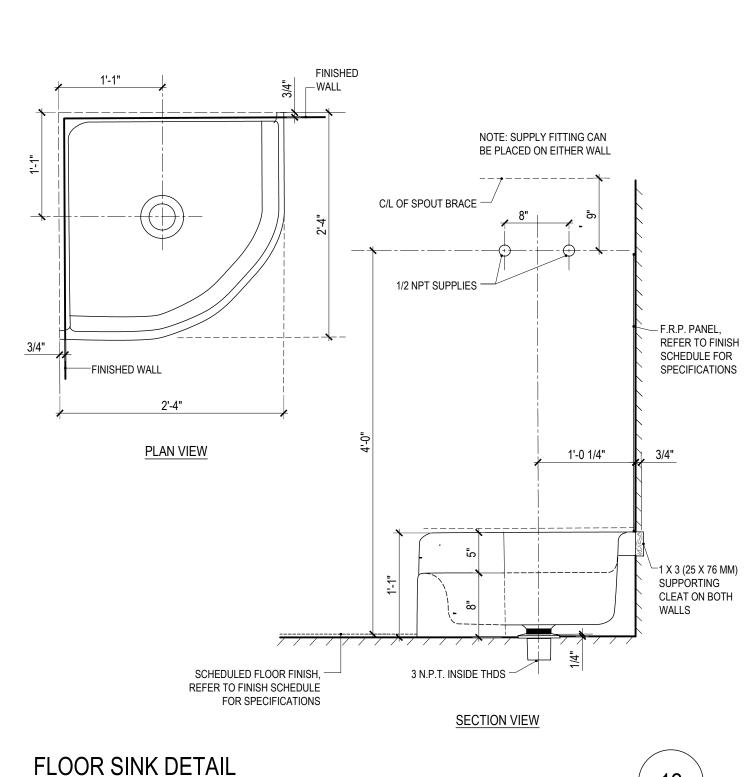



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SHEET NAME:

**DETAILS** 







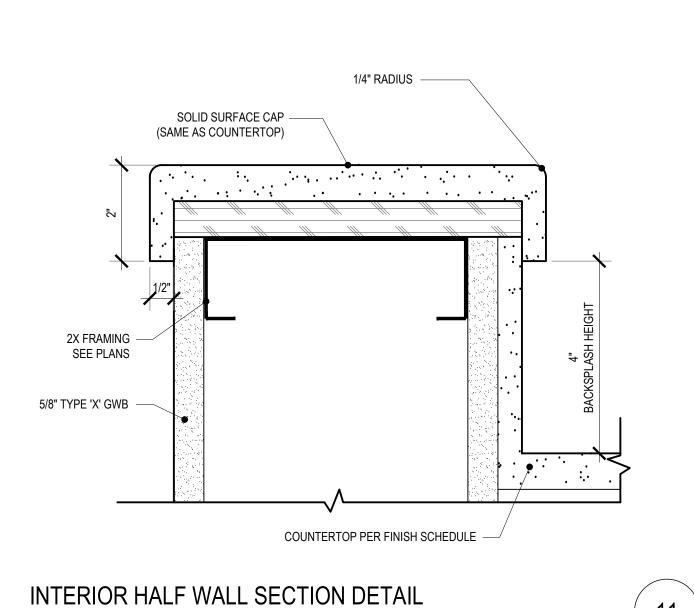


1" = 1'-0"


6" = 1'-0"

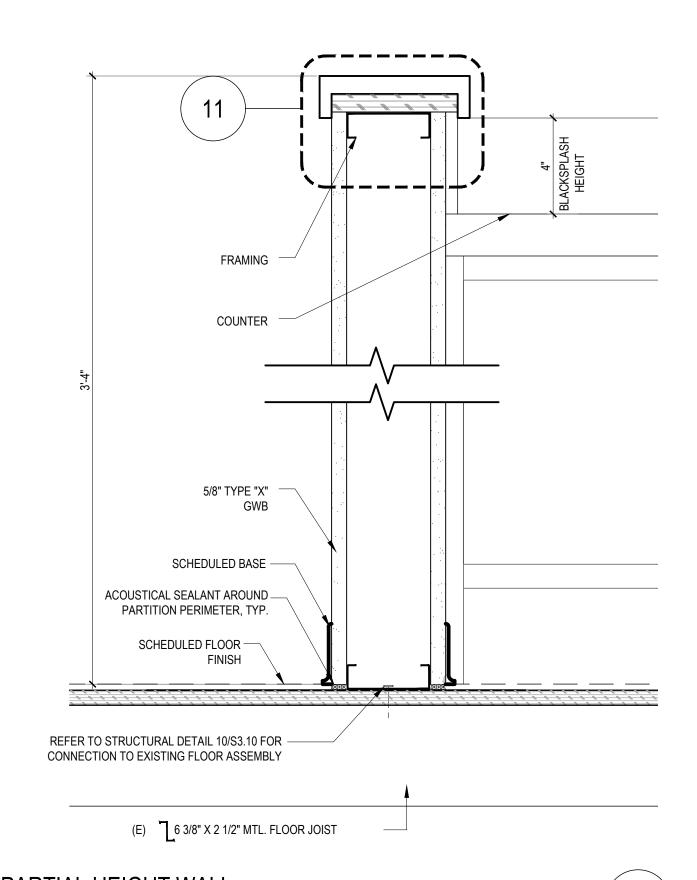

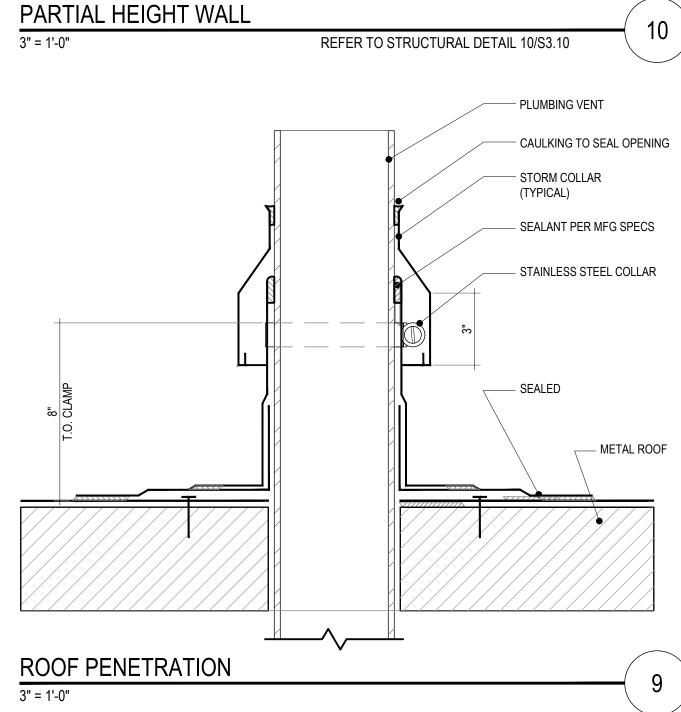

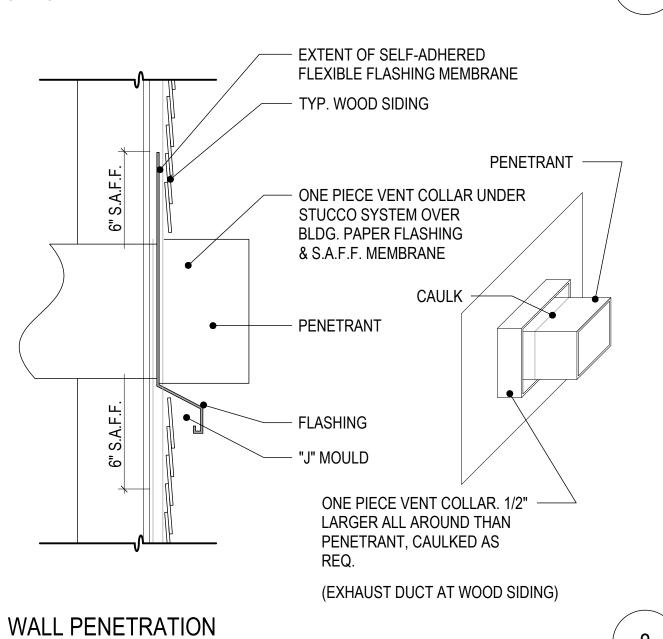


1-1/2" = 1'-0"

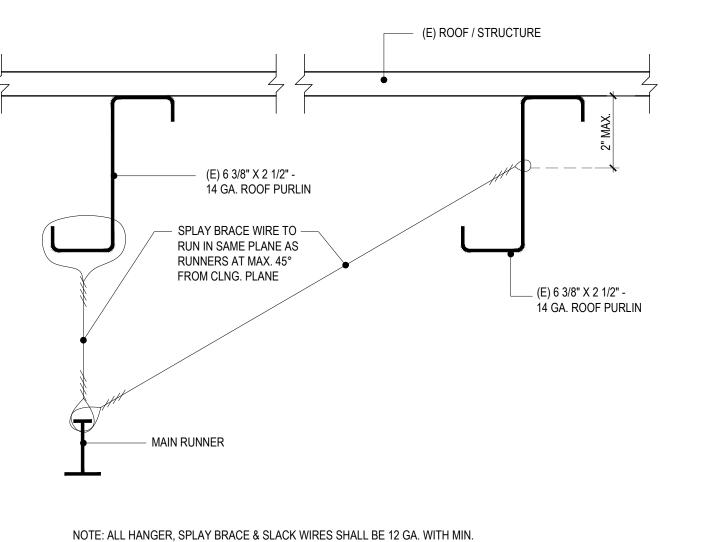


4 TIGHT TURNS WITHIN 1 1/2" MAX. OF EACH END.

#### SPLAY BRACING WIRE CONNECTION TO ROOF STRUCTURE 3" = 1'-0"

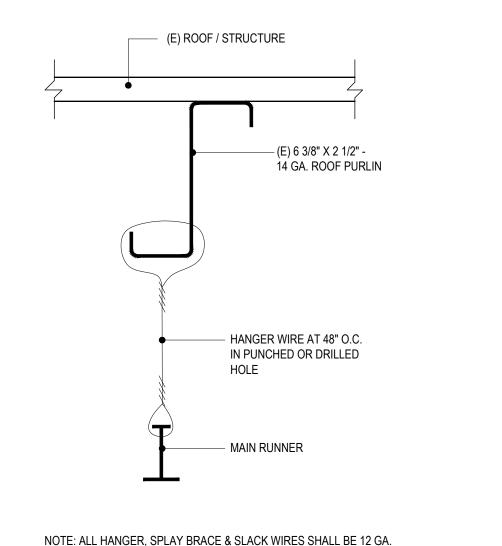


WITH MIN. 4 TIGHT TURNS WITHIN 1 1/2" MAX. OF EACH END.

#### HANGER WIRE CONNECTION TO ROOF STRUCTURE 3" = 1'-0"

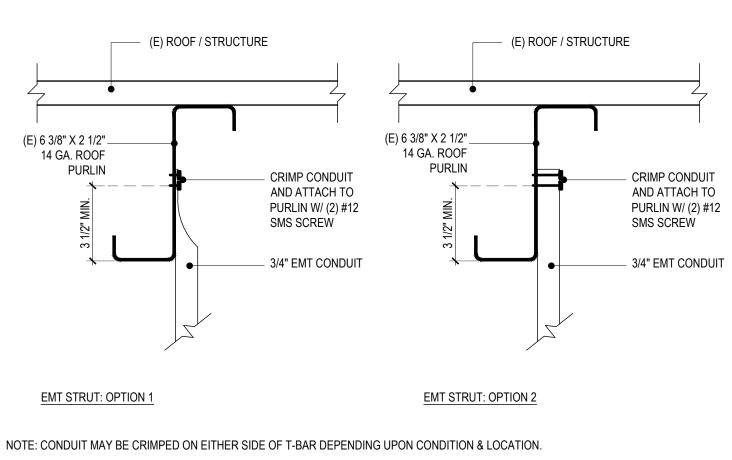


STRUT CONNECTION TO ROOF STRUCTURE 3" = 1'-0"

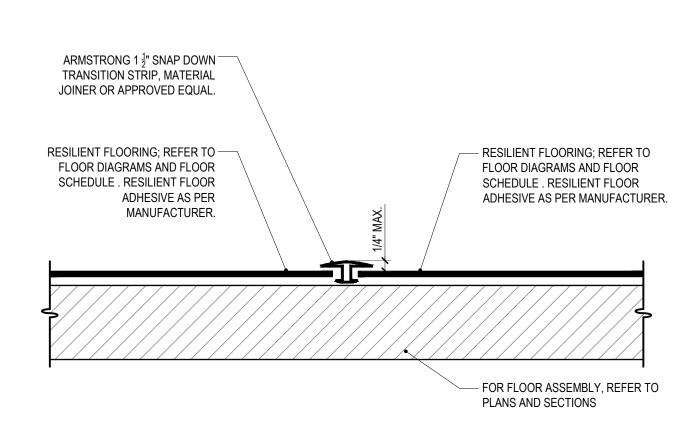


TRANSITION: RESILIENT FLOORINGS

3" = 1'-0"

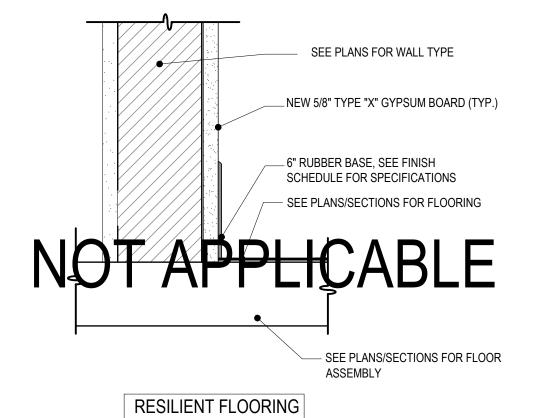


RUBBER BASE DETAIL

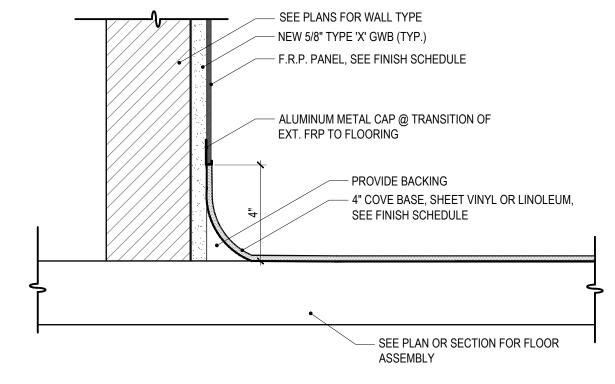

INTEGRAL COVE BASE AT FRP

3" = 1'-0"

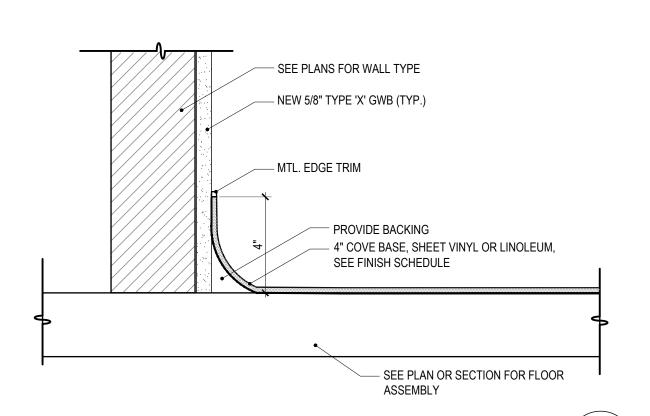

INTEGRAL COVE BASE AT GYP. WALL

3" = 1'-0"

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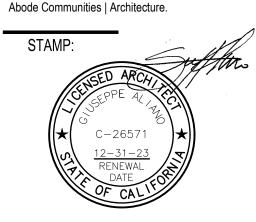
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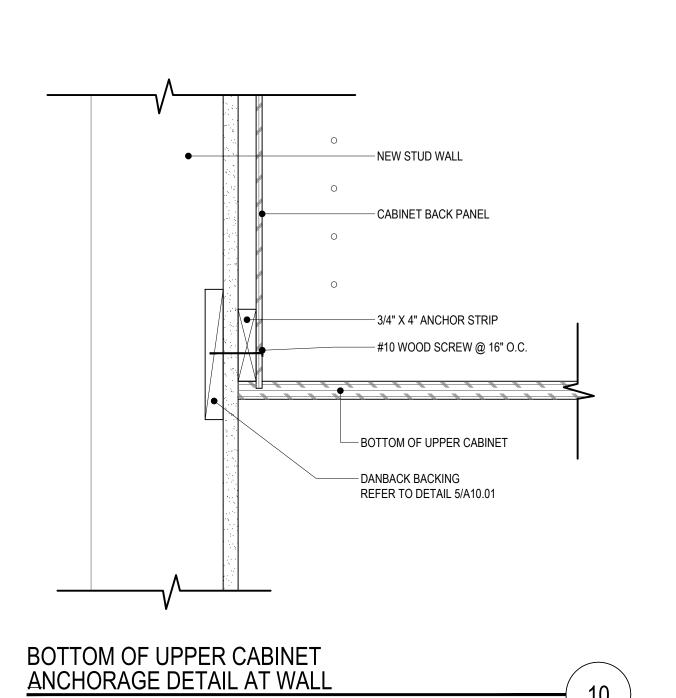
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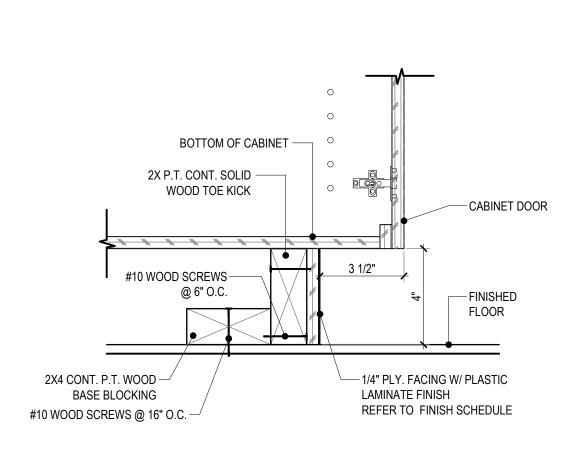


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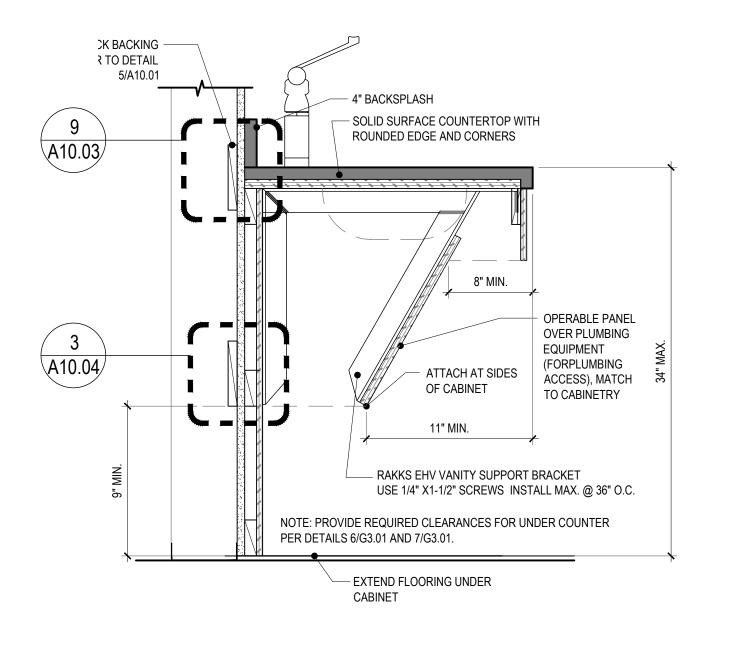
**DETAILS** 







BASE CABINET


ANCHORAGE DETAIL @ FLOOR





OPEN CABINET UNDER KITCHEN SINK

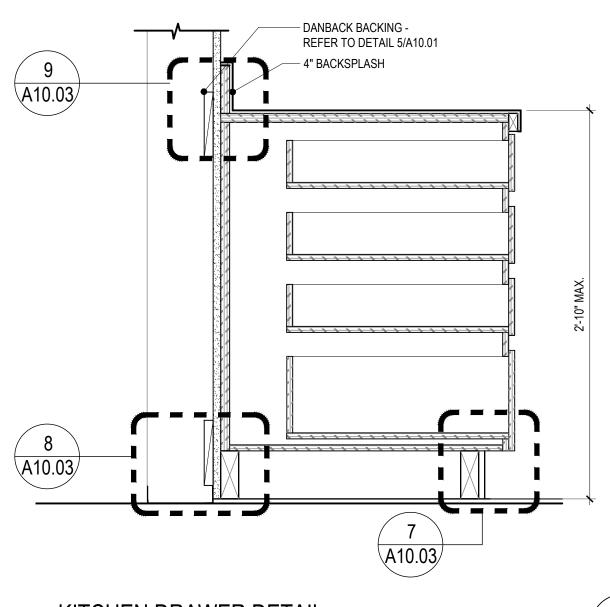


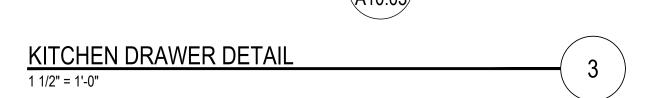


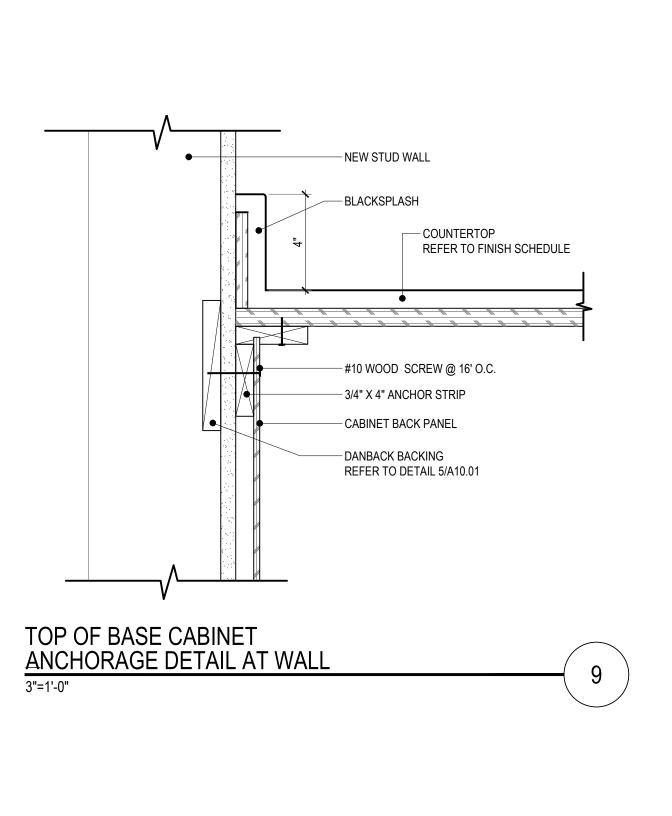

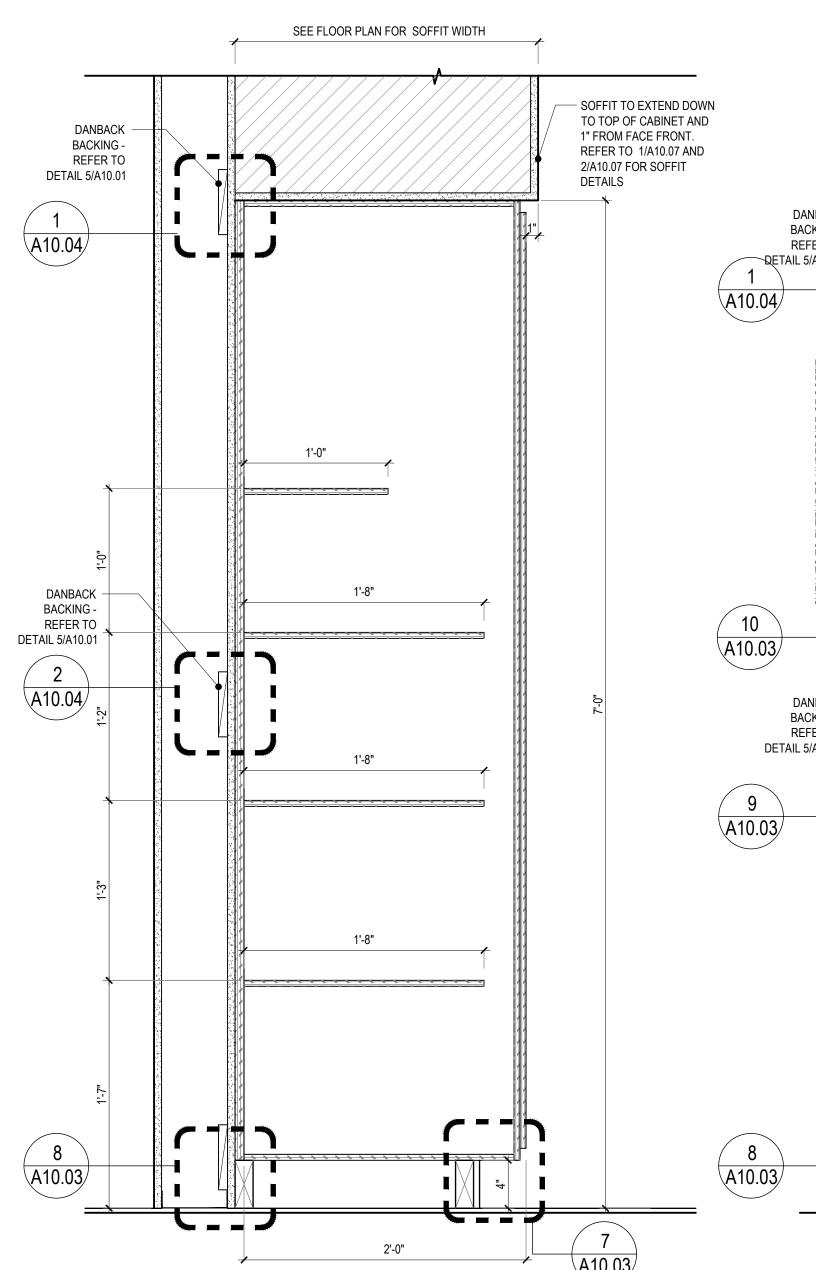


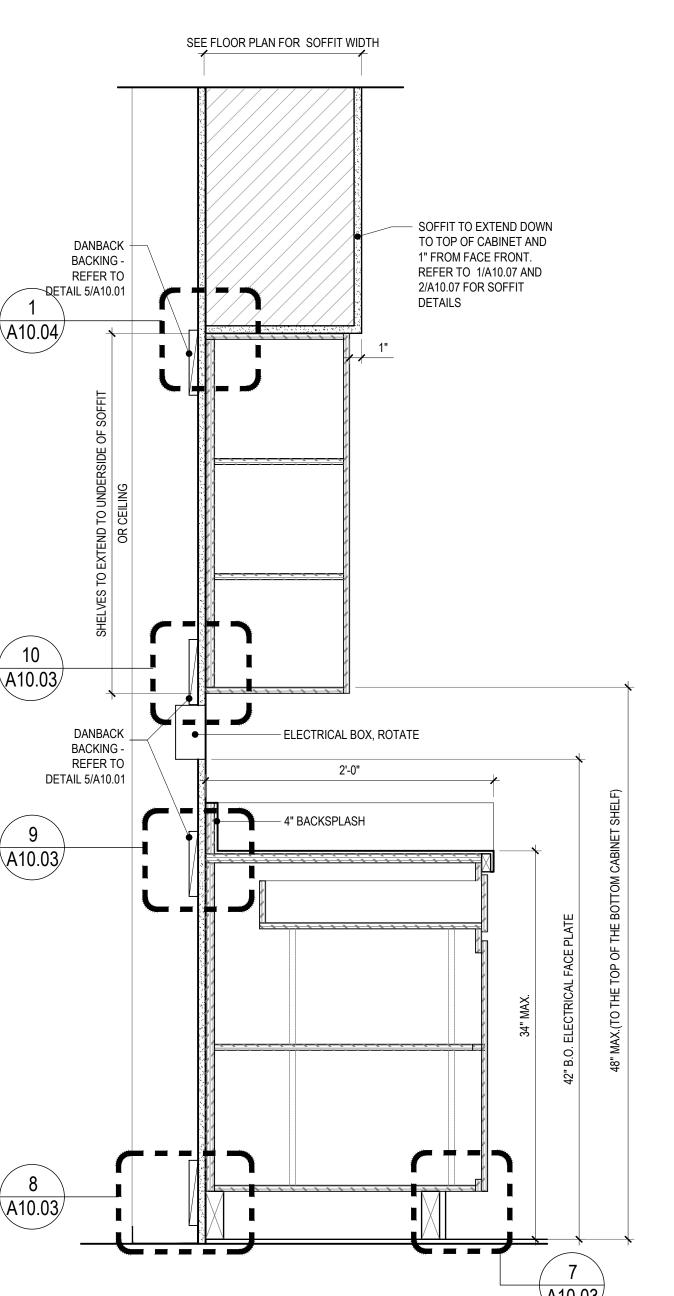

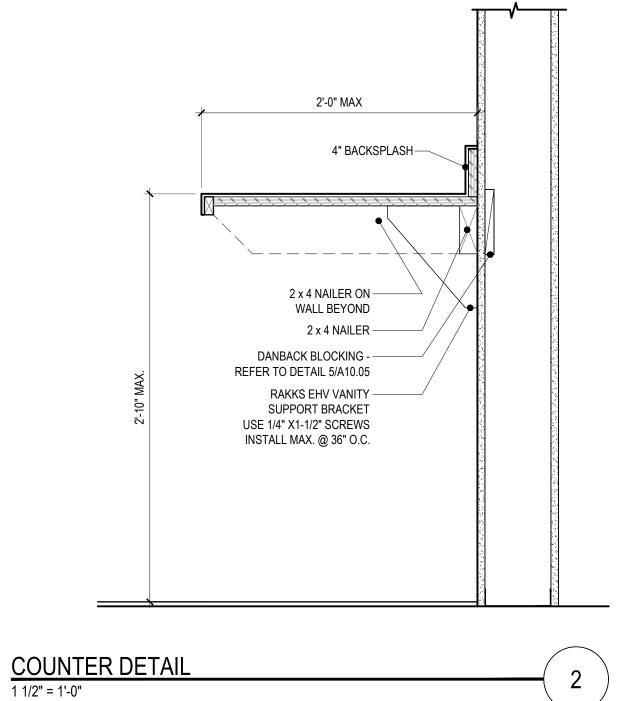

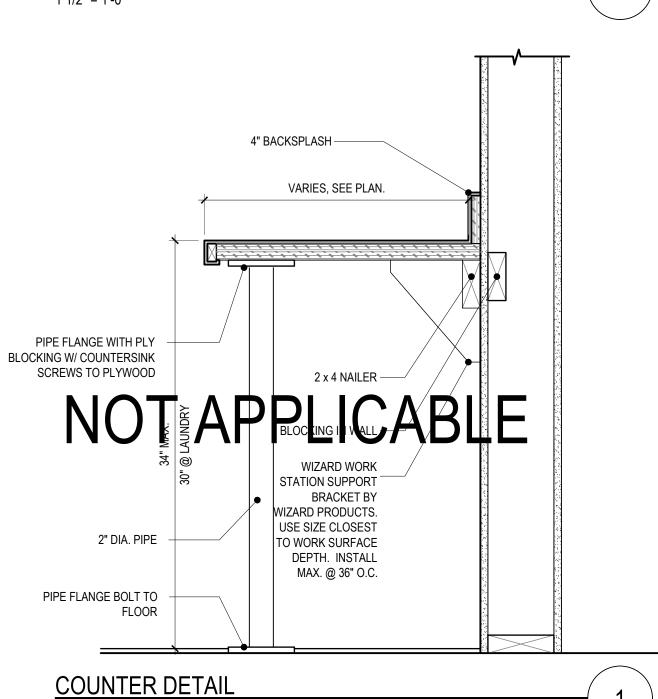

1 1/2" = 1'-0"

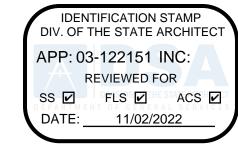

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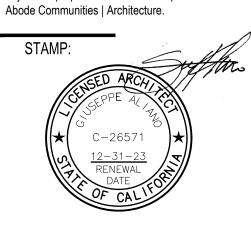
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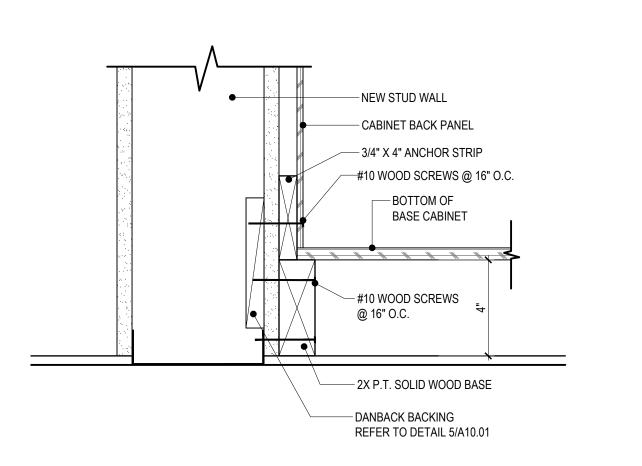
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SHEET NAME:

CABINET

ELEVATIONS &

SECTIONS
SHEET NUMBER:














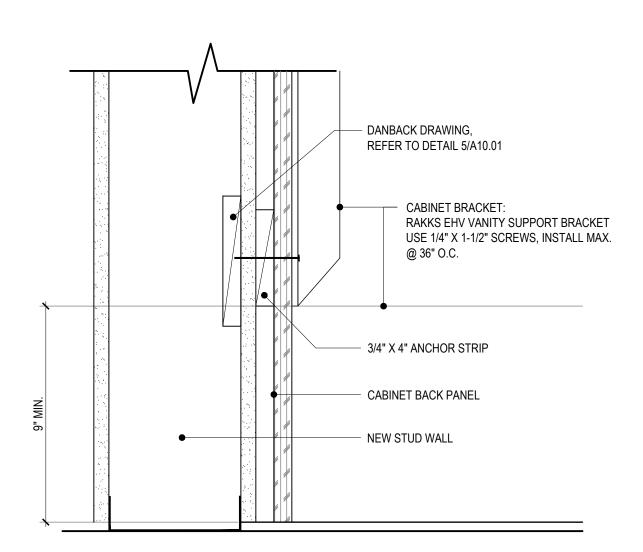

# OPEN CABINET ANCHORAGE DETAIL AT WALL 3"=1'-0"

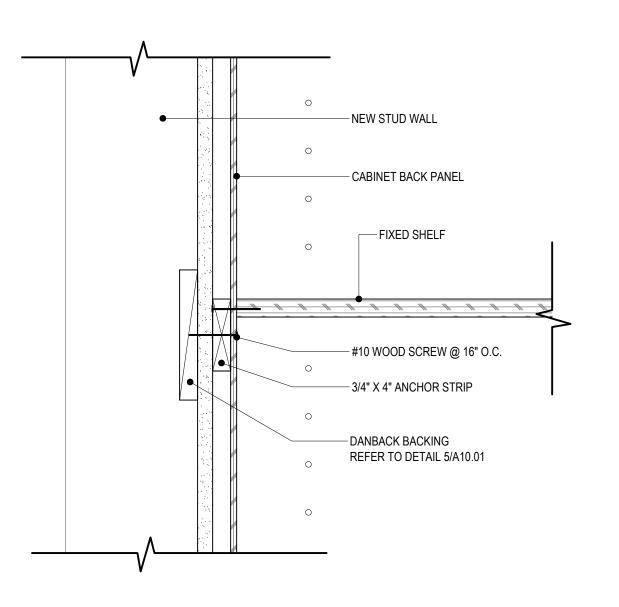

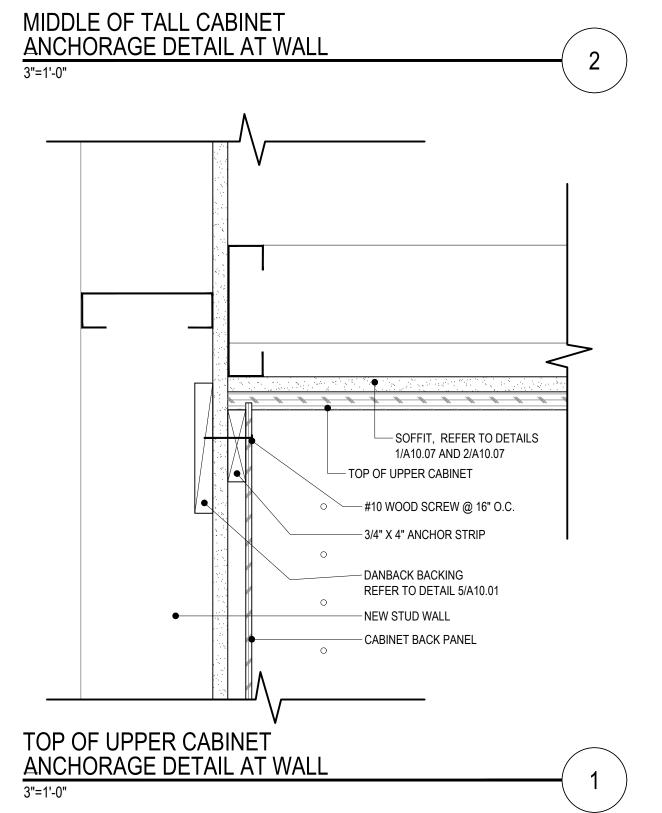

IDENTIFICATION STAMP DIV. OF THE STATE ARCHITECT

APP: 03-122151 INC:

REVIEWED FOR

SS FLS ACS D

DATE: 11/02/2022

# abode communities architecture

PROJECT:

## LAEP EARLY CHILDHOOD CENTER

13928 KORNBLUM AVE. HAWTHORNE, CA 90250

CLIENT:

#### Los Angeles Education Partnership 1541 Wilshire Blvd., Suite 200

Los Angeles, CA 90017 T: 213.622.5237

ARCHITECT: **Abode Communities**1149 S. Hill Street, Suite 700
Los Angeles, CA 90015
T: 213.629.2702

CONSULTANTS:

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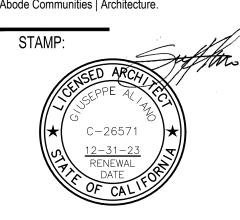
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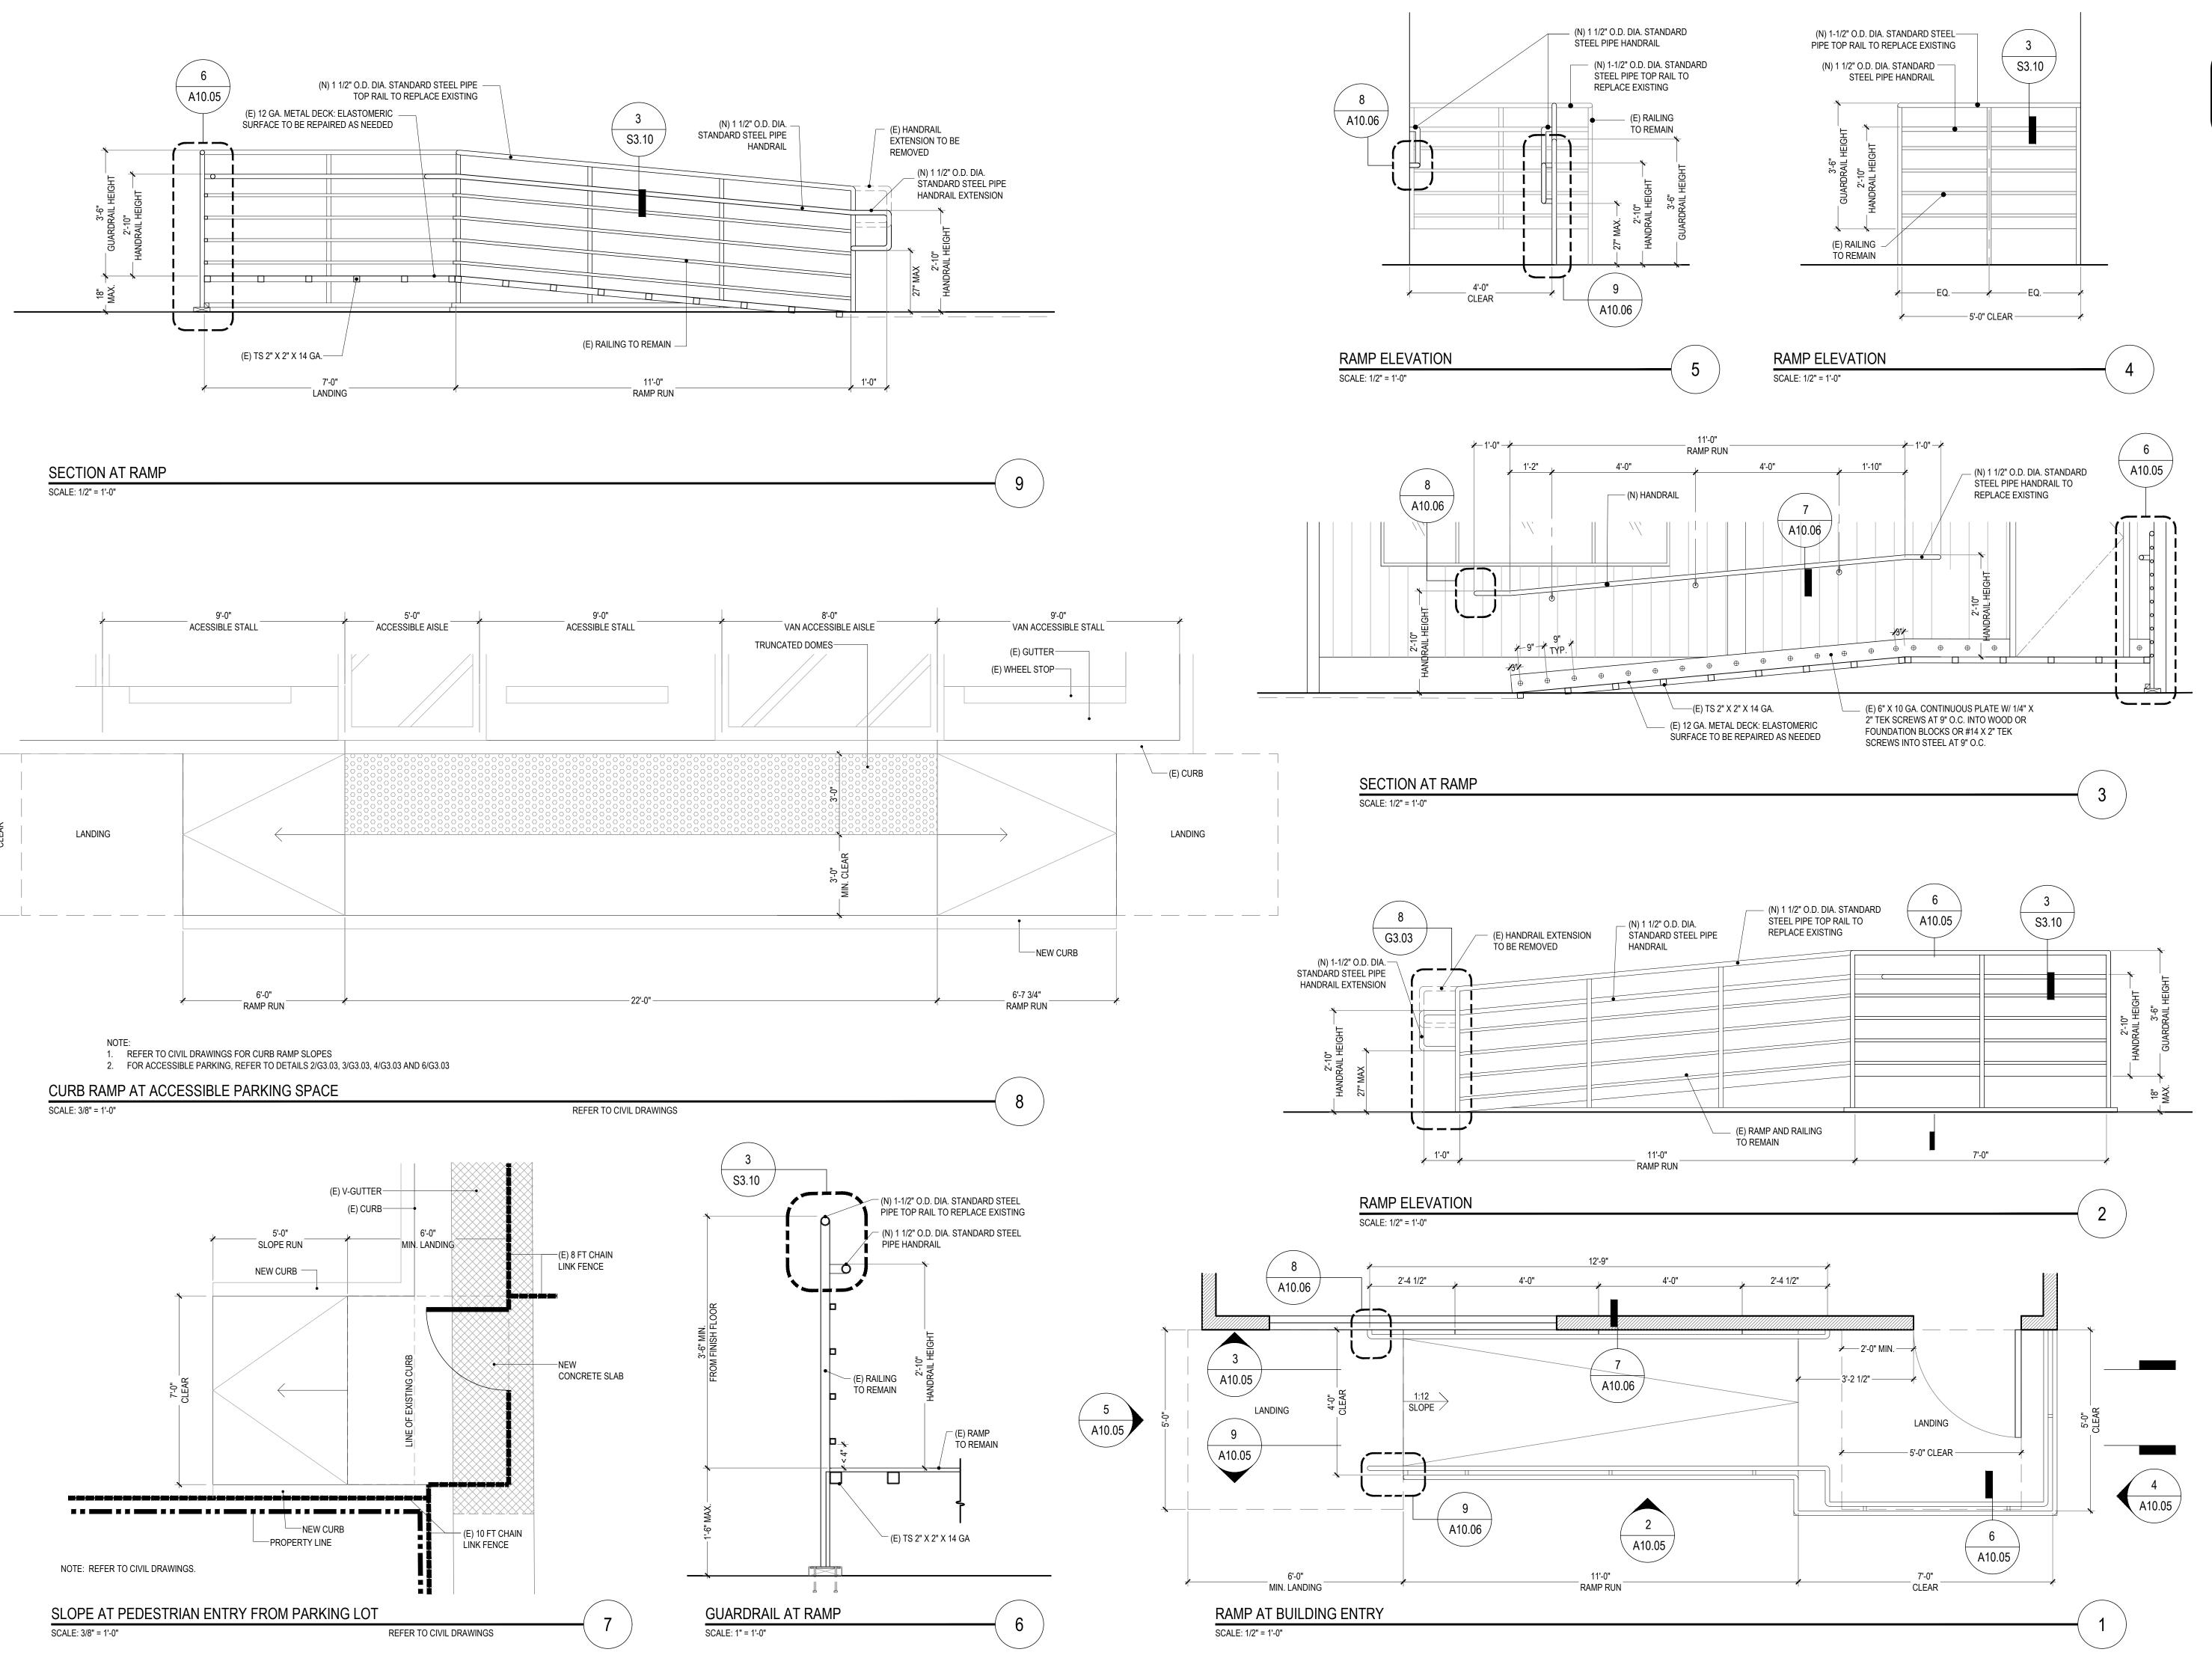
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DSA APPLICATION SET	04.01.22	
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DSA BACK-CHECK SET	10.24.22	
DSA BACK-CHECK SET	11.01.22	

SHEET NAME:

CABINET DETAILS



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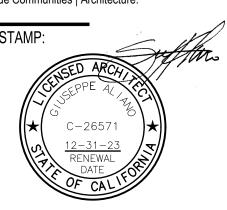
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DSA APPLICATION SET 04.01.22


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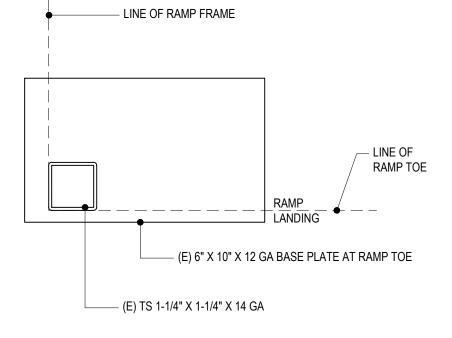
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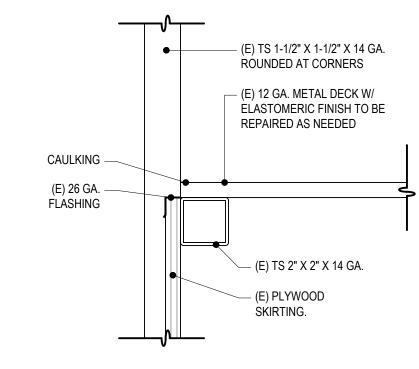
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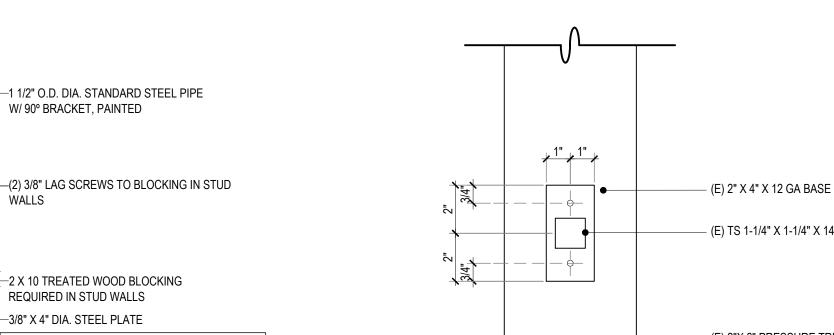
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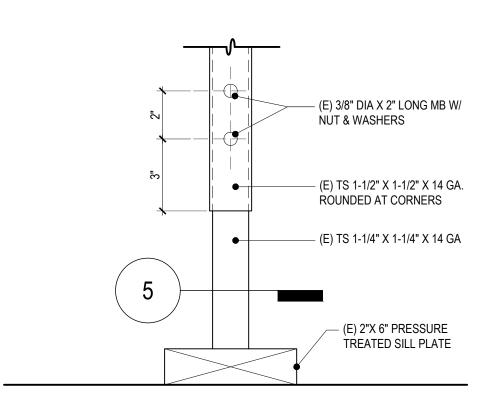





ADJUSTABLE LEG BASE PLATE


SCALE: 3" = 1'-0"

SCALE: 3" = 1'-0"

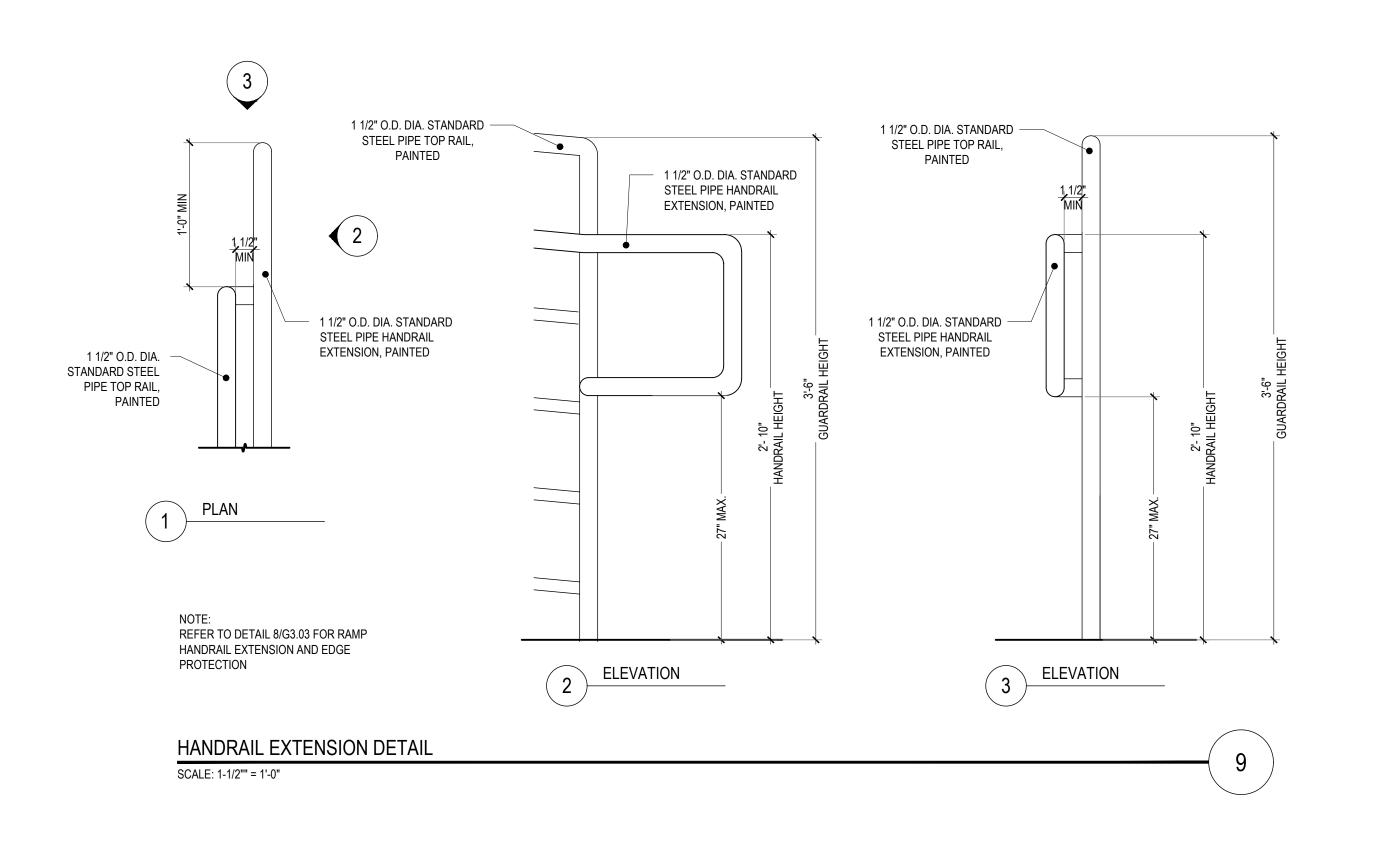

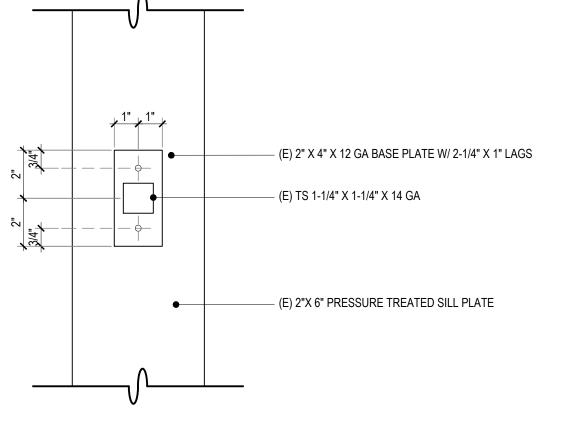



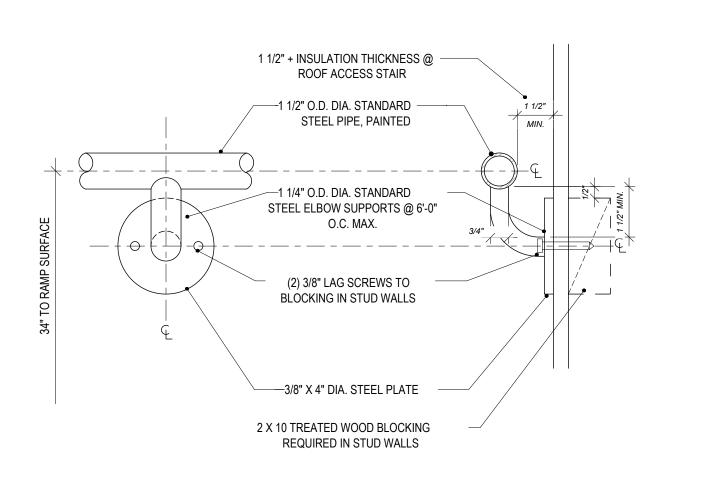

1. ALL HANDRAIL JOINTS TO BE WELDED &

2. ALL HANDRAILS TO BE MOUNTED 2'-10" FROM


THE CENTERLINE ABOVE LANDING AND/ OR RAMP


GROUND SMOOTH.

SURFACE.

WALL-MOUNTED HANDRAIL TERMINATION

SCALE: 3" = 1'-0"

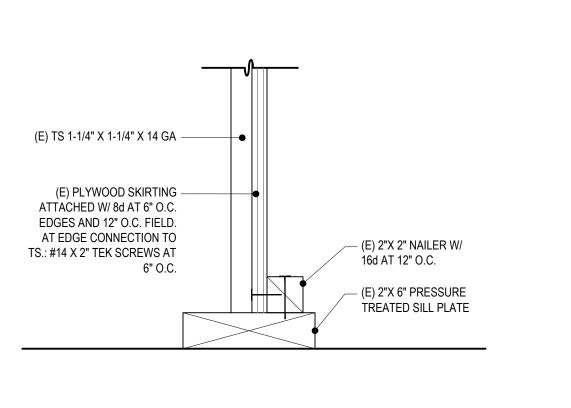


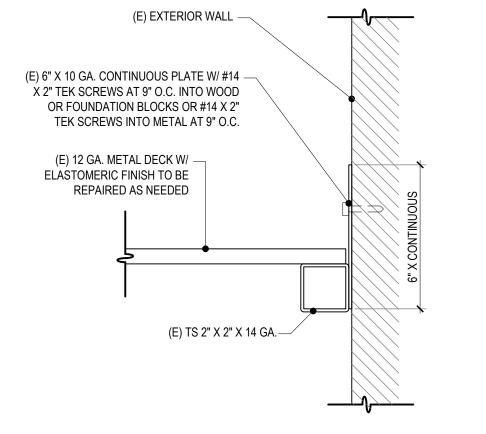

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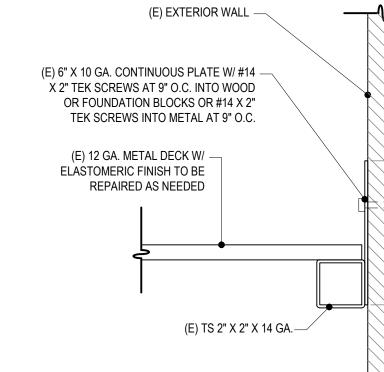
SHEET NAME: RAMP DETAILS

SHEET NUMBER: A10.06

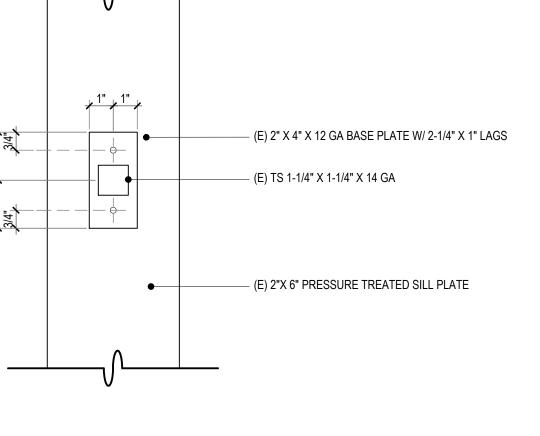

FOR REFERENCE ONLY


FOR REFERENCE ONLY





WALL-MOUNT HANDRAIL - MID RAIL	7
SCALE: 3" = 1'-0"	





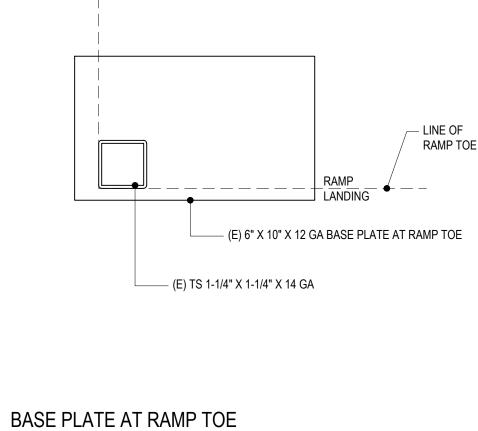

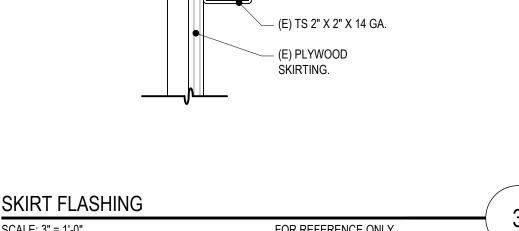

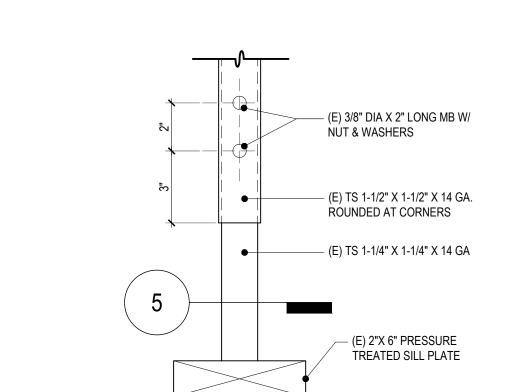

## DSA APPLICATION NUMBER: 03-122151

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abode

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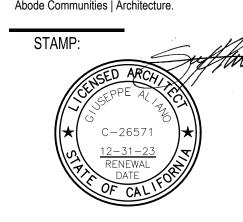
ARCHITECT:


communities

architecture

CHILDHOOD CENTER

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## abode communities architecture

PROJECT:
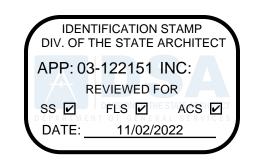
#### LAEP EARLY CHILDHOOD CENTER

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CLIENT: Los Angeles Education **Partnership** 1541 Wilshire Blvd., Suite 200

T: 213.622.5237 ARCHITECT:

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T: 310.464.8404 <u>STRUCTURAL</u> **Breen Engineering** 1983 W. 190th St., Suite 200 Torrance, CA 90504

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IKAUN IU WATUN STUDS. ATTAUN TU STUD, JUIST OR BLOCKING W/ 2 #10 SMS SCREWS AT 16" O.C. (E) 22 GA. STANDARD SEAM ROOF \_ (E) 6 3/8" X 2 1/2" - 14 GA. (E) ROOF SHEATHING \_ ROOF PURLINS \_4" STUD BLOCKING (350S125-43 @ 16" O.C.). ATTACH W/2#10 SMS SCREWS AT EACH END. COPY CLIPPING THE FLANGE AND BENDING THE WEB AT THE ENDS FOR HGT. SEE CLG. PLAN \_\_\_4" STUD BRACING @ 45 DEGREES (350S125-43 @ (N) SUSPENDED ACOUSTIC T-BAR CLG. (TYP.) REFER TO REFLECTED CEILING PLANS 48"O.C.). ATTACH W/ 3 #10 MTL. WALL TRIM - REFER TO SCREWS DETAIL 10/A10.01 (TYP.) STEEL STUD BLOCKING TO MATCH SOFFIT FRAMING 5/8" TYPE 'X' GWB -4" STUD (350S125-43 @ 16" O.C.). ATTACH -\_STEEL STUD BLOCKING TO W/ 2 #10 SMS SCREWS @ 16" O.C. MATCH WALL FRAMING DISTANCE VARIES. SEE RCP FOR CEILING TRACK TO MATCH STUDS. ATTACH TO -STUD, JOIST OR BLOCKING W/ 2 #10 SMS MAINTAIN 7'-0" CLEAR. SCREWS AT 16" O.C.

#### SOFFIT DETAIL @ FULL-HEIGHT WALL


5/8" TYPE 'X' GWB -

(E) 22 GA. STANDARD SEAM ROOF \_ (E) **7** 6 3/8" X 2 1/2" - 14 GA. \_ 4" STUD BRACING @ 45 DEGREES (350S125-43 @ (E) ROOF SHEATHING -ROOF PURLINS 48"O.C.). ATTACH W/ 3 #10 SCREWS (E) ROOF BEAM, REFER TO STRUCTURAL AS-BUILTS FOR HGT. SEE CLG. PLAN (N) SUSPENDED ACOUSTIC T-BAR CLG. (TYP.), REFER TO REFLECTED CEILING PLANS (E) EXTERIOR WALL, MTL. WALL TRIM - REFER TO -REFER TO STRUCTURAL DETAIL 10/A10.01 (TYP.) AS-BUILTS STEEL STUD BLOCKING TO -MATCH SOFFIT FRAMING 5/8" TYPE 'X' GWB -4" STUD (350S125-43 @ 16" O.C.). -ATTACH W/ 2 #10 SCREWS @ 16" O.C. DISTANCE VARIES. TRACK TO MATCH STUDS. ATTACH TO  $\_$ SEE RCP FOR CEILING HEIGHT. STUD, JOIST OR BLOCKING W/ 2 #10 SMS SCREWS AT 16" O.C. MAINTAIN 7'-0" CLEAR. 13" MIN - 25" MAX

#### SOFFIT DETAIL @ FURR-OUT WALL

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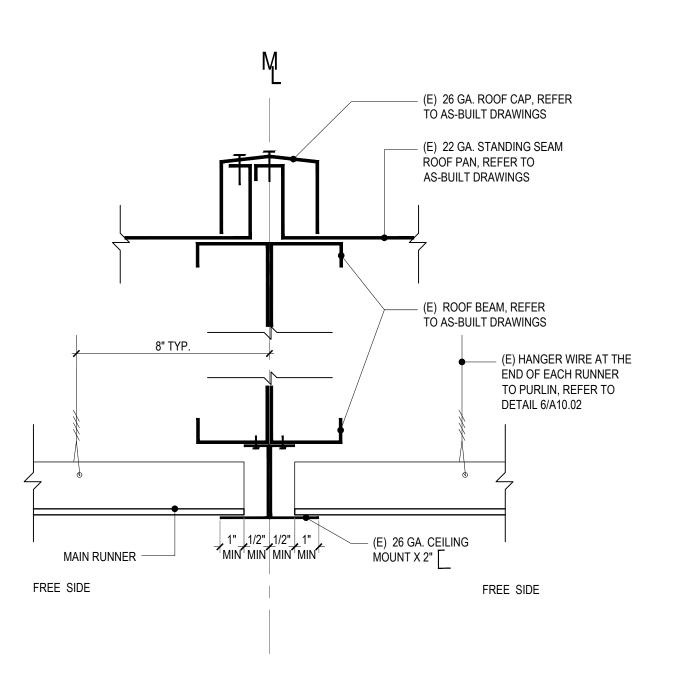
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DSA BACK-CHECK SET	11.01.22	

SHEET NAME: **DETAILS** 

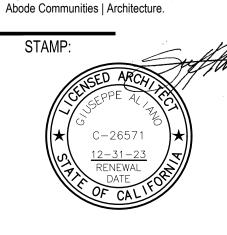SHEET NUMBER: A10.07



(E) 26 GA. ROOF CAP, REFER
 TO AS-BUILT DRAWINGS

(E) 22 GA. STANDING SEAM

RÓOF PAN, REFER TO

AS-BUILT DRAWINGS

(E) ROOF BEAM, REFER

TO AS-BUILT DRAWINGS

— (E) 26 GA. CEILING

MOUNT X 2"

——— (E) HANGER WIRE AT THE END OF EACH RUNNER

DETAIL 6/A10.02

FIXED SIDE

TO PURLIN, REFER TO


8" TYP.

CEILING GRID AT MOD LINE - ATTACHED JOINT


MAIN RUNNER -

FIXED SIDE

CEILING GRID AT MOD LINE - FREE JOINT

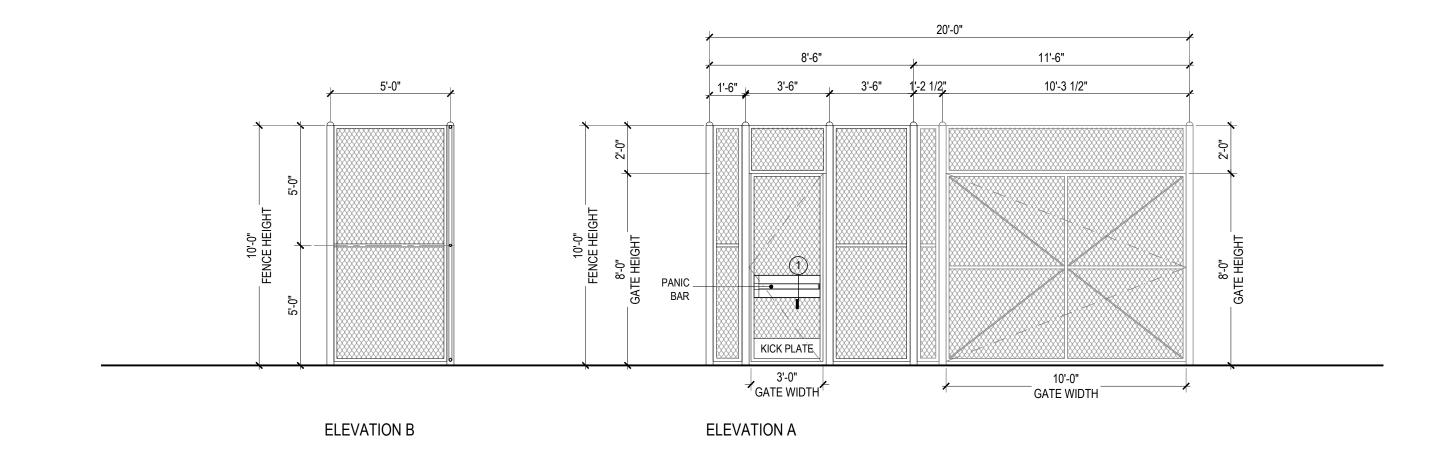

GATE ELEVATION SCALE: 1/4" = 1'-0"

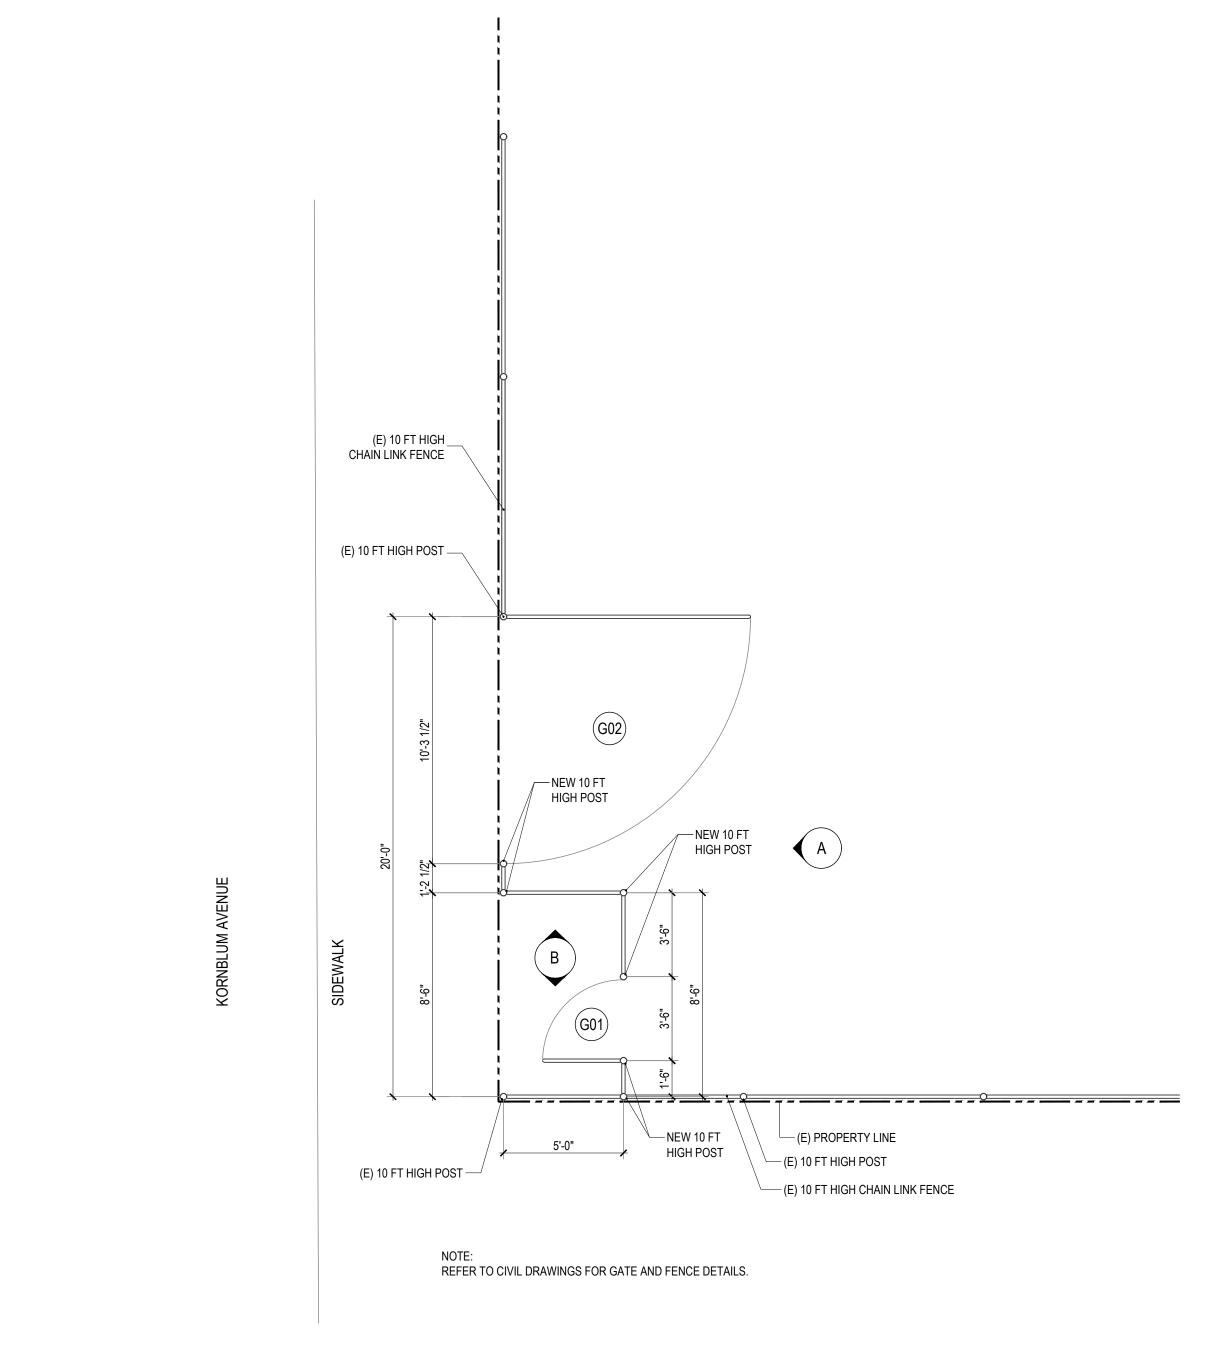

**GATE PLAN** SCALE: 1/4" = 1'-0"

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# abode communities architecture

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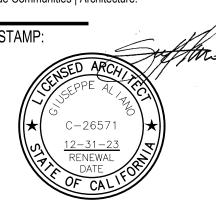
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SHEET NAME: **GATE DETAILS** 

#### V. FOUNDATIONS

- A. FOUNDATION DESIGN IS BASED ON PRESCRIPTIVE VALUES SET BY THE 2019 CBC CONTINUOUS FOOTINGS SHOULD HAVE MINIMUM WIDTH OF 12 INCHES AND DEPTH OF 24 INCHES.
- ISOLATED PAD FOOTINGS SHOULD HAVE MINIMUM WIDTH OF 24 INCHES.
- FOOTINGS SHOULD HAVE MINIMUM EMBEDMENT DEPTH OF 24 INCHES INTO COMPACTED FILL ALLOWABLE VERTICAL SOIL BEARING PRESSURE OF 1,500 PSF FOR DEAD AND FREQUENTLY APPLIED LIVE LOADS.
- ALLOWABLE PASSIVE EARTH PRESSURE OF 150 PSF/FT TO A MAXIMUM OF 1,500 PSF.
- COEFFICIENT OF FRICTION RESISTANCE AGAINST LATERAL SLIDING = 0.25. H. WHEN COMBINING PASSIVE EARTH PRESSURE AND FRICTION RESISTANCE, PASSIVE EARTH PRESSURE COMPONENT SHOULD BE REDUCED
- I. THE ALLOWABLE VERTICAL BEARING PRESSURE MAY BE INCREASED ONE-THIRD WHEN CONSIDERING SHORT DURATION WIND OR SEISMIC J. SOIL TYPE: ALLUVIUM.
- K. IF ADVERSE SOIL CONDITION IS ENCOUNTERED, A SOILS INVESTIGATION MAY BE REQUIRED.
- HOLDDOWN HARDWARE SHALL BE SECURED IN PLACE PRIOR TO FOUNDATION INSPECTION, IF ANY. M. DO NOT PLACE BACKFILL BEHIND RETAINING WALLS PRIOR TO COMPLETION AND INSPECTION OF WATERPROOFING. ADEQUATELY SHORE
- RETAINING WALLS DURING BACKFILL OPERATION. UNLESS ADEQUATELY SHORED, DO NOT PLACE BACKFILL BEHIND BUILDING STRUCTURE RETAINING WALLS (EXCLUDING SITE RETAINING WALLS) UNTIL CONCRETE AT ELEVATED FLOOR LEVELS ADJACENT TO WALLS HAS BEEN COMPLETELY POURED (IN AREA) AND HAS CURED FOR AT LEAST 7 DAYS.

#### VI. STRUCTURAL MATERIALS

#### A. REINFORCED CONCRETE

- 1. CEMENT SHALL CONFORM TO ASTM C-150, SEE NOTE "5" BELOW FOR CEMENT TYPE REQUIRED BASED ON CONCRETE USE.
- FLY ASH NOT ALLOWED. AGGREGATES SHALL CONFORM TO ASTM C-33 FOR STRUCTURAL NORMAL-WEIGHT CONCRETE (1" MAXIMUM SIZE).
- READY-MIX CONCRETE SHALL BE IN ACCORDANCE WITH ASTM C-94. 4. CONCRETE DESIGN MIXES SHALL BE IN ACCORDANCE WITH C.B.C. SEC. 1905A AND SHALL BE SIGNED BY A REGISTERED
- PROFESSIONAL ENGINEER, LICENSED IN THE STATE OF CALIFORNIA, AND HIRED BY CONTRACTOR. 5. ALL CONCRETE SHALL SATISFY BOTH THE MINIMUM STRENGTH REQUIREMENT AND MAXIMUM WATER-CEMENT RATIO BY WEIGHT AS FOLLOWS;
  - MAXIMUM

CONCRETE USE	MINIMUM COMPRESSIVE STRENGTH AT 28 DAYS F'c	WATER CEMENT RATIO BY WEIGHT	CEMENT TYPE
SLAB ON GRADE	3,000 PSI	0.50	II / V
FOOTINGS	3,000 PSI	0.50	II / V
ELEVATED SLAB, BEAMS, COLUMNS AND WALLS	4,000 PSI	0.50	II / V

- 6. THE SLUMP SHALL BE 4" FOR ALL CONCRETE WORK.
- ADMIXTURES MAY BE USED WITH THE APPROVAL OF THE ENGINEER. 8. REFER TO ARCHITECTURAL DRAWINGS FOR MOLDS, GROOVES, REVEALS, SCUPPERS, ORNAMENTS, CLIPS OR TEXTURES
- REQUIRED TO BE CAST INTO CONCRETE AND LOCATIONS AND EXTENTS OF DEPRESSIONS, CURBS AND RAMPS. 9. PROJECTING CORNERS OF SLABS, BEAMS, WALLS, COLUMNS, ETC. SHALL BE FORMED WITH 34" CHAMFERS UNLESS
- OTHERWISE NOTED. CONCRETE FORM TOLERANCES SHALL BE WITHIN ACI STANDARDS. 10. ALL REINFORCING STEEL, ANCHOR BOLTS, DOWELS AND OTHER INSERTS SHALL BE SECURED IN POSITION AND INSPECTED
- BY THE LOCAL BUILDING DEPARTMENT INSPECTOR PRIOR TO THE POURING OF ANY CONCRETE. 11. LOCATION OF CONSTRUCTION JOINTS NOT SPECIFICALLY INDICATED ON THE DRAWINGS SHALL BE APPROVED PRIOR TO PLACING REINFORCING STEEL.

#### B. REINFORCING STEEL

- 1. BAR REINFORCEMENT SHALL CONFORM TO:
  - ASTM A706, GRADE 60 . . . . . . . WELDABLE REBAR ASTM A615, GRADE 60 . . . . . . . ALL OTHER REBAR
- . WELDING OF REINFORCING STEEL SHALL CONFORM TO AWS D1.4. WELDED WIRE FABRIC SHALL CONFORM TO ASTM A185.
- 4. REINFORCING DETAILING, BENDING AND PLACING SHALL BE IN ACCORDANCE WITH THE CRSI "MANUAL OF STANDARD PRACTICE" LATEST EDITION.
- 5. LAPS AT BAR SPLICES SHALL BE: PER SCHEDULE IN TYPICAL DETAILS, UNLESS NOTED OTHERWISE. VERTICAL BARS IN WALLS SHALL BE ACCURATELY POSITIONED AT THE CENTER OF WALL, UNLESS OTHERWISE NOTED ON
- DETAILS, & SHALL BE TIED IN POSITION AT TOP AND BOTTOM AND AT INTERVALS NOT EXCEEDING 192 BAR DIA. 7. MINIMUM CONCRETE COVER TO REINFORCING STEEL SHALL BE AS FOLLOWS U.N.O.:
  - CONCRETE DEPOSITED AGAINST EARTH . . . CONCRETE FORMED EXPOSED TO EARTH OR WEATHER . . . 2" COLUMN REINFORCING (INCLUDING COLUMN TIES) . . . . . . 1 1/2"
- 8. ALL REINFORCING STEEL, ANCHOR BOLTS, DOWELS, AND INSERTS SHALL BE WELL SECURED IN POSITION PRIOR TO PLACING CONCRETE OR GROUT.
- 9. UNLESS OTHERWISE NOTED IN DETAILS, FURNISH #3 SPACER TIES AT APPROXIMATELY 2'-6" ON CENTER IN ALL BEAMS AND FOOTINGS TO SECURE REINFORCING STEEL IN PLACE.

#### I. GENERAL

SAFETY REQUIREMENTS.

PROCEEDING.

- A. ALL NEW CONSTRUCTION SHALL COMPLY WITH THE CONTRACT DOCUMENTS AND THE 2019 CALIFORNIA BUILDING CODE.
- B. THESE GENERAL NOTES SUPERSEDE THE REQUIREMENTS OF THE PROJECT SPECIFICATIONS, IN CASE OF CONFLICT BETWEEN THE PLANS AND SPECIFICATIONS, CONTACT THE OWNER'S REPRESENTATIVE.
- C. THE CONTRACTOR SHALL ASSUME SOLE AND COMPLETE RESPONSIBILITY FOR JOB SITE CONDITIONS DURING THE COURSE OF CONSTRUCTION, INCLUDING
- THE SAFETY OF ALL PERSONS AND PROPERTY, AND THIS REQUIREMENT SHALL APPLY CONTINUOUSLY AND NOT BE LIMITED TO NORMAL WORKING HOURS. D. THE CONTRACTOR SHALL BE RESPONSIBLE FOR ALL MEANS AND METHODS OF CONSTRUCTION AND THEY SHALL BE IN ACCORDANCE WITH ALL STATE AND FEDERAL
- E. THE STRUCTURAL DRAWINGS REPRESENT THE FINISHED STRUCTURE. UNLESS OTHERWISE INDICATED, THEY DO NOT INDICATE THE METHOD OF CONSTRUCTION. THE CONTRACTOR SHALL PROVIDE ALL MEASURES NECESSARY TO PROTECT THE STRUCTURE, WORKMEN OR OTHER PERSONS DURING CONSTRUCTION. SUCH MEASURES SHALL INCLUDE, BUT NOT BE LIMITED TO, BRACING, SHORING FOR CONSTRUCTION EQUIPMENT, SHORING FOR THE BUILDING, SHORING FOR EARTH BANKS, FORMS, SCAFFOLDING, PLANKING AND SAFETY NETS. CONTRACTOR, AT HIS OWN EXPENSE, SHALL ENGAGE PROPERLY QUALIFIED PERSONS TO DETERMINE WHERE AND HOW TEMPORARY PRECAUTIONARY MEASURES SHALL BE USED AND INSPECTION OF SAME IN THE FIELD. OBSERVATION VISITS BY THE ARCHITECT OR STRUCTURAL ENGINEER SHALL NOT
- INCLUDE INSPECTION OF THE ABOVE ITEMS AND DO NOT IN ANY WAY RELIEVE THE CONTRACTOR OF HIS RESPONSIBILITIES FOR THE ABOVE. F. THE CONTRACTOR SHALL VERIFY ALL DIMENSIONS, ELEVATIONS AND SITE CONDITIONS PRIOR TO STARTING WORK AND NOTIFY THE ARCHITECT AND ENGINEER IMMEDIATELY OF ANY DISCREPANCIES.
- G. DRAWING DIMENSIONS ARE TO FACE OF FINISH, JOINT CENTERLINE OR COLUMN GRID CENTERLINE UNLESS NOTED OTHERWISE.
- H. ALL OMISSIONS AND CONFLICTS BETWEEN THE VARIOUS ELEMENTS OF THE WORKING DRAWINGS AND/OR SPECIFICATIONS SHALL BE BROUGHT TO THE ATTENTION OF THE ARCHITECT AND ENGINEER BEFORE PROCEEDING WITH WORK SO INVOLVED. I. DO NOT USE SCALED DIMENSIONS, USE WRITTEN DIMENSIONS. WHERE NO DIMENSION IS PROVIDED CONSULT THE ARCHITECT FOR CLARIFICATION BEFORE
- J. PIPES, DUCTS, SLEEVES, CHASES, ETC. SHALL NOT BE PLACED IN SLABS, BEAMS, OR WALLS UNLESS SPECIFICALLY SHOWN OR NOTED. STRUCTURAL MEMBER SHALL NOT BE CUT FOR PIPES, DUCTS, OR OTHER ITEMS UNLESS OTHERWISE NOTED ON THE STRUCTURAL PLANS. THE CONTRACTOR SHALL OBTAIN PRIOR APPROVAL FOR THE INSTALLATION OF ADDITIONAL PIPES, DUCTS, OR OTHER ITEMS. REFER TO ARCHITECTURAL AND MECHANICAL DRAWINGS FOR LOCATIONS.
- K. SEE DRAWINGS OTHER THAN STRUCTURAL FOR; FLOOR FINISHES AND LOCATIONS; FLOOR SLAB DEPRESSIONS; WALL AND FLOOR OPENINGS REQUIRED FOR ARCHITECTURAL AND MECHANICAL FEATURES; SITE PAVING, WALKS, RAMPS, STAIRS, CURBS, ETC.
- L. HOLES AND OPENINGS THROUGH WALLS, FLOORS AND ROOFS FOR DUCTS, PIPING AND VENTILATION SHALL BE COORDINATED BY THE CONTRACTOR WHO SHALL VERIFY SIZES AND LOCATION OF SUCH HOLES OR OPENINGS WITH THE MECHANICAL, PLUMBING, AND ELECTRICAL DRAWINGS AND THESE SUB-CONTRACTORS.
- M. WHERE CERTAIN FEATURES ARE NOT FULLY SHOWN OR CALLED FOR ON THE DRAWINGS OR SPECIFICATIONS, THEIR CONSTRUCTION SHALL MATCH SIMILAR CONDITIONS THAT ARE CALLED FOR OR SHOWN ELSEWHERE ON THE PLANS.
- N. THE CONTRACTOR SHALL BE RESPONSIBLE FOR OBTAINING NECESSARY LICENSES AND PERMITS. AND SHALL CONFORM TO ALL STATE AND LOCAL LAWS GOVERNING THE WORK.
- O. THE CONTRACTOR SHALL VERIFY THE LOCATION OF EXISTING UTILITIES BEFORE BEGINNING WORK AND SHALL PROTECT UTILITIES REMAINING IN SERVICE DURING CONSTRUCTION.
- P. ALL EXISTING FINISHES, STRUCTURAL ELEMENTS AND ARCHITECTURAL FEATURES AFFECTED BY CONSTRUCTION ARE TO BE REPAIRED AND/OR REPLACED TO MATCH EXISTING CONSTRUCTION.
- Q. REFER TO DRAWINGS BY OTHERS FOR INFORMATION NOT SHOWN ON THE STRUCTURAL DRAWINGS, INCLUDING BUT NOT LIMITED TO THE FOLLOWING:
- 1. MECHANICAL, ELECTRICAL AND PLUMBING EQUIPMENT SEISMIC ANCHORAGE; - SEE MECHANICAL, ELECTRICAL AND PLUMBING DRAWINGS DRAWINGS.
- 2. VERTICAL SUPPORT AND LATERAL BRACING FOR SUSPENDED UTILITY PIPING AND MECHANICAL DUCTING; SEE MECHANICAL, ELECTRICAL AND
- 1. WORK NOT PARTICULARLY SHOWN OR SPECIFIED SHALL BE SAME AS SIMILAR PARTS THAT ARE SHOWN OR SPECIFIED, OR AS DIRECTED. WHERE DRAWINGS SHOW PORTIONS OF THE WORK DETAILED AND OTHER AREAS OUTLINED ONLY, THE DETAILED PARTS SHALL ALSO APPLY TO ALL OTHER LIKE
- 2. EXCEPT WHERE CONDITIONS ARE SPECIFICALLY DETAILED, NOTES AND DETAILS LABELED "TYPICAL" SHALL APPLY TO ALL SIMILAR WORK NOT
- SPECIFICALLY REFERENCED S. PRIOR TO ALL CORING, THE CONTRACTOR SHALL IDENTIFY EXISTING REINFORCING LOCATIONS BY PACHHOMETER, PROBING, CHIPPING, ETC. TO AVOID
- T. CONTRACTOR SHALL SUBMIT STAMPED & SIGNED DRAWINGS & CALCULATIONS FOR STAIRS & EXTERIOR WALLS FOR REVIEW BY THE ENGINEER OF RECORD. U. CONTRACTOR SHALL BE RESPONSIBLE FOR THE CONSTRUCTION OF A WIND OR SEISMIC FORCE RESISTING SYSTEM/COMPONENT LISTED IN THE "STATEMENT
- OF SPECIAL INSPECTION" SHALL SUBMIT A WRITTEN STATEMENT OF RESPONSIBILITY TO THE LADBS INSPECTORS AND THE OWNER PRIOR TO COMMENCEMENT OF WORK ON SUCH SYSTEM OR COMPONENT PER CBC SECTION 1704.4. V. USE OF WET MIX SHOTCRETE SHALL COMPLY WITH THE REQUIREMENTS OF PROJECT STRUCTURAL DRAWINGS AND SPECIFICATIONS IN ADDITION TO
- REQUIREMENTS OF SECTION 1908A OF 2019 CBC. W. A COPY OF THE LOS ANGELES RESEARCH REPORT AND/OR CONDITIONS OF LISTING SHALL BE MADE AVAILABLE AT JOB SITE.

#### II. DESIGN BASIS

A.	CODE:	2019	CALIFORNIA E	BUILDING	CODE	(CBC)			
В.	LIVE LOADS:								(0) 10000000
C.	LATERAL LOADS:	FLOOR			• • •	LL =	50	PSF	(CLASSROOM

1. <u>SEISMIC:</u> (ASCE 7-16)

DAMAGE EXISTING REINFORCING

```
... l_e = 1.25 (CLASSROOM)
SEISMIC IMPORTANCE FACTOR . .
MAPPED SPECTRAL RESPONSE ACCELERATIONS . . . . S_s = 1.815, S_1 = 0.640
SITE CLASS .
DESIGN SPECTRAL RESPONSE COEFFICIENTS . .
                                        S_{DS} = 1.452, S_{D1} = 0.725
SEISMIC DESIGN CATEGORY
SEISMIC FORCE RESISTING SYSTEM . . . . . . RIGID FRAME
DESIGN BASE SHEAR . . . . . . . . . . . . . . N/A (NO ALTERATIONS)
SEISMIC RESPONSE COEFFICIENT . . . . . . . N/A (NO ALTERATIONS)
RESPONSE MODIFICATION FACTOR . . . . . . . . N/A (NO ALTERATIONS)
ANALYSIS PROCEDURE . . . . . . . . . . . . . . . N/A (NO ALTERATIONS)
HORIZ. STRUCTURAL IRREGULARITIES . . . . . . NONE
VERT. STRUCTURAL IRREGULARITIES . . . . . . NONE
LOCATION OF SEISMIC BASE . . . . . . . . AT GRADE
```

2. <u>WIND:</u> (ASCE 7-16)

```
BASIC WIND SPEED . . . . . . . . . . . . . V = 101 MPH, V_{ASD} = 74 MPH
DESIGN PRESSURE FOR C&C . . . . . . . . N/A
```

#### III. QUALITY CONTROL AND INSPECTIONS

A. SPECIAL INSPECTION REQUIRED AS NOTED IN THE DSA 103 FORM. INSPECTIONS SHALL BE IN ACCORDANCE WITH CBC SECTION 108 AND CHAPTER 17A BY A CERTIFIED SPECIAL INSPECTOR RETAINED BY THE OWNER. REFER TO ARCHITECTURAL DRAWINGS FOR SPECIAL INSPECTION REQUIREMENTS FOR ARCHITECTURAL COMPONENTS AND NON-STRUCTURAL WORK. REFER TO MECHANICAL AND ELECTRICAL DRAWINGS FOR SPECIAL INSPECTION REQUIREMENTS FOR MECHANICAL AND ELECTRICAL COMPONENTS.

#### IV. TESTING AND OTHER INSPECTIONS

A. OWNER'S TESTING AGENCY SHALL PERFORM MATERAIL TESTING PER THE DSA 103 FORM

	STRUCTURAL SHEET INDEX
SHEET NO.	SHEET TITLE
S0.01	GENERAL NOTES
S2.10	FOUNDATION PLANS
S3.10	DETAILS

IDENTIFICATION STAMP DIV. OF THE STATE ARCHITEC APP: 03-122151 INC: REVIEWED FOR SS 🗹 FLS 🗹 ACS 🗹 DATE: 11/02/2022

## abode communities

#### LAEP EARLY CHILDHOOD CENTER

13928 KORNBLUM AVE. **HAWTHORNE, CA 90250** 

CLIENT:

Los Angeles Education Partnership 1541 Wilshire Blvd., Suite 200 Los Angeles, CA 90017

ARCHITECT:

T: 213.622.5237

**Abode Communities** 1149 S. Hill Street, Suite 700 Los Angeles, CA 90015 T: 213.629.2702

CONSULTANTS:


Breen Engineering 1983 W. 190th St., Suite 200 Torrance, CA 90504 T: 310.464.8404

MECHANICAL/ **ELECTRICAL/ PLUMBING Breen Engineering** 1983 W. 190th St., Suite 200 Torrance, CA 90504 T: 310.464.8404

STRUCTURAL **Breen Engineering** 1983 W. 190th St., Suite 200 Torrance, CA 90504 T: 310.464.8404

#### DSA APPLICATION NUMBER: 03-122151

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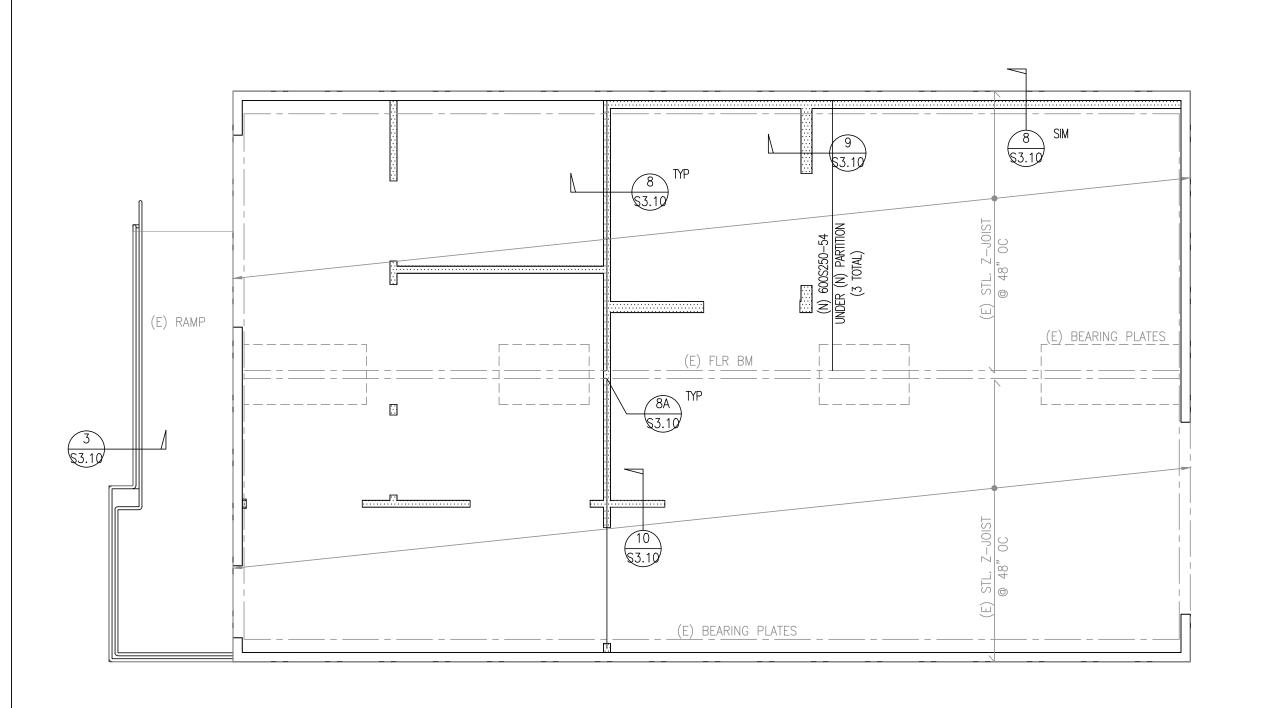
PROGRESS SET 02.01.22 DSA PROGRESS SET 03.02.22 DSA APPLICATION SET 04.01.22 DSA BACK-CHECK SET 10.05.22 DSA BACK-CHECK SET 10.24.22 DSA BACK-CHECK SET 11.01.22

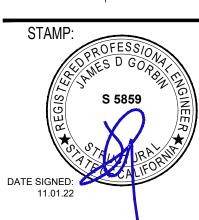DATE REV

SHEET NAME: **GENERAL NOTES** 

SHEET NUMBER:


S0.01




D. BUNGALOW 04 - FOUNDATION PLAN






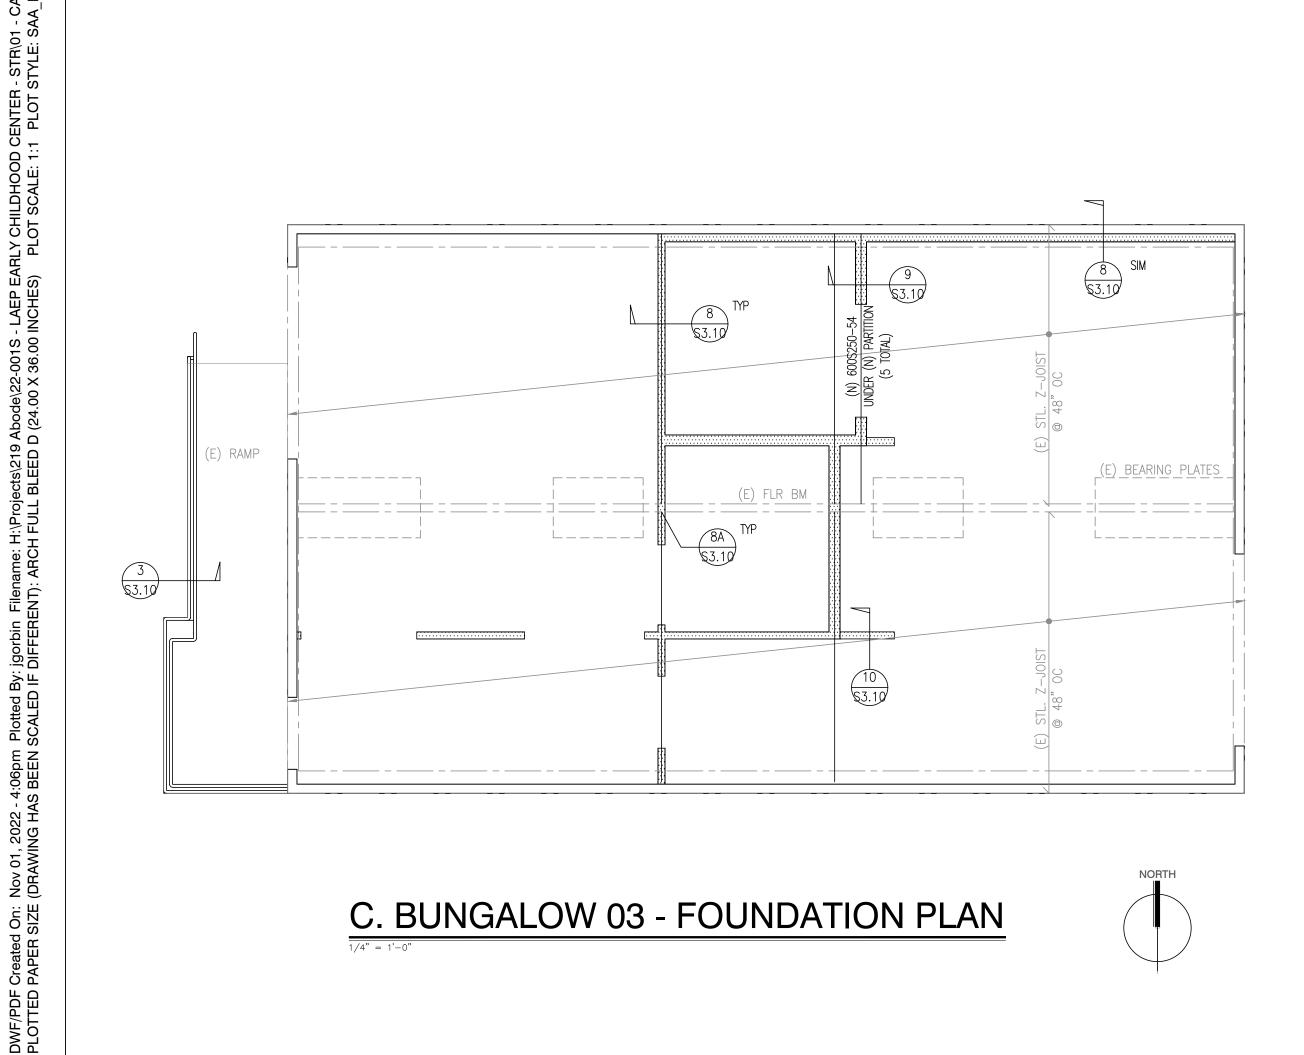



C. BUNGALOW 03 - FOUNDATION PLAN

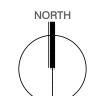

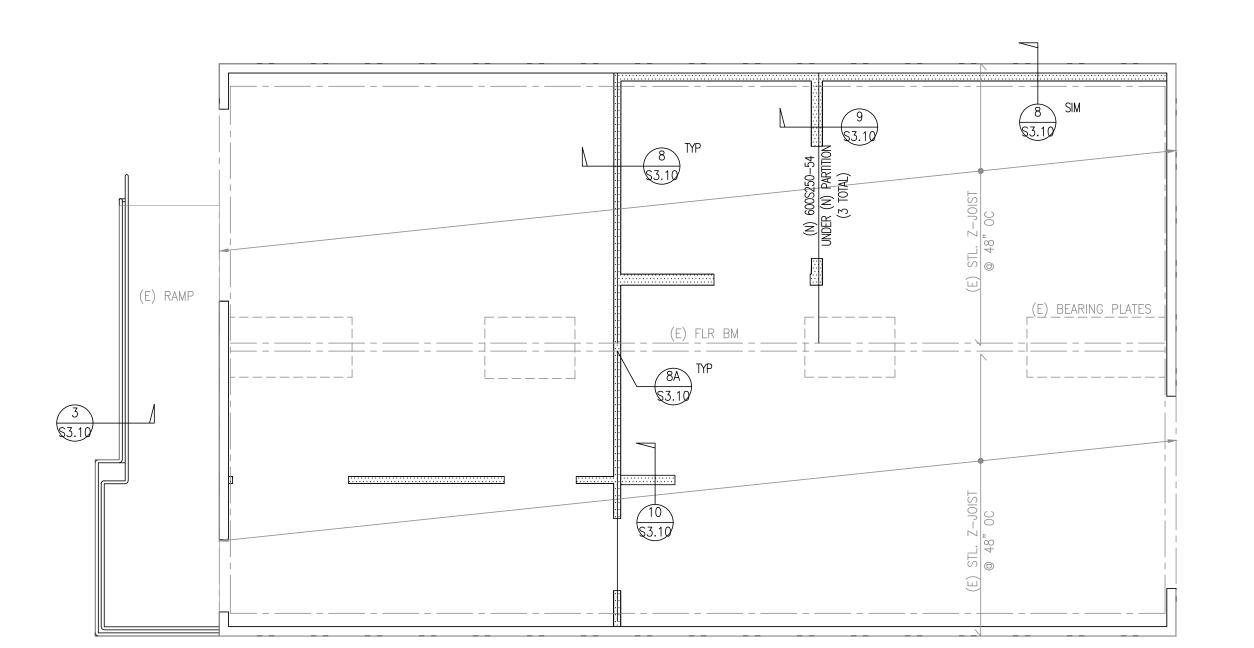


B. BUNGALOW 02 - FOUNDATION PLAN

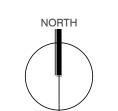

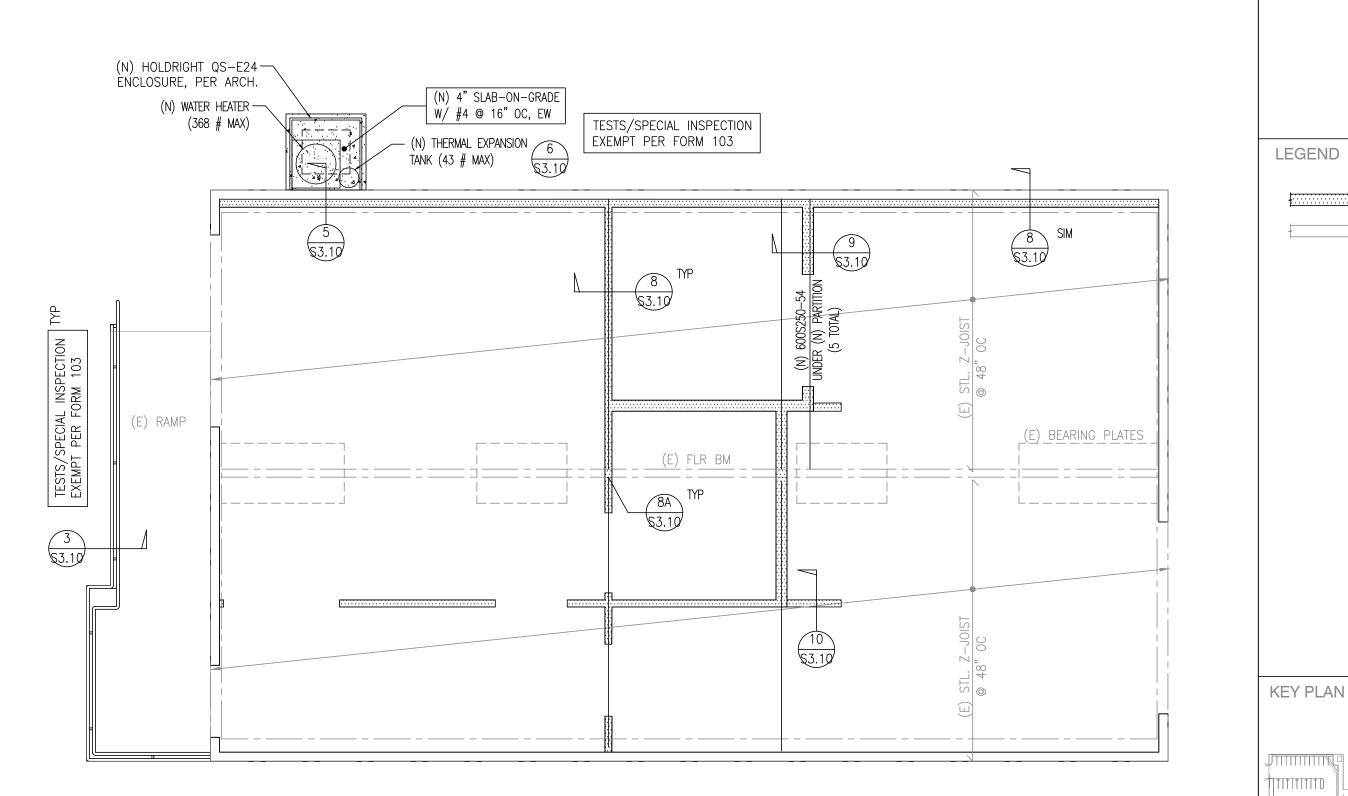

A. BUNGALOW 01 - FOUNDATION PLAN

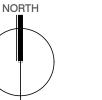

#### NOTES

- SEE SHEET SO.01 FOR GENERAL NOTES. GENERAL NOTES APPLY TO ALL PARTS OF WORK EXCEPT WHERE SPECIFICALLY DETAILED OR UNLESS NOTED OTHERWISE.
- FOR ALL DIMENSIONS, SEE ARCHITECTURAL
- FRAMING CONTRACTOR TO COORDINATE LAYOUT WITH ALL APPLICABLE TRADES INCLUDING PLUMBING, MECHANICAL AND
- ELECTRICAL. SEE PLAN AND DETAILS FOR CONCRETE SLAB
- ON GRADE INFO. REFER TO ARCHITECTURAL, MECHANICAL, ELECTRICAL, PLUMBING AND CIVIL DRAWINGS FOR VERIFICATION OF ALL DIMENSIONS, ELEVATIONS, SLAB EDGES, SLAB DEPRESSIONS, SLAB OPENING, CURBS, FOOTING PENETRATIONS, SLAB PENETRATIONS, WALL OPENINGS AND EQUIPMENT PAD. NOTIFY ENGINEER WHEN ANY DISCREPANCY IS ENCOUNTERED.

IDENTIFICATION STAMP DIV. OF THE STATE ARCHITEC APP: 03-122151 INC: REVIEWED FOR SS 🗹 FLS 🗹 ACS 🗹 DATE: 11/02/2022

#### abode communities architecture

PROJECT:

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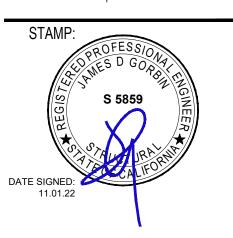
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DSA BACK-CHECK SET	11.01.22	


SHEET NAME: FOUNDATION **PLANS** 

SHEET NUMBER: S2.10

AREA OF WORK

LEGEND

(E) WALL

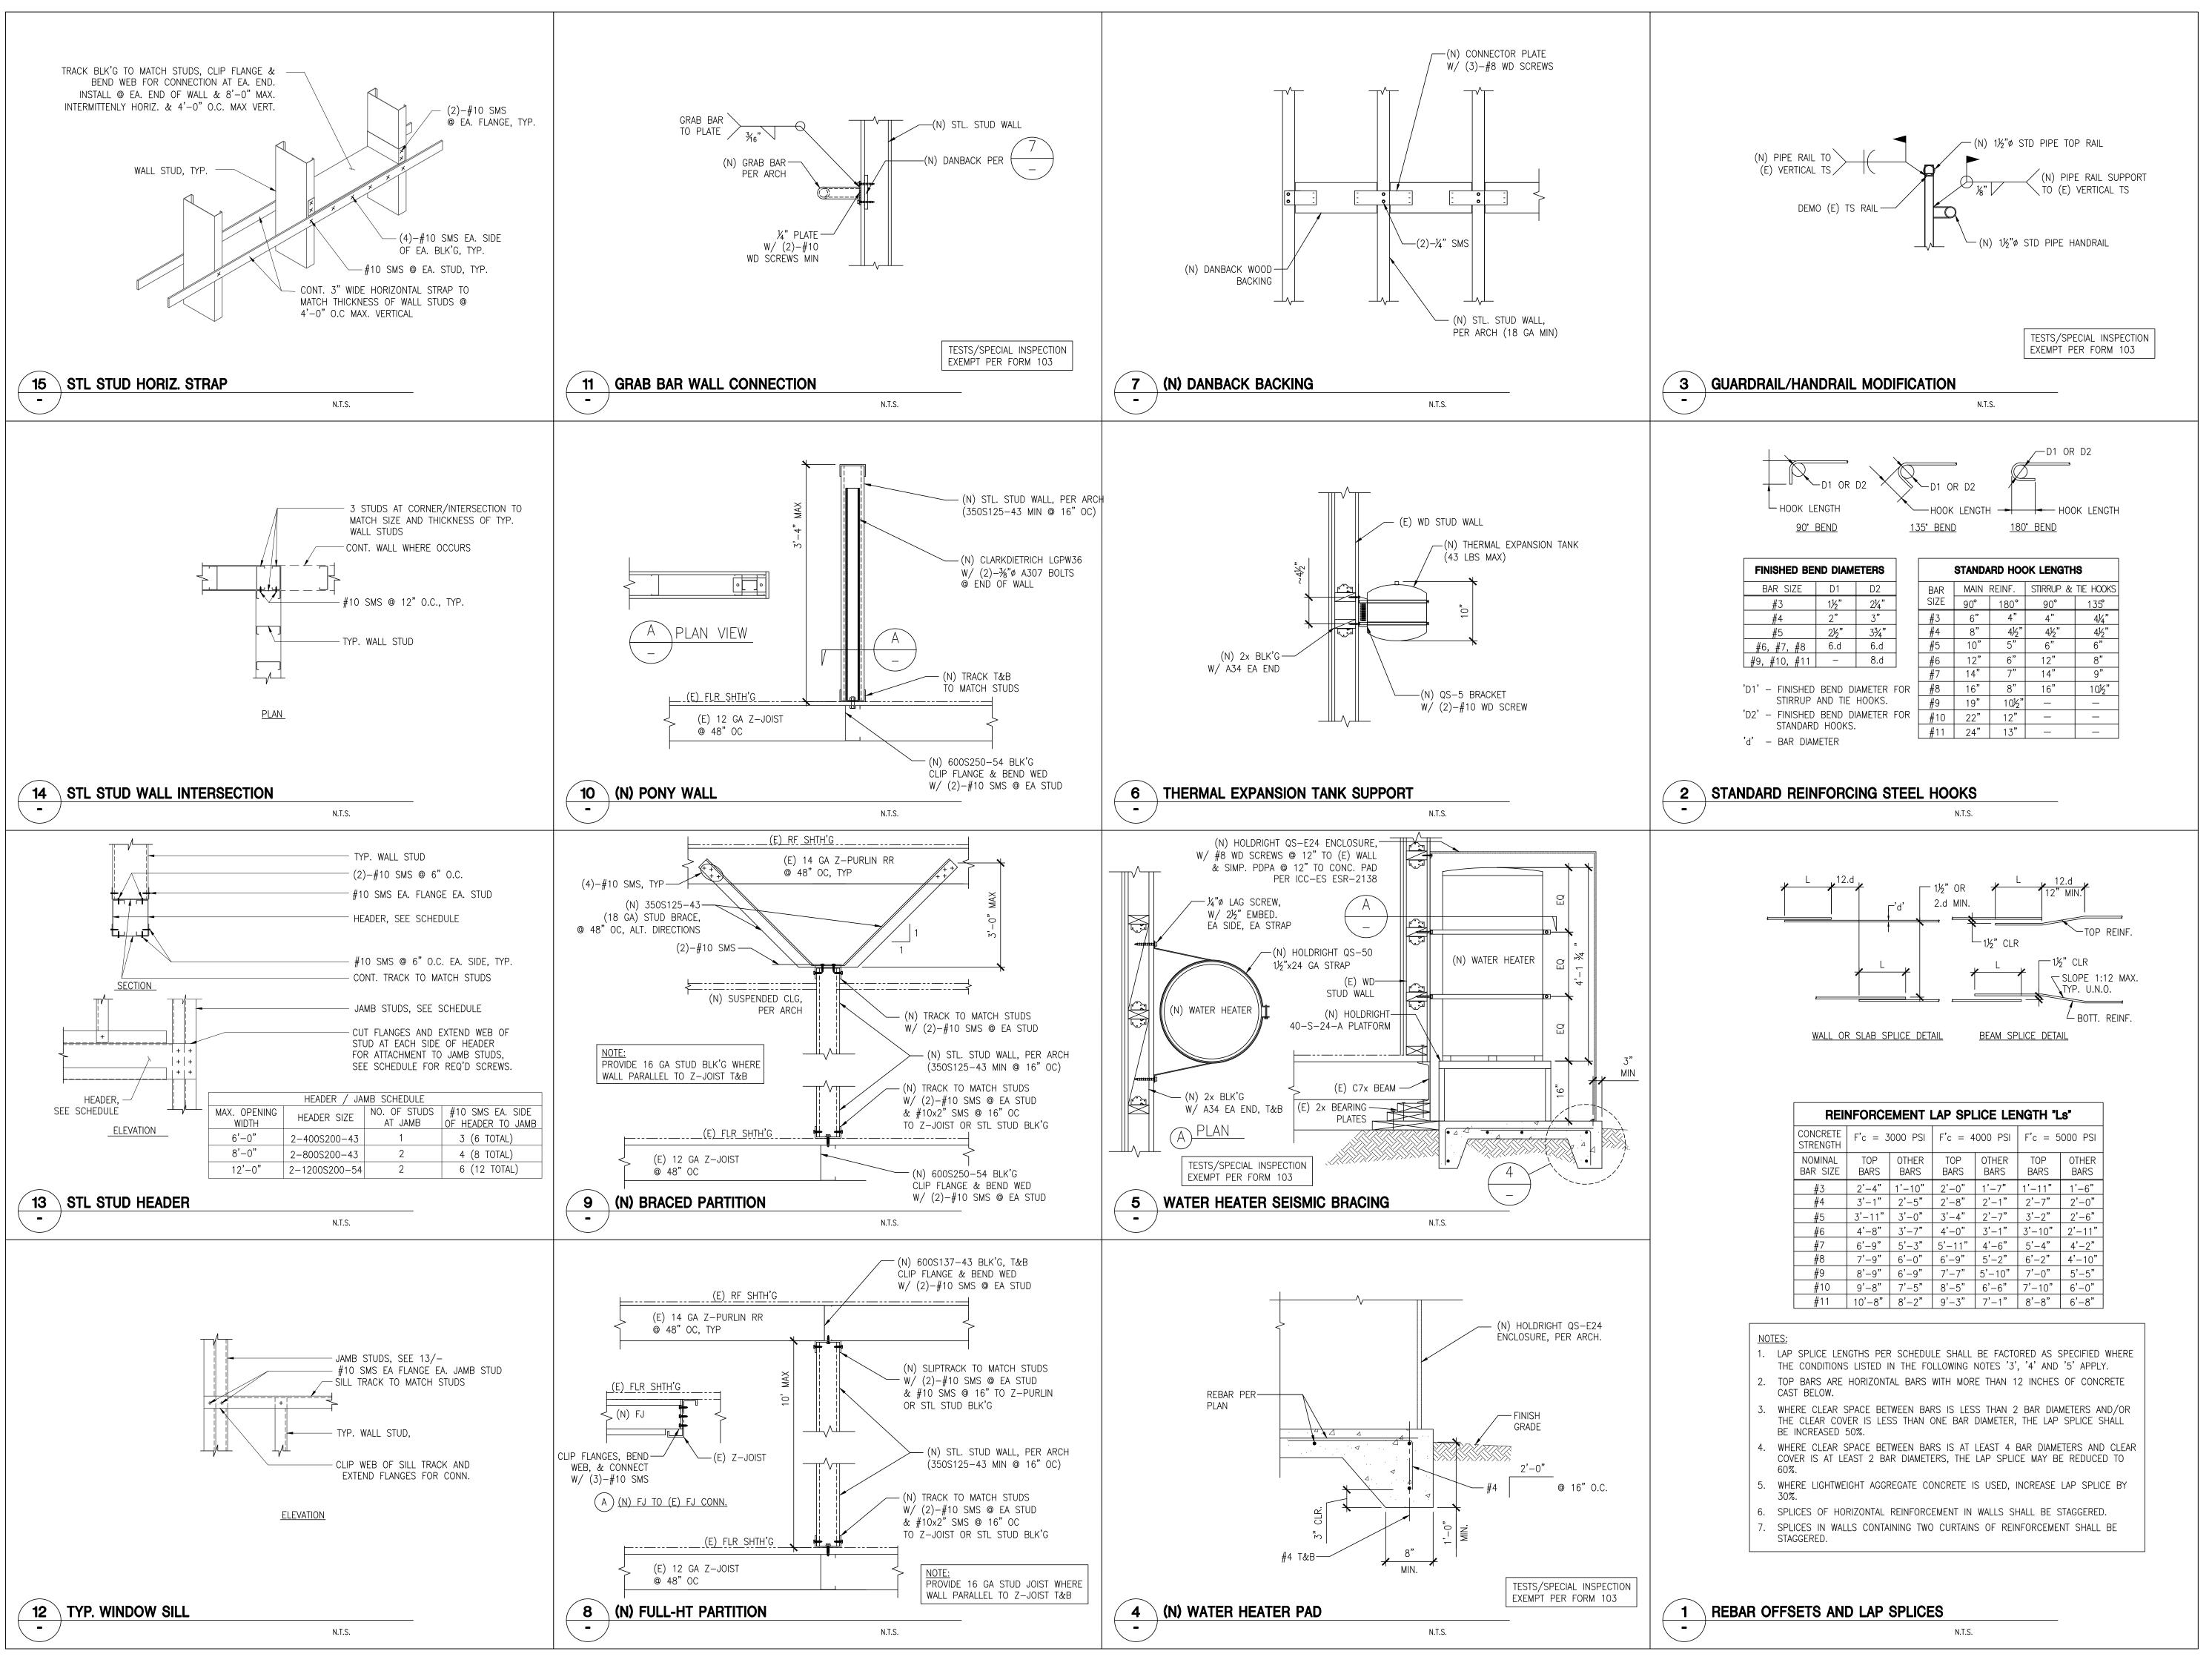

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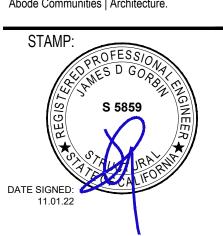
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DSA BACK-CHECK SET	10.05.22	
DSA BACK-CHECK SET	10.24.22	
DSA BACK-CHECK SET	11.01.22	

SHEET NAME: **DETAILS** 

SHEET NUMBER:

S3.10

#### TYPE OF OCCUPANCY: I-4, E. TYPE OF CONSTRUCTION: TYPE V-B.

- CONCEALED SPACES, CIRCULATING AIR. NO COMBUSTIBLE MATERIAL (SUCH AS EXPOSED COMMUNICATION CABLES INSULATED WIRES, PLASTIC TUBING OR PIPING, PIPE INSULATION, INSULATED PAN INSULATION) SHALL BE LOCATED IN SPACES USED TO CONVEY CIRCULATING AIR SUPPLY. WHEN COMBUSTIBLE MATERIAL IS TO BE LOCATED IN THE ABOVE SPACES, IT 6. PIPING: SHALL BE APPROVED BY LOCAL AUTHORITY FOR SUCH INSTALLATION.
- CODES AND PERMITS: ALL EQUIPMENT, INSTALLATION, ETC., SHALL CONFORM TO LOCAL ELECTRICAL, MECHANICAL AND OTHER APPLICABLE CODES. UNLESS OTHERWISE AGREED, CONTRACTOR SHALL OBTAIN AND PAY FOR ALL PERMITS. COPIES OF ALL PERMITS AND INSPECTION REPORTS SHALL BE SUBMITTED TO THE ARCHITECT. APPLICABLE CODES INCLUDE, BUT ARE NOT LIMITED TO:
  - 2019 CALIFORNIA ADMINISTRATIVE CODE (CAC) (PART 1, TITLE 24, CCR) (PART 2, TITLE 24, CCR) 2019 CALIFORNIA BUILDING CODE (CBC) 2019 CALIFORNIA ELECTRICAL CODE (CEC) (PART 3, TITLE 24, CCR) (PART 4, TITLE 24, CCR) 2019 CALIFORNIA MECHANICAL CODE (CMC) 2019 CALIFORNIA PLUMBING CODE (CPC) (PART 5, TITLE 24, CCR) (PART 6, TITLE 24, CCR) 2019 CALIFORNIA ENERGY CODE (CEC) 2019 CALIFORNIA FIRE CODE (CFC) (PART 9, TITLE 24, CCR) (PART 11, TITLE 24, CCR) 2019 CALIFORNIA GREEN BUILDING CODE (CGBC) 2019 CALIFORNIA REFERENCED STANDARDS CODE (PART 12, TITLE 24, CCR)
- MATERIALS: ALL MATERIALS, APPLIANCES AND EQUIPMENT SHALL BE OF THE MAKE, BRAND AND QUALITY SPECIFIED. THEY SHALL BE NEW, CLEAN, FREE FROM DEFECTS, AND SHALL BE THE BEST OF THEIR RESPECTIVE KIND.

#### DUCTWORK:

- A. DUCTWORK SHALL BE FABRICATED AND INSTALLED IN ACCORDANCE WITH CALIFORNIA MECHANICAL CODE AND SMACNA STANDARDS.
- B. DUCTWORK SHALL BE GALVANIZED STEEL. GAUGES OF METAL FOR ROUND SPIRAL DUCT SHALL BE AS FOLLOWS. (UNLESS NOTED OTHERWISE ON THE DRAWINGS)

DUCTS	FITTINGS
26 GAUGE	26 GAUGE
24 GAUGE	24 GAUGE
22 GAUGE	20 GAUGE
	26 GAUGE 24 GAUGE

- ROUND AND OVAL SPIRAL DUCTS (FITNESS) SHALL BE CONTINUOUS SPIRAL SEAM UNITS, WITH FACTORY SLIP FITTINGS & COUPLINGS, SECURED WITH SHEET METAL SCREWS OR DRIVE RIVETS.
- C. 24 GAUGE DOUBLE THICKNESS TURNING VANES HELD FIRMLY BY TWO 24 GAUGE 2-1/4" WIDE CRIMPED RAIL ASSEMBLIES SIMILAR TO DURO-DYNE VANE RAIL ASSEMBLIES SHALL BE USED ON ALL 90-DEG. DUCT TURNS.
- D. ALL DUCT JOINTS SHALL BE SEALED AIR TIGHT WITH APPROVED SEALER & DUCT TAPE
- FLEXIBLE DUCT USED FOR CONDITIONED AIR SHALL BE U.L. APPROVED STATE FIRE MARSHALL LISTED NON-COMBUSTIBLE, VINYL COATED, WIRE REINFORCED FIBERGLASS, WITH MAXIMUM CONDUCTANCE OF .30. DUCT SHALL HAVE A MINIMUM LENGTH OF THREE FEET AND A MAXIMUM LENGTH OF FIVE FEET (FOR NON-RESIDENTIAL AREAS). DUCTS SHALL BE INSTALLED FREE OF KINKS & SUPPORTS ON 36" CENTERS WITH 3/4" WIDE STRAP HANGERS. FITTINGS SHALL BE SHEET METAL. JOINTS & CONNECTIONS SHALL BE MADE WITH 1/2" WIDE METAL BANDS WITH NOT LESS THAN 2 SHEET METAL SCREWS EACH.
- DUCT HANGERS SHALL BE ATTACHED TO HORIZONTAL SLABS WITH ANGLE CLIPS SECURED WITH INSERTS, NAILED TO VERTICAL WALLS, BOLTED TO BEAMS & JOISTS, SPACED BETWEEN SPANCRETE SECTION, HUNG 3/8" REBAR 6" LONG ABOVE THE METAL BAR AND/OR AS APPROVED BY THE ARCHITECT.
- DUCTWORK SHALL COMPLY WITH ACOUSTICAL REQUIREMENTS BASED ON ACOUSTICAL REPORT. MAINLY, ACOUSTICAL LINING LENGTHS SHALL BE MAINTAINED AS SPECIFIED ON THE DRAWINGS. IF ANY FIELD CHANGES NEED TO BE MADE. THE CONTRACTOR SHALL CONSULT THE ENGINEERING OR ARCHITECTURAL TEAM TO VERIFY THAT THE CHANGES WILL COMPLY WITH THE ACOUSTICAL REQUIREMENTS

## DAMPERS:

- A. VOLUME DAMPERS SHALL BE PROVIDED IN EACH BRANCH DUCT TO EACH DIFFUSER AND REGISTER, AND SHALL BE OPPOSED BLADE ADJUSTABLE TYPE.
- B. AS PER SECTION 717.3.2.1 FIRE DAMPER RATINGS, FIRE DAMPERS SHALL HAVE THE MINIMUM FIRE PROTECTION RATING SPECIFIED IN TABLE 717.3.2.1 FOR THE TYPE OF PENETRATION.

TABLE 717.3.2.1	
TYPE OF PENETRATION	MINIMUM DAMPER RATING (HOURS)
LESS THAN 3-HOUR FIRE-RESISTANCE-RATED ASSEMBLIES	1.5
3-HOUR OR GREATER FIRE-RESISTANCE-RATED ASSEMBLIES	3

- AS PER SECTION 717.3.2.2 SMOKE DAMPER RATINGS. SMOKE DAMPER LEAKAGE RATINGS SHALL BE CLASS I OR II. ELEVATED TEMPERATURE RATINGS SHALL NOT BE LESS THAN 250-DEG FAHRENHEIT (121-DEG CELSIUS).
- AS PER SECTION 717.3.2.3 COMBINATION FIRE/SMOKE DAMPER RATINGS, COMBINATION FIRE/SMOKE DAMPERS SHALL HAVE THE MINIMUM FIRE PROTECTION RATING SPECIFIED FOR FIRE DAMPERS IN TABLE 717.3.2.1 FOR THE TYPE OF 10. FILTERS: PENETRATION AND SHALL ALSO HAVE A MINIMUM SMOKE DAMPER RATING AS SPECIFIED IN SECTION 717.3.2.2.
- FIRE DAMPERS TO BE DYNAMIC TYPE.
- COMBINATION FIRE SMOKE DAMPERS TO BE ACTIVATED USING DUCT SMOKE DETECTORS WITHIN 5'-0" OF THE DAMPERS. AREA SMOKE DETECTOR MAY BE USED IN LIEU OF THE DUCT SMOKE DETECTOR. PROVIDE DUCT SMOKE DETECTOR FOR COMBINATION FIRE SMOKE DAMPERS.
- MANUAL VOLUME DAMPERS SHALL BE INSTALLED AS A MEANS TO BALANCE AIR FLOW AT ALL DIFFUSERS AND REGISTERS. MANUAL VOLUME DAMPERS SHALL BE FACTORY INSTALLED IN THE AIR DISTRIBUTION AS AN ACCESSORY. WHERE SUCH BRANCH DAMPERS ARE INDICATED, DAMPER BLADES IN FITTINGS SHALL BE 22 GAUGE AND PROVIDED WITH SHAFT AND LOCKING QUADRANT.
- FIRE DAMPERS SHALL BE INSTALLED IN DUCTS PASSING THROUGH FIRE WALLS, AND WHERE SHOWN ON DRAWINGS. THEY SHALL COME COMPLETE WITH FUSIBLE LINK, ECCENTRIC WEIGHT, 16GA. SLEEVE AND CLOSING STOP. ACCESS TO FUSIBLE LINKS SHALL BE PROVIDED THROUGH ACCESS DOORS. DAMPERS SHALL BE CONSTRUCTED IN ACCORDANCE DAMPERS & SMOKE FIRE DAMPERS IN SUCH A MANNER AS TO BE READILY ACCESSIBLE FOR MAINTENANCE & REPAIRS.

I. WHERE DAMPERS ARE REQUIRED TO BE INSTALLED IN INACCESSIBLE LOCATIONS, CONTRACTOR TO PROVIDE CABLE DAMPER ASSEMBLIES, ELECTRONIC DAMPERS OR ALDES CARS II.

- A. PROVIDE HANGERS AND SUPPORTS AS REQUIRED. PLUMBERS TAPE AND WIRE ARE NOT ACCEPTABLE
- B. CONDENSATE PIPING SHALL BE UNDER THE PLUMBING SECTION OF THE SPECIFICATIONS.
- C. ALL PIPING SHALL BE ACOUSTICALLY VIBRATION ISOLATED FROM THE STRUCTURE USING HUBBARD HOLDRITE SILENCER SERIES FELT 100 OR EQUAL. THE FELT WILL NOT BE CRUSHED. NEOPRENE PADS WILL BE USED AT CLAMP LOCATIONS. THEY SHALL BE EQUAL TO HUBBARD HOLDRITE SILENCER SERIES 276.

#### 7. INSULATION:

- A. INSULATION SHALL BE U.L. LISTED IN COMPLIANCE WITH FLAME-SPREAD RATING AND SMOKE DENSITY REQUIREMENTS OF THE CALIFORNIA BUILDING CODE. INSTALLATION SHALL BE IN ACCORDANCE WITH THE STATE OF CALIFORNIA ENERGY COMMISSION REQUIREMENTS.
- B. INSULATE ALL INTERIOR CONDITIONED SUPPLY & RETURN AIR DUCTWORK WITH 2" THICK, 75LB. PER CU. FT. DENSITY FIBERGLASS INSULATION WITH VAPOR BARRIER (R-8 MINIMUM).
- C. CONDENSATE PIPING SHALL BE INSULATED WITH 1" FOAM PLASTIC AND PAINTED TO MATCH EXISTING WALL OR CEILING. 16. ANCHORING/BRACING:
- D. THICKNESS OF INSULATION SHALL BE IN ACCORDANCE WITH T24 REQUIREMENTS.
- E. WHERE INSULATION IS EXPOSED TO WEATHER. INSULATION SHALL BE ENCAPSULATED WITH A UV PROTECTIVE COVERING, (CHILDERS ALUMINUMJACKET, OR EQUAL).
- F. COVER ALL JOINTS & CRACKS OF PLENUMS LINING WITH 4" STRIPS OF 6 OUNCE FIBERGLASS, ATTACHED WITH ARABOL ADHESIVE.
- G. ALL REFRIGERATION SUCTION AND LIQUID PIPING SHALL BE INSULATED IN ACCORDANCE WITH THE MANUFACTURER'S INSTALLATION INSTRUCTIONS, ASA APPLICABLE, CONTRACTOR SHALL VERIFY INSULATION REQUIREMENTS PRIOR TO INSTALLATION OF ANY PIPING SYSTEMS.
- H. FIRE BARRIER DUCT WRAP MUST BE APPROVED FOR FIRE RESISTIVE VENTILATION DUCTS SUCH AS 3M DUCT WRAP 615+ (LARR# 26061-T) OR EQUAL.
- INSULATION MATERIAL SHALL MEET THE CALIFORNIA QUALITY STANDARD PER SEC. 110.8 ENERGY EFFICIENCY STANDARDS (E.E.S)
- J. ALL PIPING AND DUCTWORK SHALL BE INSULATED CONSISTENT WITH THE REQUIREMENTS OF SEC. 120.3, 120.4 AND 120.7 TITLE 24 ENERGY STANDARDS AND CHAPTER 6 OF CMC.

## REFRIGERANT PIPING

- A. UNLESS OTHERWISE INDICATED, MAIN LIQUID AND SUCTION LINES FROM CONDENSING UNIT TO EVAPORATOR COIL SHALL BE OF SIZES SPECIFIED BY THE MANUFACTURER.
- B. REFRIGERATION PIPING SHALL BE REFRIGERATION GRADE COPPER TUBING, TYPE L HARD-DRAWN. IN INSTANCES WHERE REFRIGERATION LINES ARE INSTALLED IN AN INACCESSIBLE LOCATION AND MUST BE SNAKED THROUGH CONDUIT, THAT PORTION OF TUBING REQUIRED TO COMPLETE CONNECTIONS THROUGH CONDUIT MAY BE ANNEALED. MAINTAIN ENTIRE SYSTEM CLEAN AND DRY DURING INSTALLATION. PIPE SHALL BE SEALED UNTIL INSTALLED.
- C. REFRIGERATION PIPING. BOTH HARD AND ANNEALED. SHALL BE STRAIGHT AND FREE FROM KINKS. RESTRICTIONS AND HORIZONTAL RUNS SHALL BE SLOPED TOWARDS COMPRESSOR ONE INCH TO 10 FEET WHEREVER POSSIBLE. VAPOR LINE OIL TRAPS SHALL BE INSTALLED ON BOTTOM OF VERTICAL RISERS AND INVERTED OIL TRAP SHALL BE INSTALLED ON TOP OF VERTICAL RISERS.
- REFRIGERATION PIPING: JOINTS SHALL BE SILVER BRAZED AND LEAK TESTED. FIELD FABRICATED LINES SHALL BE THOROUGHLY FLUSHED AND CLEANED BEFORE CONNECTION. BLEED NITROGEN THROUGH LINES DURING SILVER BRAZING, AND CAP AND SEAL LINES WHEN NOT COMPLETED AND CONNECTED TO EQUIPMENT.
- E. SLEEVE PENETRATIONS OF FLOORS, WALLS AND CEILING TO ALLOW FOR FREE MOTION OF PIPING. PROVIDE 24 GAGE GALVANIZED IRON PIPE AND CHROME-PLATED ESCUTCHEON PLATES. PACK ANNULAR SPACE BETWEEN PIPE AND SLEEVE WITH INCOMBUSTIBLE MATERIAL SUCH AS FIBERGLASS AND SEAL EACH END WITH MASTIC TO PROVIDE A WATERPROOF SEAL.
- F. PROVIDE HANGERS AND SUPPORTS AS REQUIRED. PLUMBERS TAPE AND WIRE ARE NOT ACCEPTABLE.
- G. CONDENSATE PIPING SHALL BE UNDER THE PLUMBING SECTION OF SPECIFICATIONS.

## 9. FLASHING:

- A. PROVIDE WATERTIGHT SOLDERED SHEET METAL FLASHING AT ALL NEW & EXISTING WALL AND ROOF OPENINGS.
- B. ALL CONDUIT & PIPES PASSING THRU THE ROOF OPENING SHALL BE FLASHED AND COUNTER FLASHED WITH ACCORDANCE TO ARCHITECTURAL DETAILS.
- C. ALL VOIDS AROUND DUCT PENETRATIONS THRU FLOORS, WALLS & CEILINGS SHALL BE PROPERLY SEALED.

- A. FILTERS SHALL BE U.L. APPROVED AND SHALL HAVE A MINIMUM MERV RATING OF 13 AS TO SATISFY CONDITIONS OF USE 30. GUARANTEE: CONTRACTOR SHALL UNCONDITIONALLY GUARANTEE ALL LABOR & MATERIAL ON ALL WORK AGAINST DEFECTS IN
- CONTROL PANEL OF THE UNIT THAT SIGNALS WHEN FILTER NEEDS TO BE REPLACED.
- C. CONTRACTOR SHALL PROVIDE AN INITIAL SET OF PRE FILTERS, REPLACE AS REQUIRED DURING CONSTRUCTION, AND 32. DRAWINGS: THESE PLANS ARE ENGINEERING DRAWINGS, ARE DIAGRAMMATIC IN NATURE AND INTENDED TO ILLUSTRATE ALL SHALL INSTALL ANOTHER SET OF FILTERS AT THE BEGINNING OF TESTING & BALANCING.
- DAMPERS IN BRANCH DUCTS SHALL NOT BE USED UNLESS SPECIFICALLY NOTED OTHERWISE AND FULLY ACCESSIBLE. 11. THE TERMINATION POINT FOR EXHAUST DUCTS DISCHARGING TO ATMOSPHERE SHALL NOT BE LESS THAN THE FOLLOWING:
  - A. ENVIRONMENTAL AIR: 3 FT. FROM PROPERTY LINE, 3 FT. FROM BUILDING OPENINGS.
  - B. PRODUCT CONVEYING CLASS 1: 10 FT. FROM PROPERTY LINE, 10 FEET FROM BUILDING OPENINGS, 3 FT. FROM EXTERIOR WALL OR ROOF, AND 10 FT. ABOVE ADJOINING GRADE.
- WITH NFPA 90A REQUIREMENTS AND SHALL BE APPROVED FOR USE BY THE STATE FIRE MARSHALL. INSTALL FIRE 12. ALL PLUMBING AND APPLIANCE VENTS AND THE DISCHARGE OUTLET OF EXHAUST FANS SHALL BE AT LEAST TEN(10) FEET IN A HORIZONTAL DIRECTION, OR THREE(3) FEET ABOVE THE OUTSIDE AIR INTAKES FOR HVAC UNITS. OUTSIDE AIR INTAKES SHALL

BE PROVIDED WITH MEANS TO PREVENT THE INTRUSION OF RAIN AND WILDLIFE, (45° ANGLED INTAKE HOOD WITH 1/4" HARDWARE CLOTH WHERE APPLICABLE).

#### 13. ELECTRICAL

- A. FURNISH AND INSTALL ALL LINE AND LOW VOLTAGE CONDUIT AND LINE VOLTAGE WIRING.
- B. FURNISH AND INSTALL ALL REQUIRED RELAYS, CONTACTORS, MAGNETIC MOTOR STARTERS, CIRCUIT BREAKERS. FUSES, DISCONNECT SWITCHES, WALL SWITCHES, LINE VOLTAGE, THERMOSTATS AND VARIABLE FREQUENCY DRIVES,
- C. ELECTRICAL CONTRACTOR TO REVIEW MECHANICAL CONTROL REQUIREMENTS WITH THE MECHANICAL AND GENERAL CONTRACTORS AND COORDINATE RESPECTIVE RESPONSIBILITIES.
- 14. ACCESS DOORS: WHERE NECESSARY IN DUCTWORK OR CASINGS. SUITABLE ACCESS DOORS AND FRAMES TO PERMIT INSPECTION, OPERATION AND MAINTENANCE OF ALL CONTROLS MOTOR BEARINGS, OR OTHER APPARATUS CONCEALED BEHIND THE SHEET METAL WORK SHALL BE PROVIDED. ACCESS DOORS IN DUCTS MAY BE OF SINGLE PANEL CONSTRUCTION OF NOT LESS THAN NO. 18 GAUGE, GALVANIZED, AND SHALL HAVE SPONGE RUBBER GASKETS WITH HINGES AND LATCHES.
- 15. PAINTING: CONTRACTOR SHALL PAINT ALL BLACK STEEL EQUIPMENT SURFACES WHICH ARE NOT FACTORY FINISHED, AS WELL AS ALL OTHER STEEL SURFACES EXPOSED TO THE WEATHER. PAINTING SHALL CONSIST OF ONE COAT OF METAL PRIMER AND ONE FINISH COAT THAT SHALL BE APPROVED BY THE ARCHITECT.

- A. PIPING, DUCTWORK, AND ELECTRICAL DISTRIBUTION SYSTEMS SHALL BE BRACED TO COMPLY WITH THE FORCES AND DISPLACEMENTS PRESCRIBED IN ASCE 7-16 SECTION 13.3 AS DEFINED IN ASCE 7-16 SECTIONS 13.6.5, 13.6.6, 13.6.7, AND 2019 CBC SECTIONS 1616A.1.24, 1616A.1.25 AND 1616A.1.26.
- B. EACH PIECE OF EQUIPMENT AND ALL SYSTEMS SHALL BE ADJUSTED/READJUSTED TO INSURE PROPER NOISE/VIBRATION
- C. THE STRUCTURAL ENGINEER OF RECORD SHALL VERIFY THE ADEQUACY OF THE STRUCTURE TO SUPPORT THE HANGER AND BRACE LOADS. FOR THOSE ELEMENTS THAT DO NOT REQUIRE DETAILS ON THE APPROVED DRAWINGS, THE INSTALLATION SHALL BE SUBJECT TO THE APPROVAL OF THE STRUCTURAL ENGINEER OF RECORD.
- 17. FINAL LOCATION OF CEILING DIFFUSERS SHALL BE PER THE REFLECTED CEILING PLAN OR AS PER FIELD REQUIREMENTS.
- 18. A MINIMUM OF 30" CLEAR WORKING SPACE IN FRONT OF ACCESS PANELS TO THE COMPRESSOR, BLOWER ASSEMBLY AND AIR FILTER SECTION SHALL BE PROVIDED.
- 19. OPENINGS: FURNISH INFORMATION TO THE OTHER TRADES ON SIZE AND LOCATION OF OPENINGS WHICH ARE REQUIRED IN WALLS, SLABS, ETC, FOR PIPING, DUCTS & EQUIPMENT. ANY ADDITIONAL OPENINGS OR CHANGES TO THE EXISTING ONES SHALL BE PROVIDED AS ACCEPTABLE TO THE ENGINEER, AT NO ADDITIONAL COST TO THE OWNER.

#### 20. ACOUSTICAL NOTES:

- A. APARTMENT FCU VIBRATION ISOLATION SHALL BE USING A MASON INDUSTRY TYPE HMIB GROMMET. REFERENCE DETA #6/M-5.1 FOR FAN COIL UNIT INSTALLATION.
- B. ROOFTOP CONDENSING UNITS
- 1. ISOLATOR SHALL BE 2 INCH DEFLECTION STEEL SPRING EQUAL TO MASON SSLFH AND THE CEILING IN THE UNIT SHALL INCLUDE RESILIENT CHANNEL. REFERENCE DETAIL #1/M-5.1 FOR CONDENSING UNIT INSTALLATION.
- C. FLEXIBLE CONNECTIONS SHOULD BE USED AT ALL CONNECTIONS TO MECHANICAL EQUIPMENT IF APPLICABLE.
- D. TOILET EXHAUST FANS' MAXIMUM SONE LEVEL OF 1.5 SONES.
- 21. THE AUTOMATIC CARBON MONOXIDE SENSING DEVICES SHALL BE USED TO MODULATED THE VENTILATION SYSTEM TO MAINTAIN A MAXIMUM AVERAGE CONCENTRATION OF CARBON MONOXIDE OF 50 PARTS PER MILLION DURING ANY EIGHT-HOUR PERIOD WITH A MAXIMUM CONCENTRATION NOT GREATER THAN 200 PARTS PER MILLION FOR A PERIOD NOT EXCEEDING ONE
- 22. DRYER VENTS SHALL BE EQUIPPED WITH BACK-DRAFT DAMPERS PER SEC. 504.1.1 CMC
- 23. FLEXIBLE CLOTHES DRYER TRANSITION DUCTS SHALL NOT BE CONCEALED WITHIN CONSTRUCTION PER SEC. 504.4.2.2 CMC
- 24. DOORS AND WINDOWS SHALL MEET THE MINIMUM INFILTRATION REQUIREMENTS PER SEC. 110.6 AND 110.7 E.E.S.
- 25. ALL HVAC SYSTEMS SHALL MEET THE CONTROL REQUIREMENTS PER SEC. 110.2 AND 120.2 E.E.S.
- 26. ALL HVAC EQUIPMENT AND APPLIANCES SHALL MET THE REQUIREMENTS PER SEC. 110.1-110.3, 110.5, 120.1-120.4 TITLE 24 ENERGY STANDARDS.
- 27. ALL EQUIPMENT SHALL BE INSTALLED PER MANUFACTURER'S RECOMMENDATION.
- 28. ALL FANS SYSTEMS, REGARDLESS OF VOLUMETRIC CAPACITY, THAT EXCHANGE AIR BETWEEN THE BUILDING CONDITIONED SPACE AND THE OUTSIDE OF THE BUILDING SHALL BE PROVIDED WITH BACKDRAFT OR AUTOMATIC DAMPERS TO PREVENT UNINTENDED AIR LEAKAGE THROUGH THE FAN SYSTEM WHEN THE FAN SYSTEM IS NOT OPERATING. (CCR TITLE 24 PART 6 SUBCHAPTER 7 SECTION 150.0(m)7). EXCEPTION: FANS THAT RUN CONTINUOUSLY.
- 29. CONTRACTOR SHALL PROVIDE A COMPLETE SET OF AS-BUILTS TRANSPARENCIES WITH ALL CHANGES NOTED THEREON AT THE COMPLETION OF THE PROJECT AND PRIOR TO FINAL ACCEPTANCE.
- WORKMANSHIP AND MATERIAL FOR PERIOD OF ONE YEAR, 10 YEAR COMPRESSOR.
- B. FILTERS SHALL BE PROVIDED WITH AN INTEGRATED PRESSURE DROP SENSOR WIRED TO A WARNING LIGHT ON THE 31. SUBMITTALS: CATALOG INFORMATION AND CUTS OF ALL MECHANICAL EQUIPMENT AND DEVICES SHALL BE SUBMITTED FOR REVIEW PRIOR TO ORDERING (SIX COPIES OF EACH) IN ONE COMPLETE PACKAGE.
  - REQUIRED SYSTEMS AND COMPONENTS INCLUDING THEIR RESPECTIVE INSTALLATION REQUIREMENTS. CONTRACTOR SHALL PROVIDE THEIR OWN SHOP DRAWINGS DELINEATING ALL SPECIFIC REQUIREMENTS FOR THE COMPLETION OF THIS INSTALLTION, CONSISTENT WITH THE INTENT OF THE ENGINEERED DRAWINGS.
  - 33. ALL ENVELOPE AND MECHANICAL CERTIFICATE OF ACCEPTANCE FORMS AND ALL RELATED ACCEPTANCE DOCUMENTS SHALL BE SUBMITTED TO THE FIELD INSPECTOR DURING CONSTRUCTION. CERTIFICATE OF OCCUPANCY WILL NOT BE ISSUED UNTIL THESE FORMS ARE REVIEWED AND APPROVED.

1	SYMBOL	ABBR	DESCRIPT	.IUN	
	12"x6" 12x6	ADDIX	NEW DUCTWORK - FIRST FIG SECOND FIGURE: SID	URE: SIDE SHOWN	
			NEW DUCTWORK WITH EXTE	RNAL INSULATION	
,		(L)	DUCTWORK WITH INTERNAL	ACOUSTICAL LINING	
			FLEX CONNECTION IN DUCT		
			DUCT SIZE TRANSITION		
			ROUND VERTICAL RISE OR D	ROP	
.L D			RECTANGULAR VERTICAL RIS	SE OR DROP	
ט			VERTICAL TAKE OFF UP		
			VERTICAL TAKE OFF DOWN		
)			ROUND DUCT 90 DEGREE RA	DIUS ELBOW	
NC			ROUND DUCT CONICAL 90 DE	GREE TAKE OFF	
ER			ROUND DUCT 45 DEGREE RA	DIUS ELBOW	
			RECTANGULAR DUCT 90 DEG ELBOW WITH EXTRACTION D		
₹			RECTANGULAR DUCT ANGLE	TAKE OFF	
		MD	MANUAL VOLUME DAMPER		
	$\bowtie \frac{S-1}{100}$		RECTANGULAR CEILING DIFFUSER (TYPE S-1, 100 CFM) SUPPLY AIR		
AIL	$- \downarrow \longrightarrow \frac{S-1}{100}$		SIDEWALL DIFFUSER SUPPLY AIR		
•			CEILING REGISTER/GRILLE (F EXHAUST AIR)	RETURN AIR OR	
\LL	$- \downarrow \leftarrow \frac{R-1}{100}$		SIDEWALL REGISTER/GRILLE EXHAUST AIR)	(RETURN AIR OR	
	<del>-U&gt;</del>	U/C	UNDERCUT DOOR		
	T	Т	TOP OF THERMOSTAT MOUN	TED AT 48" A.F.F.	
R	FC 1		EQUIPMENT IDENTIFICATION		
	(5)		STACK, VENT OR ROUND DU	CT RISER	
			CLOSET FAN COIL UNIT/CEILI	NG FAN COIL UNIT	
	Ž.		CEILING MOUNTED BATHROOM EXHAUST FAN		
	<del>\</del>		KITCHEN HOOD		
	MECHANICA	L SHE	ET INDEX		
	SHEET NO. SHEET		CURRENT ISSUE		

MECHANICAL SYMBOLS LEGEND

MECHANICAL SHEET INDEX								
IEET NO.	SHEET TITLE	CURRENT ISSUE						
M0.01	MECHANICAL GENERAL NOTES, SYMBOLS LEGEND & SHEET INDEX	DSA BACK-CHECK						
M0.02	MECHANICAL SCHEDULES & CALCULATIONS	DSA BACK-CHECK						
M2.01	MECHANICAL BUNGALOW FLOOR PLANS	DSA BACK-CHECK						
M5.01	MECHANICAL DETAILS - SHEET ONE	DSA BACK-CHECK						
EN.01	TITLE 24 COMPLIANCE FORMS	DSA BACK-CHECK						

DRAWN BY DESIGNED BY

CHECKED BY APPROVED BY

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## abode communities

## LAEP EARLY CHILDHOOD CENTER

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SHEET NAME:

MECHANICAL GENERAL NOTES. SYMBOLS LEGEND & SHEET INDEX

SHEET NUMBER:

	EXISTING EXTERIOR WALL-MOUNT HEAT PUMP SCHEDULE (DUCTED)														
	OTY	COOLING CAPACITY		HEATING BLOWER		1	ELECTRICAL DATA			WEIGHT					
MARK	QIY.	MAKE	MODEL	NOMINAL BTUH	SENSIBLE BTUH	SEER/EER	CAPACITY BTUH	CFM ES	SP. (IN. WC)	POWER	VOLT	PH FLA	SERVICE	(LBS)	REMARKS
(E)HP-1	4	BARD	T60H2-A05TP4XXE	60,500	45,375	-/11.0	56,000	1250	0.2	-	208/230	1 1.5	BUNGALOW ROOMS	575	EXISTING EXTERIOR WALL-MOUNT HEAT PUMP TO REMAIN. SET MINIMUM ECONOMIZER POSITION TO 20%.

	FAN SCHEDULE													
MADK	OTY	MAKE	MODEL	FAN TYPE	TOTAL CFM	ESP (IN)	MAX. RPM		MOTOR DATA			SERVICE	WEIGHT	REMARKS
IVIARK	QII.	IVIANE	WODEL	FANTIFE	TOTAL CEW	201 (114)	IVIAA. KPIVI	POWER	AMPS	V	PH	SERVICE	(LBS)	REWARRS
EF-1	6	GREENHECK	SP-A110	DIRECT DRIVE	70	0.29	950	17.0	ı	115	1	CHILD AND ADULT RESTROOMS, LAUNDRY ROOM	17	FAN SHALL BE ENERGY STAR COMPLIANT. PROVIDE WITH BACKDRAFT DAMPER. INTERLOCK WITH LIGHTSWITCH. REFER TO #4/M-5.01 FOR EXHAUST FAN DETAIL.
EF-2	1	AIRKING	ES308ADA	DIRECT DRIVE	150-270	0.1	1,653	73.0	1.0	120	1	KITCHEN	-	FAN SHALL BE ADA COMPLIANT WITH ADA COMPLIANT WALL SWITCH. PROVIDE WITH BACKDRAFT DAMPER.

	AIR DISTRIBUTION SCHEDULE												
MARK	MARK QTY. MAKE MODEL CFM RANGE USE TYPE SIZE (IN) MAX PD (IN) MAX NC									REMARKS			
(E)S	8	EXISTING	EXISTING	150-1200	SA	PERFORATED FACE DIFFUSER	24"X24"	-	-				
(E)R	4	EXISTING	EXISTING	0-1650	RA	LOUVERED RETURN GRILLE	30"X12"	-	-	NEOK OLZE DED DI ANI DEEED TO #4/M E 04 FOR OFILINO DIEFLIOED WITH ELEV CONNECTION OUDDON'T DETAIL			
S-1	1	PRICE	APDN	0-300	SA	PERFORATED FACE DIFFUSER	24"X24"	0.033	20	NECK SIZE PER PLAN. REFER TO #1/M-5.01 FOR CEILING DIFFUSER WITH FLEX CONNECTION SUPPORT DETAIL.			
T-1	8	PRICE	ATGH	0-600	RA	PERFORATED FACE DIFFUSER	24"X22"	0.039	15				

	RE	QUIRED VENTILATION R USING AREA ME	REQUIRED VENTIL EFFICIENCY STANDA	<sup>1</sup> ACTUAL CFM						
ROOM NAME	FLOOR	RP (CFM/OCC.)	OCC./1000FT <sup>2</sup> (PZ)	RA (CFM/FT <sup>2</sup> )	AZ (FT <sup>2</sup> )	MIN. CFM (VBZ)	RA (CFM/FT <sup>2</sup> )	AZ (FT <sup>2</sup> )	MIN. CFM (VZ)	
CLASSROOM 1	1/F	10	25	0.12	385	142	0.38	385	146.3	150
CLASSROOM 2	1/F	10	25	0.12	385	142	0.38	385	146.3	150
CLASSROOM 3	1/F	10	25	0.12	471	174	0.38	471	179.0	180
CLASSROOM 4	1/F	10	25	0.12	471	174	0.38	471	179.0	180
KITCHEN	1/F	7.5	20	0.12	268	72	0.15	268	40.2	50
WORK A	1/F	5	5	0.06	268	23	0.15	268	40.2	50
CONFERENCE RM	1/F	5	50	0.06	80	25	0.50	80	40.0	50
OFFICE 3	1/F	5	5	0.06	251	21	0.15	251	37.7	40
OFFICE 4	1/F	5	5	0.06	251	21	0.15	251	37.7	40
LAUNDRY ROOM	1/F	5	10	0.12	54	9	0.15	54	8.1	70

## DRYER VENT INSTALLATION NOTES

- THE TERMINATION OF THE DUCT SHALL NOT BE RESTRICTED BY ANY LOUVERS OR SCREENS AND THE FREE AREA OF THE DUCT SHALL NOT BE REDUCED.
- 2. THE DUCT SYSTEM DESIGN SHALL BE SUCH THAT THE FASTENERS WILL NOT OBSTRUCT THE FLOW THRU THE DUCT SYSTEM.
- 3. THE LAP JOINTS ARE TO BE IN THE DIRECTION OF AIR FLOW.
- 4. DUCTS INSTALLED WITHIN A WALL SHALL NOT BE INSTALLED WHERE THE FREE AREA OF THE DUCT WILL BE REDUCED.
- 5. THE DRYER EXHAUST DUCT SHALL NOT EXTEND INTO OR THRU DUCTS OR PLENUMS.

## DRYER VENT SIZING CALCULATION:

MAKE:

MODEL: GFD55ESSN/ESPN (ELECTRIC DRYER)
TYPE 1 DRYER

SERVICE: BUNGALOW 01 LAUNDRY ROOM

FROM DRYER MANUFACTURER:

		Best perfor	mance
A A		Maximum le dia. <b>rigid m</b>	
-4		Exhaust ho	od type
Domestic 2-1/2 dryer models	Number of 90° turns	<b>A</b> 4" opening	<b>B</b> 2-1/2" opening
	0 1 2 3 4	90 ft. 60 ft. 45 ft. 35 ft. 25 ft.	60 ft. 45 ft. 35 ft. 25 ft. 15 ft.

	DRYER VENT LENGTH & ELBOWS FROM DESIGN									
DRYER NO.	DRYER LOCATION	NO. OF 90-DEG ELBOWS	HOR. (FT)	VER. (FT)	TOTAL LENGTH (FT)	DUCT SIZE	BOOSTER FAN REQUIRED (Y/N)			
1 BUNGALOW 01 LAUNDRY 3 5.2 8 13.2 4"Ø N										

DRAWN BY DESIGNED BY CHECKED BY PB
APPROVED BY PB

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SHEET NAME:

MECHANICAL SCHEDULES & CALCULATIONS


SHEET NUMBER:

SCALE:

ELI NOMBEN.

M0.02

NONE

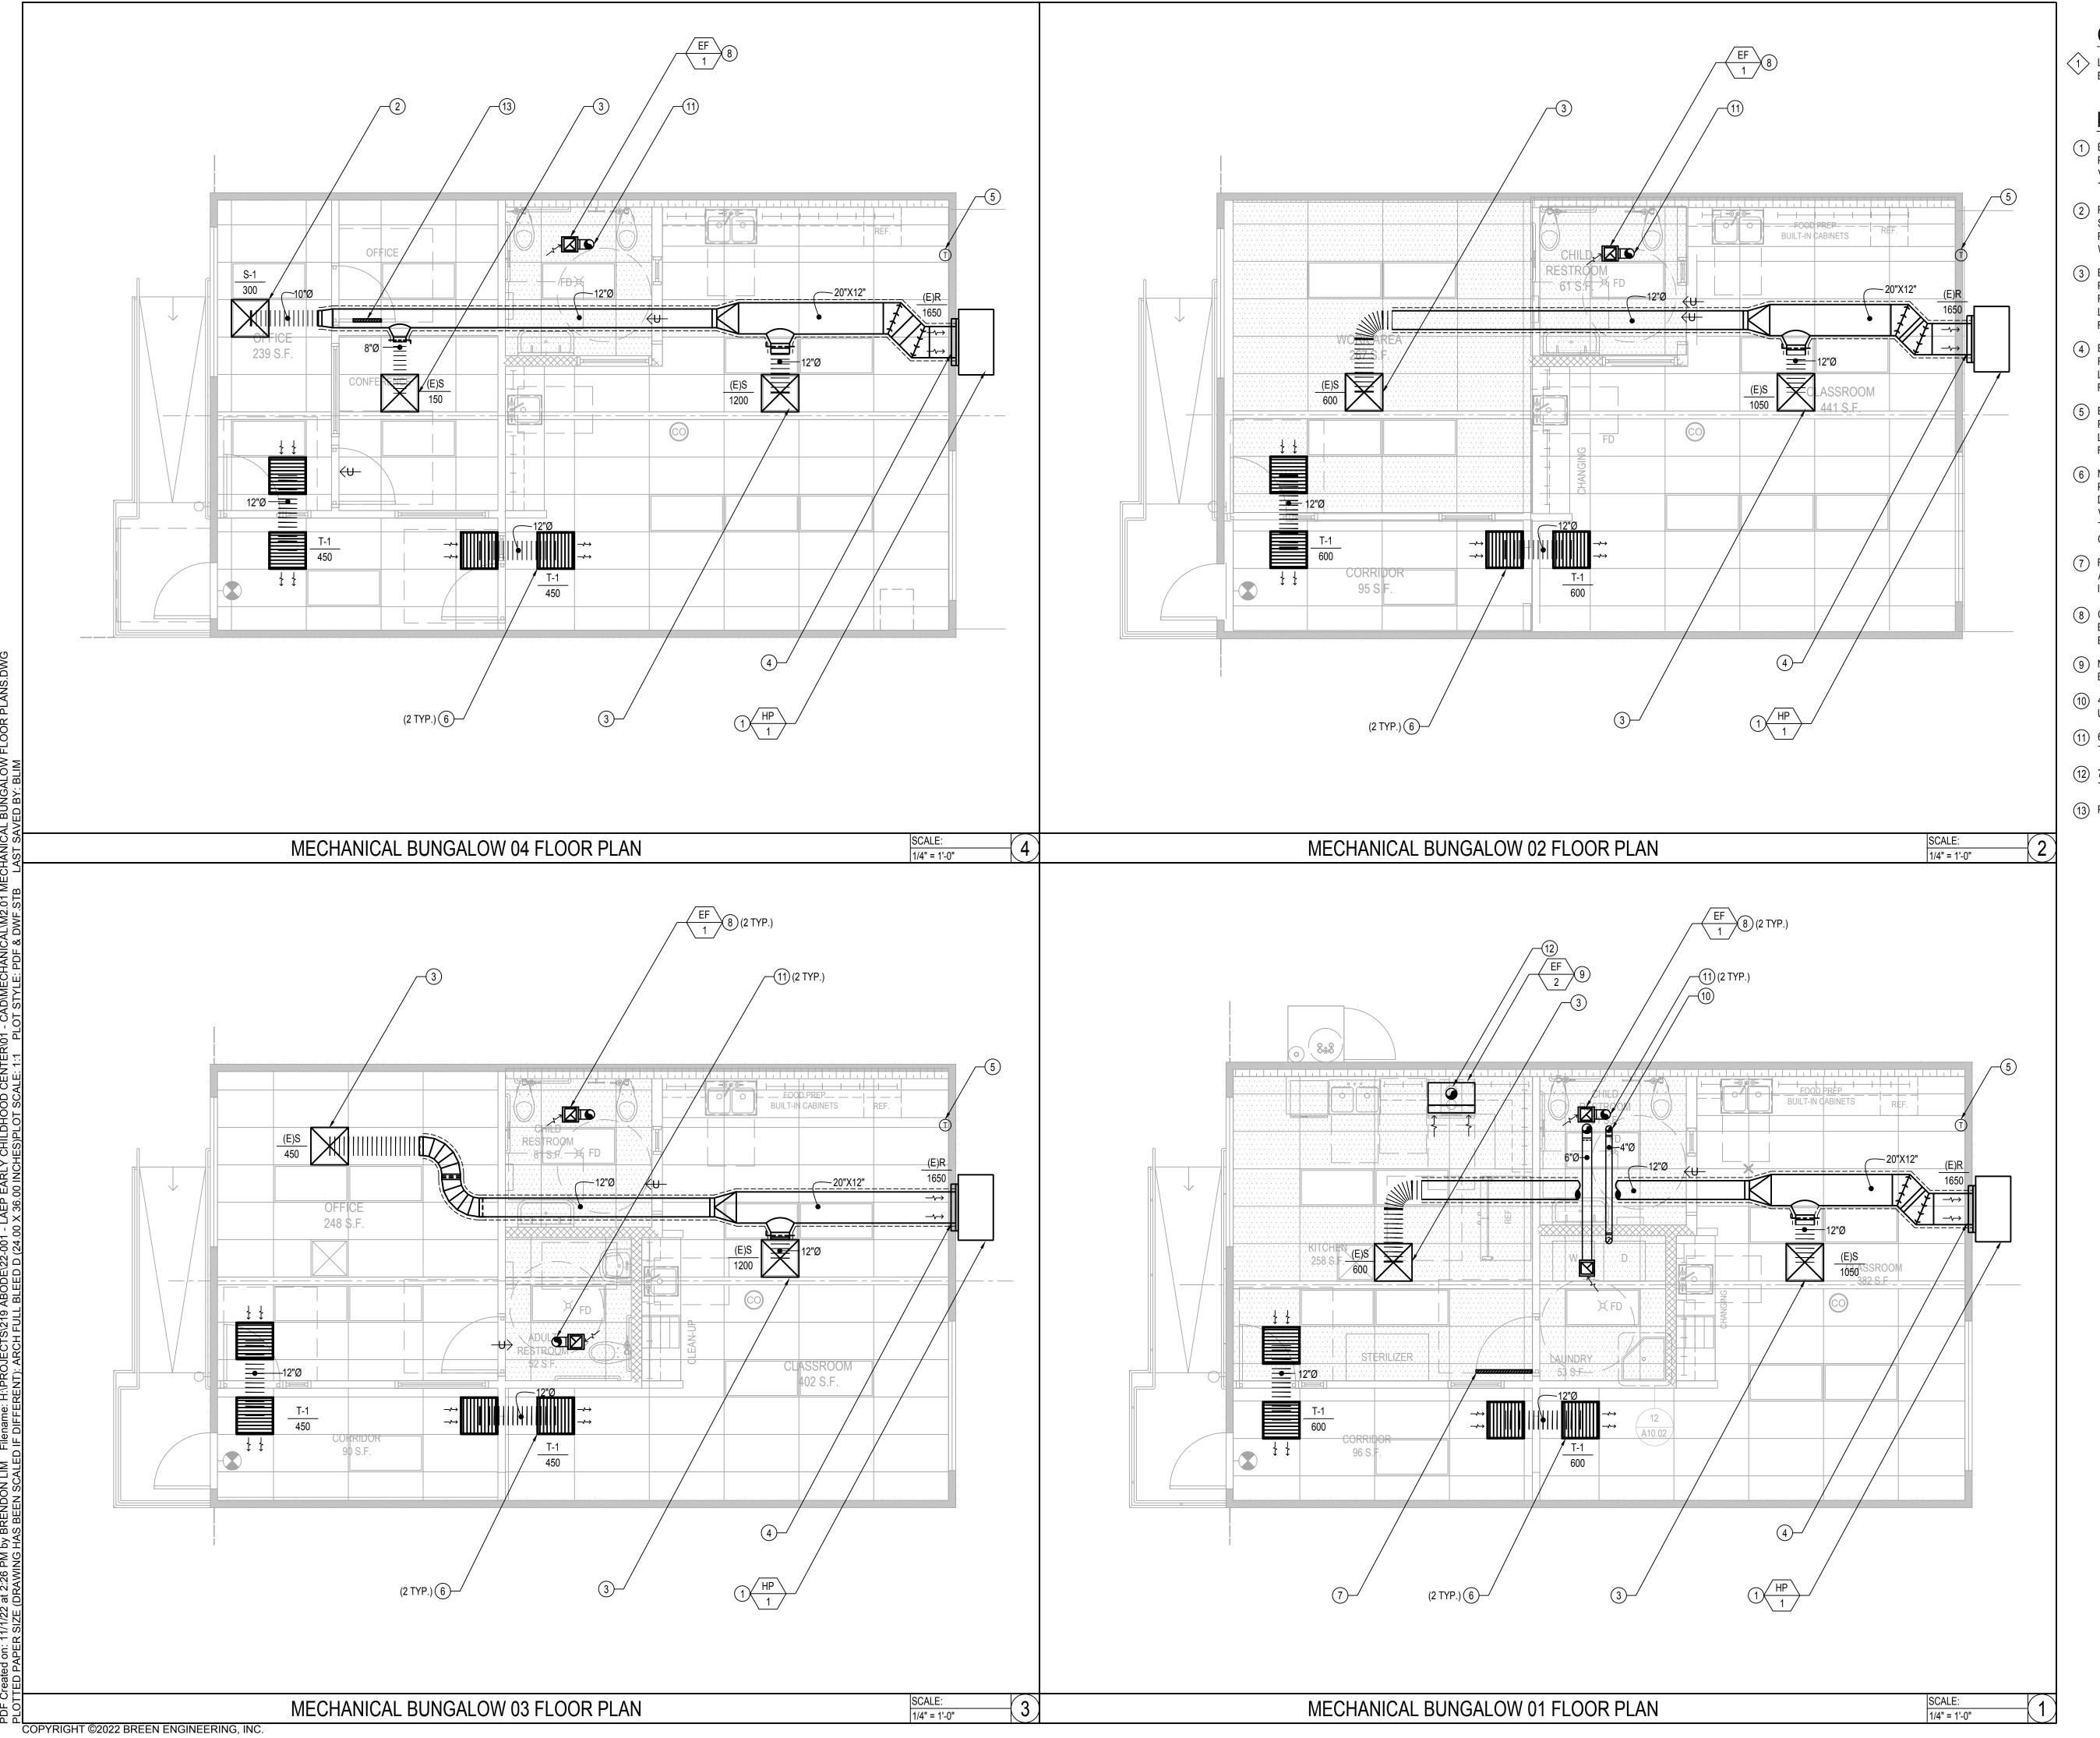

## **GENERAL NOTES**

LOCATE ALL NEW ROOF DUCT PENETRATIONS BETWEEN EXISTING PURLINS.

## REFERENCE NOTES

- 1 EXISTING EXTERIOR WALL-MOUNTED HEAT PUMP UNITS TO REMAIN. CONTRACTOR TO VERIFY EXACT LOCATION IN THE FIELD. REFER TO #6/M5.01 FOR SECTION VIEW DETAIL.
- 2 PROVIDE NEW SUPPLY DIFFUSER. EQUIVALENT SPECS TO EXISTING DIFFUSERS IN SPACE. REFER TO #1/M5.01 FOR CEILING DIFFUSER WITH FLEX CONNECTION SUPPORT DETAIL.
- 3 EXISTING SUPPLY DIFFUSER TO BE RELOCATED. ADJUST DUCTWORK AS REQUIRED. CONTRACTOR TO VERIFY EXACT LOCATION IN THE FIELD. REFER TO #1/M5.01 FOR CEILING DIFFUSER CONNECTION DETAIL.
- 4 EXISTING RETURN GRILLE ON WALL TO REMAIN. CONTRACTOR TO VERIFY EXACT LOCATION IN THE FIELD. REFER TO #6/M5.01 FOR SECTION VIEW DETAIL.
- 5 EXISTING THERMOSTAT AND CONTROLS TO REMAIN. CONTRACTOR TO VERIFY EXACT LOCATION IN THE FIELD. REFER TO #3/M5.01 FOR MOUNTING HEIGHT OBSTRUCTION DETAIL.
- 6 NEW TRANSFER AIR DUCT AND GRILLES.
  PROVIDE EQUIVALENT SPECS TO EXISTING
  DIFFUSERS IN SPACE. CONTRACTOR TO
  VERIFY EXACT LOCATION IN THE FIELD. REFER
  TO #1/M5.01 FOR CEILING DIFFUSER WITH FLEX
  CONNECTION SUPPORT DETAIL.
- 7 FULLY LOUVERED DOOR (120 SQ. IN FREE AREA MINIMUM PER MANUFACTURER INSTALLATION INSTRUCTIONS).
- 8 CEILING MOUNTED EXHAUST FAN. PROVIDE BACKDRAFT DAMPER. REFER TO #4/M-5.01 FOR EXHAUST FAN DETAIL.
- 9 NEW KITCHEN EXHAUST HOOD. PROVIDE BACKDRAFT DAMPER.
- (10) 4"Ø DRYER EXHAUST AIR VENT TO TERMINATE UP THROUGH ROOF.
- 6"Ø EXHAUST AIR DUCT TO TERMINATE UP THROUGH ROOF.
- 7"Ø KITCHEN EXHAUST AIR DUCT TO TERMINATE UP THROUGH ROOF.

DRAWN BY
DESIGNED BY

CHECKED BY

APPROVED BY

13) PROVIDE 18"X12" DOOR LOUVER.

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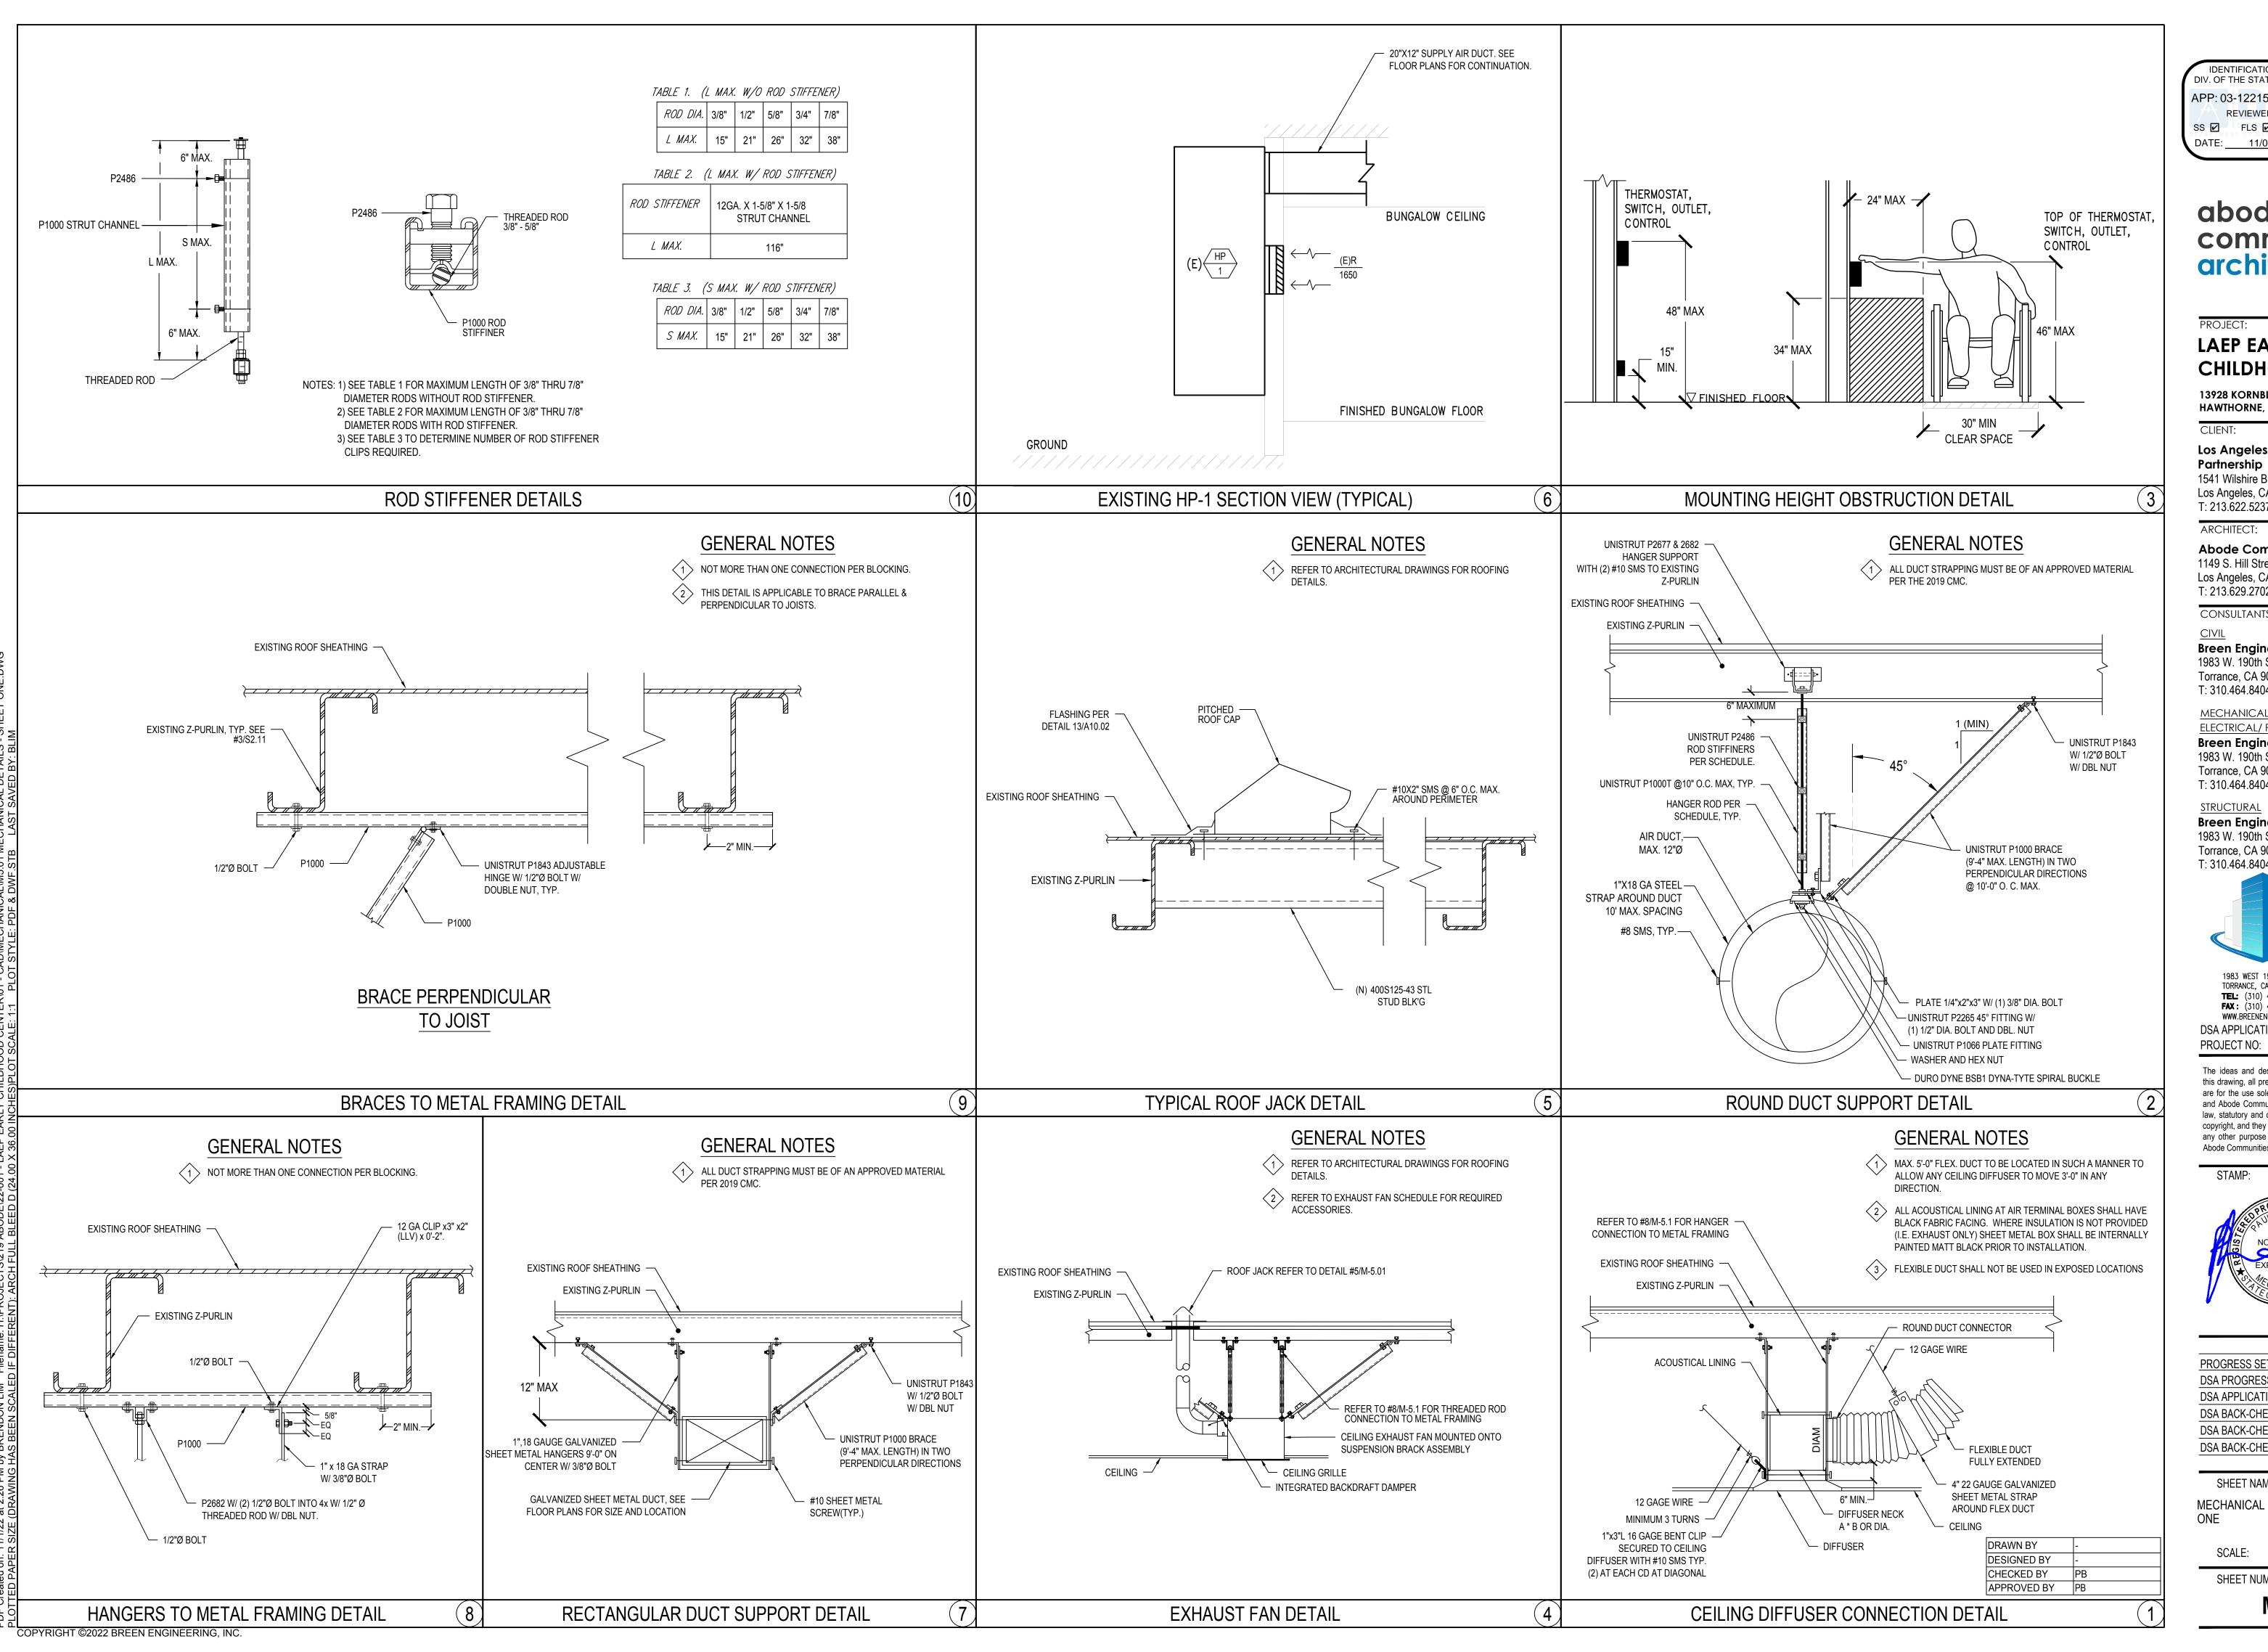
SHEET NAME:

MECHANICAL BUNGALOW FLOOR PLANS

SCALE: AS NOTED

SHEET NUMBER:

M2.01



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WWW.BREENENG.COM DSA APPLICATION NUMBER: 03-122151 219-22-001 PROJECT NO:

The ideas and designs represented herein and this drawing, all prepared by Abode Communities are for the use solely with respect to this project and Abode Communities shall retain all common law, statutory and other reserved rights including copyright, and they shall not be used by others for any other purpose without written permission of Abode Communities | Architecture.

STAMP:



	DATE	REV
PROGRESS SET	02.01.22	
DSA PROGRESS SET	03.02.22	
OSA APPLICATION SET	04.01.22	
DSA BACK-CHECK SET	10.05.22	
DSA BACK-CHECK SET	10.24.22	
DSA BACK-CHECK SET	11.01.22	

SHEET NAME:

MECHANICAL DETAILS - SHEET

SCALE: N.T.S.

SHEET NUMBER:

M5.01

☐ Cooling Air System

or new)

STATE OF CALIFORNIA

Mandatory Measures Note Block

STATE OF CALIFORNIA

NRCC-MCH-E CALIFORNIA ENERGY COMMISSIO								
CERTIFICATE OF COMPLIANCE						NRCC-MCH-I		
This document is used to demonstrate of path outlined in §140.4, or §141.0(b)2		nical systems that are within the	scop	e of the permit application	on and are demonstra	ting compliance using the prescriptive		
Project Name:		LAEP Childcare Center	Repor	t Page:		(Page 1 of 6		
Project Address:	13928 KORNBLUM	AVE. HAWTHORNE, CA 90250	Date I	Prepared:		2022-03-29T19:35:13-04:00		
A. GENERAL INFORMATION								
01 Project Location (city)		Hawthorne	04	Total Conditioned Floor	Area	3480		
02 Climate Zone		8	05	Total Unconditioned Flo	or Area	0		
03 Occupancy Types Within Project:			06	# of Stories (Habitable Above Grade)		1		
☐ Office (B)	☐ Retail (	M)		□ Non-refrigerated Warehouse (S)				
☐ Hotel/ Motel Guest Rooms (R-1)		(E)		Healthcare Facility (I)				
☐ High-Rise Residential (R-2/R-3)	☐ Relocat	table Class Bldg (E)		☑ Other (write in) Classroom Buildin		Classroom Building;		
	•							
B. PROJECT SCOPE								
This table Includes mechanical systems or components that are within the scope of the permit application and are demonstrating compliance using the prescriptive path outlined in \$140.4, or \$141.0(b)2 for alterations.								
01	02	2	_		03			
Air System(s)	Air System(s)			onents	Dry System Components			
☐ Heating Air System ☐ Water Economizer					☐ Air Econ	omizer		

System Piping

☐ Cooling Towers

☐ Electric Resistance Heat

☐ Zonal Systems/ Terminal Boxes

☑ Ductwork (existing to remain, altered or new)

☐ Fan Systems

Registration Number:	Registration Date/Time:	Registration Provider: Energy Code Ace
CA Building Energy Efficiency Standards - 2019 Nonresidential Compliance	Report Version: 2019.1.003 Schema Version: rev 20200601	Report Generated: 2022-03-29 16:35:25

Mechanical Systems							
NRCC-MCH-E	CALIFORNIA ENERGY COMMISSION						
CERTIFICATE OF COMPLIANCE				NRCC-MCH-E			
Project Name:	LAEP Childca	e Center	Report Page:	(Page 5 of 6)			
Project Address:	13928 KORNBLUM AVE. HAWTHORNE, C.	4 90250	Date Prepared:	2022-03-29T19:35:13-04:00			
Q. MANDATORY MEASURES DOCUMENTATION LOCATION							
This table is used to indicate where mandatory measures are documented in the plan set or construction documentation.							
	01		02				
Compliance with Mandator	empliance with Mandatory Measures decumented through MCL						

Registration Number:	Registration Date/Time:	Registration Provider: Energy Code A
CA Building Energy Efficiency Standards - 2019 Nonresidential Compliance	Report Version: 2019.1.003 Schema Version: rev 20200601	Report Generated: 2022-03-29 16:35:

## Space Conditioning Mandatory Measures:

- 120.4(b) DUCT AND PLENUM MATERIALS 120.4(b) FACTORY-FABRICATED DUCT SYSTEMS MUST:
- COMPLY WITH UL 181 FOR DUCTS AND CLOSURE SYSTEMS AND BE LABELED AS COMPLYING WITH UL 181 • ALL PRESSURE SENSITIVE TAPES, HEAT ACTIVATED TAPES, AND MASTICS USED IN MANUFACTURE OF RIGID FIBERGLASS DUCTS SHALL COMPLY WITH UL 181 AND
- ALL PRESSURE SENSITIVE TAPES, AND MASTICS USED IN MANUFACTURE OF FLEXIBLE DUCTS SHALL COMPLY WITH UL 181 AND L 181B
- JOINTS AND SEAMS SHALL NOT BE SEALED WITH CLOTH BACK RUBBER ADHESIVE DUCT TAPES UNLESS COMBINED WITH MASTICS AND DRAWBANDS.
- FACTORY-MADE RIGID FIBERGLASS AND FLEXIBLE DUCTS FOR FIELD-FABRICATED DUCT SYSTEMS SHALL COMPLY WITH UL 181. ALL CLOSURE SYSTEMS, INCLUDING PRESSURE SENSITIVE TAPES, MASTICS, AND AEROSOL SEALANTS, SHALL MEET THE APPLICABLE REQUIREMENTS OF UL 181, UL 181A AND UL 181B.
- MASTIC SEALANTS SHALL: COMPLY WITH APPLICABLE REQUIREMENTS OF UL 181, UL 181A, AND UL 181B AND BE NONTOXIC AND WATER RESISTANT.
- PASS ASTM C731 AND D2202, IF USED IN BUILDING INTERIOR, PASS ASTM C731, C732, AND D2202, IF USED ON EXTERIOR.
- SEALANTS AND MESHES SHALL BE RATED FOR EXTERIOR USE.
- PRESSURE SENSITIVE TAPES SHALL COMPLY WITH APPLICABLE REQUIREMENTS IN UL 181, UL 181A, AND UL 181B. • JOINTS AND SEAMS SHALL NOT BE SEALED WITH CLOTH BACK RUBBER ADHESIVE DUCT TAPES UNLESS COMBINED WITH MASTICS AND DRAWBANDS. DRAWBANDS USED WITH FLEXIBLE DUCTS SHALL:
- BE EITHER STAINLESS STEEL WORM-DRIVE HOSE CLAMPS OR UV-RESISTANT NYLON DUCT TIES
- HAVE A MINIMUM TENSILE STRENGTH RATING OF 150 LBS. BE TIGHTENED AS RECOMMENDED BY THE MANUFACTURER
- AEROSOL SEALANT CLOSURES SHALL:
- MEET REQUIREMENTS OF UL 723 AND BE APPLIED ACCORDING TO MANUFACTURER SPECIFICATIONS TAPES OR MASTICS USED IN COMBINATION WITH AEROSOL SEALING SHALL COMPLY WITH APPLICABLE REQUIREMENTS OF UL 181, UL 181A, AND UL 181B, ASTM C731, C732 AND D2202.
- ALL DUCT INSULATION PRODUCT R-VALUES SHALL BE BASED ON INSULATION ONLY AND TESTED IN ACCORDANCE WITH ASTM C518 OR ASTM C177 AND CERTIFIED PER
- INSTALLED THICKNESS OF DUCT INSULATION USED TO DETERMINE ITS R-VALUE SHALL BE DETERMINED AS FOLLOWS:
- DUCT BOARD, LINER, AND FACTORY-MADE RIGIDS: USE NOMINAL INSULATION THICKNESS DUCT WRAP: USE 75% (25% COMPRESSION) OF NOMINAL THICKNESS
- FACTORY-MADE FLEXIBLE AIR DUCTS: DIVIDE THE DIFFERENCE BETWEEN THE ACTUAL OUTSIDE DIAMETER AND NOMINAL INSIDE DIAMETER BY TWO.
- INSULATED FLEXIBLE DUCT PRODUCTS INSTALLED TO MEET THIS REQUIREMENT MUST INCLUDE LABELS (MAX INTERVALS OF 3 FT) SHOWING THERMAL RESISTANCE PERFORMANCE R-VALUE FOR THE DUCT INSULATION ITSELF BASED ON TESTS IN 120.4(c). AND INSTALLED THICKNESS DETERMINED BY 120.4(d)3.

#### STATE OF CALIFORNIA **Mechanical Systems** CERTIFICATE OF COMPLIANCE

D. EXCEPTIONAL CONDITIONS

F. HVAC SYSTEM SUMMARY (DRY & WET SYSTEMS)

CA Building Energy Efficiency Standards - 2019 Nonresidential Compliance

This section does not apply to this project.

Registration Number

City/State/Zip:Torrance, CA 90504

Project Name: LAEP Childcare Center Repo						ort Page	:					(Page 2 of 6)			
Project Address: 13928 KORNBLUM AVE. HAWTHORNE, CA 90250 Date Prepared:											2022	-03-29T19:35:13-04:00			
C. COMPLIANCE RESULTS  Table C will indicate if the project data input into the compliance document is compliant with mechanical requirements. This table is not editable by the user. If this table says "DOES NOT COMPLY" or "COMPLIES with Exceptional Conditions" refer to Table D., or the table indicated as not compliant for quidance.															
01		02		03		04		05		06		07		08	09
System Summary §110.1, §110.2, §140.4	AND	Pumps §140.4(k)	AND	Fans/ Economizers §140.4(c), §140.4(e)	AND	System Controls §110.2, §120.2, §140.4(f)	AND	Ventilation §120.1	AND	Terminal Box Controls §140.4(d)	AND	Distribution §120.3, §140.4(I)	AND	Cooling Towers §110.2(e)2	Compliance Results
(See Table F)		(See Table G)		(See Table H)		(See Table I)		(See Table J)		(See Table K)		(See Table L)		(See Table M)	
	AND		AND		AND		AND	Yes	AND		AND	Yes	AND		COMPLIES with Exceptional Conditions
	Mandatory Measures Compliance (See Table O for Details)									COMP	LIES	·			

This table is auto-filled with uneditable comments because of selections made or data entered in tables throughout the form.					
The permit applicant has indicated on Table J that ventilation calculations have been attached or included elsewhere on the plans.					
E. ADDITIONAL REMARKS					
This table includes remarks made by the permit applicant to the Authority Having Jurisdiction.					

G. PUMPS		
This section does not apply to this project.		
H. FAN SYSTEMS & AIR ECONOMIZERS		
This section does not apply to this project.		

Registration Date/Time:

Report Version: 2019.1.003

	Schema Version: rev 20200601				
LIFORNIA					

STATE OF CALIFORNIA			
Mechanical Systems			
NRCC-MCH-E			CALIFORNIA ENERGY COMMISSION
CERTIFICATE OF COMPLIANCE			NRCC-MCH-E
Project Name:	LAEP Childcare Center	Report Page:	(Page 6 of 6)
Project Address:	13928 KORNBLUM AVE. HAWTHORNE, CA 90250	Date Prepared:	2022-03-29T19:35:13-04:00

_									
	DOCUMENTATION AUTHOR'S DECLARATION STATEMENT								
	I certify that this Certificate of Compliance documentation is accurate and complete.								
	Documentation Author Name: Brendon Lim	Documentation Author Signature:							
	Company: Breen Engineering	Signature Date: 2022-03-29							
	Address: 1983 W 190th St, Suite 200	CEA/ HERS Certification Identification (if applicable):							
	01. (c) . (7) T	DI 040 404 0404							

- Phone: 310.464.8404 RESPONSIBLE PERSON'S DECLARATION STATEMENT rtify the following under penalty of perjury, under the laws of the State of California: The information provided on this Certificate of Compliance is true and correct.  $\label{eq:complexity} % \begin{subarray}{ll} \end{subarray} \begin{subarray}{ll} \end{subarr$ I am eligible under Division 3 of the Business and Professions Code to accept responsibility for the building design or system design identified on this Certificate of Compliance (responsible designer)
- The energy features and performance specifications, materials, components, and manufactured devices for the building design or system design identified on this Certificate of Compliance conform to the re of Title 24, Part 1 and Part 6 of the California Code of Regulations. The building design features or system design features identified on this Certificate of Compliance are consistent with the information provided on other applicable compliance documents, worksheets, calculations plans and specifications submitted to the enforcement agency for approval with this building permit application.

  I will ensure that a completed signed copy of this Certificate of Compliance shall be made available with the building permit(s) issued for the bui

Phone: 310.464.8404

	signed copy of this Certificate of Compliance is required to b		builder provides to the building owner at occupancy.
Responsible Designer Name: Paul Breen, P.E.		Responsible Designer Signature:	La
Company: Breen Engineering		Date Signed: 2022-03-29	
Address: 1983 W 190th St. Suite 200		License: M_30533	

Registration Number:	Registration Date/Time:	Registration Provider: Energy Code Ace

Report Version: 2019.1.003

Schema Version: rev 20200601

## Space Conditioning Mandatory Measures:

CA Building Energy Efficiency Standards - 2019 Nonresidential Compliance

120.4(f) PROTECTION OF INSULATION INSULATION SHALL BE PROTECTED FROM DAMAGE BY SUNLIGHT, MOISTURE, EQUIPMENT MAINTENANCE AND WIND. CELLULAR FOAM INSULATION SHALL BE PROTECTED, OR BE PAINTED WITH A WATER RETARDANT COATING THAT PROVIDES SHIELDING FROM SOLAR RADIATION.

CERTIFICATE OF C	OMPLIANCE				1-			NRCC-MC
Project Name:				P Childcare Center				(Page 3 o
Project Address:		13928 KOR	NBLUM AVE. HAWTHO	)RNE, CA 90250	Date Prepare	<u>d:</u>	2	:022-03-29T19:35:13-04
. SYSTEM CON								
This section doe	s not apply to	this project.						
VENTII ATIOI	N AND INDO	OR AIR QUALITY						
			andatory ventilation re	auiroments in S	120.1 and 61	20.2(e)3B for all nonresiden	atial high rice recidential ar	d hotal/motal
						ation need to be documented		
outdoor ventilat	ion rates and	airflows may be showi	on the plans or the ca	lculations can be	e presented in	a spreadsheet.		
01		<u>`</u>	·			or attaching the calculation	is instead of completing this	table.
02		·	oject included Nonresio					
		<u>:</u> _	oject included new or a					
03		Check the box if the pro	ject is using natural ve	ntilation in any r	nonresidential	l or hotel/motel spaces to m	eet required ventilation rat	es per <u>§120.1(c)2</u> .
C. TERMINAL E	OX CONTR	OLS						
his section doe	N N N N N N N N N N N N N N N N N N N							
ms section doc	o not apply to	tins projecti						
DISTRIBUTION	ON (DUCTW	ORK and PIPING)						
his table is used	d to show cor	npliance with mandato	ry pipe insulation requi	rements found ir	n <u>§120.3</u> and	prescriptive requirements fo	ound in <u>§140.4(I)</u> for duct le	akage testing.
Ouct Leakage Se	aling							
he answers to	the questions	below apply to the fol	owing duct systems:	M0.01 HVA	AC Notes	Duct leakage testing trig	gered for these systems?	No
11	No	The scope of the	project includes only o	luct systems ser	ving healthcar	re facilities		
12	Yes			•	•	nstant volume, single zone,	space-conditioning system.	
13	Yes	The space condi	ioning system serves le	ess than 5,000 ft	<sup>2</sup> of condition	ed floor area.		
14	No	The <u>combined</u> s	irface area of the ducts	in the following	g locations is n	nore than 25% of the total s	urface area of the entire du	ct system:
			Outdoors					
						greater than the u-factor of		
					rooi nas lixec	d vents or openings to the o	utside/ unconditioned space	es
			In an unconditioned c	rawi space				
	,	andards - 2019 Nonreside	•		Version: 2019.1 Version: rev 20		•	ated: 2022-03-29 16:35
Space Con	ditionin	g Mandatory i	Measures:					
.10.5 PILOT LI	GHTS PROH	BITED FOR NATURA	GAS EQUIPMENT					
PILOT LIGHTS A	ARE PROHIB	TED ON NATURAL GA	S FAN-TYPE CENTRA	L FURNACES, P	OOL HEATER	RS, SPA HEATERS, AND FIR	EPLACES.	
.10.8(a) INSUI								
		ALL BE CERTIFIED BY	THE DEPARTMENT O	F CONSUMER A	AFFAIRS PER	TITLE 24, PART 12, CHAPT	TERS 12-13, ARTICLE 3 "ST	TANDARDS FOR
NSULATING M		LIVE INCLUATION						
		HYDE INSULATION	BE INSTALLED LINLES	SS IN EXTERIOR	SIDE WALLS	S WITH A FOUR-MIL-THICE	K PI ASTIC POLYETHYLENE	VAPOR RETARDER
						ALDEHYDE FOAM INSULA		
10.8(c) INSUL	ATING MAT	ERIAL						
ALL INSULATIN	G MATERIAI	S SHALL BE INSTALLE	D IN COMPLIANCE W	ITH THE FLAM	E SPREAD RA	ATING AND SMOKE DENSI	TY REQUIREMENTS OF TH	HE CALIFORNIA
BUILDING COD	E.							
10.8(d) DUCT								
				<u>-</u>	L COMPLY W	/ITH SECTION 604.0 OF TH	1E CMC.	
			AIR QUALITY REQUI		DENTIAL DIT	II DINCE OTHER THAN HE	ALTHCARE CHALL CONTROL	V WITH APPLICATE
						ILDINGS OTHER THAN HE AND AIR-DISTRIBUTION S		
ON THE PLANS		TEL TIMOUGH (g). II	IL NEGOINED OUTDO	ON AIN VENTIL	Z (TION NATE	AND AIR DISTRIBUTION S	VIOLEIAI DEDIGIA DUMPE DE	- SELANCI IDENTIFI
20.1(c)2 NAT		LATION						
			GNED IN ACCORDANG	CE WITH 120.1	(c)2A THROU	JGH 120.1(c)2C AND INCL	UDE A MECHANICAL VEN	TILATION SYSTEMS
		E WITH 120.1(c)3.				.,		
120.1(c)3 MEC	HANICAL VI	NTILATION						
					STEM CAPAB	LE OF PROVIDING AN OU	TDOOR AIRFLOW RATE (V	z) TO THE ZONE NO
			20.1(c)3A OR 120.1(d	c)3B.				
20.1(d) TIME	S OF OCCUP	ANCV						
٠,	TD000		T TIN 4EC	CDA CE 10 / :=: : :		'D IN 4000000	1420.44.)	
` '		RATE SHALL BE MET	AT TIMES WHEN THE	SPACE IS USUA	LLY OCCUPIE	ED IN ACCORDANCE WITH	120.1(c).	

THE LESSER OF THE MINIMUM RATE OF OUTDOOR AIR REQUIRED BY SECTION 120.1(c) OR THREE COMPLETE AIR CHANGES SHALL BE SUPPLIED TO THE ENTIRE

DCV CONTROLS ARE REQUIRED FOR A SPACE WITH A DESIGN OCCUPANCY DENSITY >= 25 PEOPLE/1,000 FT2 IF THE SYSTEM SERVING THE SPACE HAS ONE OR MORE OF

BUILDING DURING THE 1-HOUR PERIOD IMMEDIATELY REFORE THE BUILDING IS NORMALLY OCCUPIED.

120.1(d)3 REQUIRED DEMAND CONTROL VENTILATION

 MODULATING OUTSIDE AIR CONTROL DESIGN OUTDOOR AIRFLOW RATE > 3,000 CFM

THE FOLLOWING

AN AIR ECONOMIZER

STATE OF CALIFORNIA

CALIFORNIA ENERGY COMMISSIO

Registration Provider: Energy Code Ace

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NRCC-MCH-E

Mechanical Systems

**Mechanical Systems** CALIFORNIA ENERGY COMMISSION CERTIFICATE OF COMPLIANCE NRCC-MCH-E (Page 4 of 6) 2022-03-29T19:35:13-04:00 3928 KORNBLUM AVE. HAWTHORNE, CA 90250 Date Prepare L. DISTRIBUTION (DUCTWORK and PIPING) ☐ In other unconditioned spaces The scope of the project includes extending an existing duct system, which is constructed, insulated or sealed with asbesto The scope of the project includes an existing duct system that is documented to have been previously sealed as confirmed through field verification and diagnostic testing in accordance with procedures in the Reference Nonresidential Appendix NA2. Duct system shall be sealed in acordance with the California Mechanical Code M. COOLING TOWERS his section does not apply to this project N. DECLARATION OF REQUIRED CERTIFICATES OF INSTALLATION Selections have been made based on information provided in previous tables of this document. If any selection needs to be changed, please explain why in Table E Additional Remark These documents must be provided to the building inspector during construction and can be found online at ttps://www.energy.ca.gov/title24/2019standards/2019\_compliance\_documents/Nonresidential Documents/NRC Field Inspector NRCI-MCH-01-E - Must be submitted for all buildings O. DECLARATION OF REQUIRED CERTIFICATES OF ACCEPTANCE Selections have been made based on information provided in previous tables of this document. If any selection needs to be changed, please explain why in Table E Additional Remark: These documents must be provided to the building inspector during construction and can be found online at ttps://www.energy.ca.gov/title24/2019standards/2019\_compliance\_documents/Nonresidential\_Documents/NRCA/ tems/Spaces To Be Field Pass Fail Verified NRCA-MCH-02-A - Outdoor Air must be submitted for all newly installed HVAC units. Note: MCH-02-A can be performed conjunction with MCH-07-A Supply Fan VFD Acceptance (if applicable) since testing activities overlap. P. DECLARATION OF REQUIRED CERTIFICATES OF VERIFICATION There are no NRCV forms required for this project. Registration Number: Registration Date/Time: Registration Provider: Energy Code Ace

### Space Conditioning Mandatory Measures:

CA Building Energy Efficiency Standards - 2019 Nonresidential Compliance

STATE OF CALIFORNIA

120.1(f)1 ALL MECHANICAL VENTILATION AND SPACE-CONDITIONING SYSTEMS SHALL BE DESIGNED WITH AND HAVE INSTALLED DUCTWORK, DAMPERS, AND CONTROLS TO ALLOW OA RATES TO BE OPERATED AT THE LARGER OF: 120.1(c)3 MINIMUMS OR THE RATE REQUIRED FOR MAKE-UP OF EXHAUST SYSTEMS FOR AN EXEMPT OR COVERED PROCESS, CONTROL OF ODORS, OR CONTAMINANT REMOVAL IN A SPACE. 120.1(g) AIR CLASSIFICATION AND RECIRCULATION LIMITATIONS

Report Version: 2019.1.003

Schema Version: rev 20200601

## 120.4 AIR DISTRIBUTION SYSTEM DUCTS AND PLENUMS

AIR CLASSIFICATION AND RECIRCULATION LIMITATIONS OF AIR SHALL BE BASED ON TABLE 120.1-A OR TABLE 120.1-C, AND IN ACCORDANCE WITH 120.1(g)1 THROUGH

- PORTIONS OF SUPPLY- AND RETURN-AIR DUCTS CONVEYING HEATED OR COOLED AIR LOCATED IN ONE OR MORE OF THE FOLLOWING SPACES SHALL BE INSULATED TO A MINIMUM INSTALLED LEVEL OF R-8:
- IN A SPACE BETWEEN THE ROOF AND AN INSULATING CEILING
- IN A SPACE DIRECTLY UNDER A ROOF WITH FIXED VENTS OR OPENINGS TO THE OUTSIDE OR UNCONDITIONED SPACES
- UNCONDITIONED SPACES, SUCH AS UNCONDITIONED CRAWLSPACE PORTIONS OF SUPPLY-AIR DUCTS THAT ARE NOT IN ONE OF THESE SPACES, INCLUDING DUCTS BURIED IN CONCRETE SLAB, SHALL BE INSULATED TO A MINIMUM

INSTALLED LEVEL OF R-4.2 (OR ANY HIGHER LEVEL REQUIRED BY CMC 605.0), OR BE ENCLOSED IN DIRECTLY CONDITIONED SPACE.

<u>CIVIL</u> **Breen Engineering** 1983 W. 190th St., Suite 200 Torrance, CA 90504 T: 310.464.8404

CONSULTANTS:

MECHANICAL/ **ELECTRICAL/ PLUMBING Breen Engineering** 1983 W. 190th St., Suite 200 Torrance, CA 90504 T: 310.464.8404

**IDENTIFICATION STAMP** DIV. OF THE STATE ARCHITEC

REVIEWED FOR SS 🗹 FLS 🗹 ACS 🗹

APP: 03-122151 INC:

abode

LAEP EARLY

13928 KORNBLUM AVE.

HAWTHORNE, CA 90250

**Los Angeles Education** 

1541 Wilshire Blvd., Suite 200

Los Angeles, CA 90017

**Abode Communities** 

Los Angeles, CA 90015 T: 213.629.2702

1149 S. Hill Street, Suite 700

CLIENT:

Partnership

T: 213.622.5237

ARCHITECT:

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communities

architecture

**CHILDHOOD CENTER** 

STRUCTURAL **Breen Engineering** 1983 W. 190th St., Suite 200 Torrance, CA 90504 T: 310.464.8404



1983 WEST 190TH STREET, SUITE 200 TORRANCE, CA 90504 **TEL:** (310) 464-8404 **FAX:** (310) 464-8408 WWW.BREENENG.COM DSA APPLICATION NUMBER: 03-122151

PROJECT NO: 219-22-001 The ideas and designs represented herein and this drawing, all prepared by Abode Communities are for the use solely with respect to this project and Abode Communities shall retain all common law, statutory and other reserved rights including copyright, and they shall not be used by others for any other purpose without written permission of



Abode Communities | Architecture.

	DATE	REV
PROGRESS SET	02.01.22	
DSA PROGRESS SET	03.02.22	
DSA APPLICATION SET	04.01.22	
DSA BACK-CHECK SET	10.05.22	
DSA BACK-CHECK SET	10.24.22	
DSA BACK-CHECK SET	11.01.22	

SHEET NAME:

TITLE 24 COMPLIANCE FORMS

DRAWN BY DESIGNED BY

CHECKED BY APPROVED BY SHEET NUMBER:

. ALL PIPING FOR POTABLE WATER SHALL BE AB1953 COMPLIANT (LEAD-FREE LAW).

. ALL MANUFACTURER'S CUT SHEET AND INSTALLATION MANUAL SHALL BE ON SITE AND AVAILABLE FOR CITY INSPECTOR.

3. WORDING IN PIPING SHALL BE IN COMPLIANCE AND NOT IN CONFLICT WITH CHAPTER 6 OF THE C.P.C.

PLUMBING LEGEND										
SYMBOL	ABBREVIATION	DESCRIPTION								
<del></del>		PIPE-TURN DOWN								
<del></del>		PIPE-TURN UP								
	CW	DOMESTIC COLD WATER								
	HW	DOMESTIC HOT WATER								
	HWR	DOMESTIC HOT WATER RETURN								
	W	WASTE BELOW GRADE								
	W	WASTE ABOVE GRADE								
	V	SANITARY VENT								
******	V	SANITARY VENT BELOW GRADE								
TPL	TPL	TRAP PRIMER LINE								
IRR	IRR	IRRIGATION LINE								
——————————————————————————————————————	CD	A.C. CONDENSATE DRAIN								
	SCD	SECONDARY CONDENSATE DRAIN								
<b>─</b>	sov	SHUT-OFF VALVE								
<u></u>	CV	CHECK VALVE								
	SOV YB	SHUT-OFF VALVE IN YARD BOX								
—————	BV	BALANCING VALVE								
<del>_</del>	GC	GAS COCK								
X	PRV	PRESSURE REDUCING VALVE STATION								
— <del>\$</del> —	TMV	TEMPERATURE MIXING VALVE								
ф	FCO/COTG	FLOOR TYPE WASTE LINE CLEANOUT/CLEANOUT TO GRADE								
⊩	WCO	WALL TYPE WASTE LINE CLEANOUT								
<b></b>	FD	FLOOR DRAIN (ROUND)								
	FD	FLOOR DRAIN (SQUARE)								
<b>₹</b>		PRESSURE RELIEF VALVE								
~~		FLEXIBLE CONNECTION								
MHA	WHA	WATER HAMMER ARRESTOR								
		DIRECTION OF SLOPE								
		INDICATES DIRECTION OF FLOW								
I	UN	UNION (FOR TYPE SEE SPEC.)								
<del>+</del>	НВ	HOSE BIBB								

ABBREVIATION	DESCRIPTION						
ABV	ABOVE						
AP	ACCESS PANEL						
BEL	BELOW						
СВ	CATCH BASIN						
CO	CLEANOUT						
COTG	CLEANOUT TO GRADE						
CLG	CEILING						
CONN	CONNECT OR CONNECTION						
DA	DISABLED ACCESS						
DN	DOWN						
EXIST/(E)	EXISTING						
FF	FINISH FLOOR						
FR	FROM						
FCO	FLOOR CLEANOUT						
FLR	FLOOR						
GRD	GRADE						
HDR	HEADER						
PDP	PUMP DISCHARGE PIPING						
SSD	SUB-SURFACE DRAIN						
TYP	TYPICAL						
MH	MANHOLE						
VTR	VENT THRU ROOF						
@	AT						
BLDG.	BUILDING						
#	NUMBER						
(N)	NEW						
(R)	REMOVE						
GWD	GREY WATER DRAIN						

## PLUMBING GENERAL NOTES

- SCOPE OF WORK:
  - A. FURNISH ALL LABOR, SUPERVISION, MATERIALS, EQUIPMENT & FACILITIES NECESSARY TO FURNISH, FABRICATE, DELIVER, STORE AND INSTALL ALL WORK NOTED ON THE DRAWINGS.
  - B. THE CONTRACTOR SHALL FURNISH & INSTALL ALL WORK NECESSARY TO MAKE A COMPLETE SYSTEM WHETHER OR NOT SUCH DETAILS ARE MENTIONED IN THESE SPECIFICATIONS OR SHOWN ON THE PLANS, BUT WHICH ARE OBVIOUSLY NECESSARY TO MAKE A COMPLETE SYSTEM, EXCEPTING ONLY THOSE PORTIONS THAT ARE SPECIFICALLY MENTIONED HEREIN OR PLAINLY MARKED ON THE ACCOMPANYING DRAWINGS AS BEING INSTALLED UNDER ANOTHER SECTION OF THE SPECIFICATION.
- CODES AND PERMITS: ALL MECHANICAL EQUIPMENT, INSTALLATION, ETC., SHALL CONFORM TO ALL APPLICABLE CODES AND ORDINANCES, INCLUDING CALIFORNIA TITLE 24. CONSTRUCTION SHALL COMPLY WITH THE FOLLOWING PARTS OF TITLE 24, CALIFORNIA CODE OF REGULATIONS (CCR):
  - TITLE 24, PART 1, CCR (2019 CALIFORNIA BUILDING CODE)
  - TITLE 24, PART 2, CCR (2019 CALIFORNIA BUILDING CODE) (2018 INTERNATIONAL BUILDING CODE, VOL. 1 & 2, AND 2019 CALIFORNIA AMENDMENTS)
  - TITLE 24, PART 3, CCR (2019 CALIFORNIA ELECTRICAL CODE)
  - (2017 NATIONAL ELECTRICAL CODE AND 2019 CALIFORNIA AMENDMENTS) TITLE 24, PART 4, CCR (2019 CALIFORNIA MECHANICAL CODE)
  - (2018 IAPMO UNIFORM MECHANICAL CODE AND 2019 CALIFORNIA AMENDMENTS) TITLE 24, PART 5, CCR (2019 CALIFORNIA PLUMBING CODE)
  - (2018 IAPMO UNIFORM PLUMBING CODE AND 2019 CALIFORNIA AMENDMENTS) TITLE 24, PART 6, CCR (2019 CALIFORNIA ENERGY CODE)
  - TITLE 24, PART 9, CCR (2019 CALIFORNIA FIRE CODE)
  - (2018 INTERNATIONAL FIRE CODE AND 2019 CALIFORNIA AMENDMENTS)
  - TITLE 24, PART 10, CCR (2019 CALIFORNIA EXISTING BUILDING CODE) (2018 INTERNATIONAL EXISTING BUILDING CODE AND 2019 CALIFORNIA AMENDMENTS)
  - TITLE 24, PART 11, CCR (2019 CALIFORNIA GREEN BUILDING STANDARDS)
  - TITLE 24, PART 12, CCR (2019 CALIFORNIA REFERENCED STANDARDS CODE)
  - TITLE 19, CCR, PUBLIC SAFETY, STATE FIRE MARSHAL REGULATIONS
  - NFPA 13 (2016) STANDARD FOR THE INSTALLATION OF SPRINKLER SYSTEM (CA AMENDED) NFPA 14 (2016) - STANDARD FOR THE INSTALLATION OF STANDPIPE AND HOSE SYSTEMS (CA AMENDED)
  - NFPA 72 (2016) NATIONAL FIRE ALARM AND SIGNALING CODE (CA AMENDED)
- CONTRACTOR SHALL OBTAIN AND PAY FOR ALL PERMITS. ALL PIPE, PIPE FITTINGS, TRAPS, FIXTURES, MATERIAL, AND DEVICES USED IN THE PLUMBING SYSTEM SHALL BE
- RECOGNIZED STANDARDS REFERENCED IN THE 2019 UNIFORM PLUMBING CODE. SITE INSPECTION: CONTRACTOR SHALL VISIT THE SITE OF WORK PRIOR TO SUBMISSION OF HIS BID AND THOROUGHLY FAMILIARIZE HIMSELF WITH THE WORKING CONDITIONS & EXACT NATURE OF THE WORK. SUBMISSION OF A BID ACKNOWLEDGES FULL RESPONSIBILITY FOR FURNISHING A COMPLETE & FUNCTIONAL SYSTEM. NO CHANGES IN CONTRACT WILL BE MADE TO ACCOMMODATE OR ALLOW EXTRA FUNDING FOR ANY OMISSIONS WHICH

LISTED OR THIRD-PARTY CERTIFIED BY AN APPROVED LISTING AGENCY AND SHALL CONFORM TO APPLICABLE

- OF UTILITIES PRIOR TO STARTING WORK OF THIS SECTION. MAKE REQUIRED ADJUSTMENTS TO CONNECT TO UTILITIES. IF INDICATED POINTS OF CONNECTION CANNOT BE MADE TO EXISTING UTILITIES AS FOUND. THE CONTRACTOR SHALL, BEFORE CONTINUING, NOTIFY THE ENGINEER PRIOR TO INSTALLING ANY WORK WHICH MAY BE
- ALL DIMENSIONS AND LOCATIONS PER ARCHITECTURAL DRAWINGS.

AFFECTED.

RESULTS FROM A FAILURE TO THOROUGHLY MAKE THE EXAMINATION.

- IT SHALL BE THE CONTRACTORS RESPONSIBILITY TO VERIFY AVAILABLE SPACES FOR INSTALLING THE WORK.
- COORDINATION: THE DRAWINGS ARE DIAGRAMMATIC & INTENDED TO SHOW SCOPE. CONTRACTOR SHALL COORDINATE HIS WORK WITH OTHER TRADES TO PROVIDE BEST ARRANGEMENT OF ALL DUCT, PIPES, CONDUIT, ETC.
- WORKMANSHIP: THE WORK SHALL BE ACCOMPLISHED IN A THOROUGH & WORKMANLIKE MANNER SATISFACTORY TO AND MEETING THE APPROVAL OF THE ENGINEER AND ARCHITECT.
- 10. GUARANTEE: CONTRACTOR SHALL UNCONDITIONALLY GUARANTEE ALL LABOR & MATERIAL ON ALL WORK AGAINST
- DEFECTS IN WORKMANSHIP & MATERIALS FOR A PERIOD OF ONE YEAR.

MATERIALS: ALL MATERIALS, APPLIANCES & EQUIPMENT SHALL BE NEW & THE BEST OF THEIR RESPECTIVE KIND.

- FREE FROM ALL DEFECTS AND OF THE MAKE, BRAND, AND QUANTITY SPECIFIED.
- 12. SUBMITTALS: CATALOG INFORMATION & CUTS OF ALL EQUIPMENT, DEVICES & TRIM SHALL BE SUBMITTED FOR REVIEW (SIX COPIES OF EACH). ALL SUBMITTALS TO BE APPROVED BY ARCHITECT & ENGINEER.
- 13. ALL HOT WATER SUPPLY AND RECIRCULATION PIPING TO BE INSULATED AS PER TITLE 24 TABLE 1-G, PER PLUMBING CODE, OR AS FOLLOWS, WHICHEVER IS MORE RESTRICTIVE:

PIPE SIZE, IN.	INSULATION THICKNESS, IN. (K=0.24-0.28)(R-4.2) BTUH-IN/SQ.FT. F OR LESS)
$\frac{1}{2}$ " THROUGH $\frac{3}{4}$ "	1"
1" THROUGH 1½"	1½"
2" THROUGH 6"	2"

- 14. CLEAN-OUTS SHALL BE INSTALLED AS PER SEC. 707 AND 719 OF THE CALIFORNIA PLUMBING CODE.
- PROVIDE FELT WITH METAL BACKING VIBRATION ISOLATION SLEEVES OR PADS AT ALL PIPE HANGERS OR SUPPORTS AND ALL POINTS WHERE PIPING COMES IN CONTACT WITH ANY PORTION OF THE STRUCTURE. APPLIES TO ALL WATER AND WASTE PIPING. PROVIDE FELT AROUND ALL PVC PIPING AT SUPPORTS FOR THERMAL EXPANSION.
- 16. ALL PIPES, DUCTS AND CONDUITS SHALL BE SUPPORTED AND BRACED PER "SMACNA" GUIDE LINES.

18. VALVES SHALL FULL FLOW 1/4 TURN BALL TYPE BE NIBCO, WATTS, CRANE, STOCKHAM OR EQUAL. SERVICE PRESSURE SHALL BE SUITABLE FOR SERVICE INTENDED. PROVIDE AND INSTALL IDENTIFICATION TAGS ON ALL VALVES. VALVES IN EXPOSED COMMON AREAS TO HAVE LOCKING HANDLES. NO IRON BODY VALVES WILL BE

17. PLUMBERS TAPE WILL NOT BE ACCEPTED AS A PERMANENT SUPPORT FOR ANY PIPING OR DEVICES.

- 19. PROVIDE AND INSTALL DIELECTRIC UNIONS BETWEEN ALL COPPER AND GALVANIZED & IRON PIPING & COMPONENTS. (AS WATTS, ZURN OR EQUAL).
- 20. PENETRATIONS IN WALLS, FLOORS, OR CEILINGS, WHICH REQUIRE PROTECTED OPENINGS SHALL BE FIRE-STOPPED. FIRE-STOPPING SHALL BE AN APPROVED MATERIAL, SECURELY INSTALLED AND CAPABLE OF MAINTAINING ITS INTEGRITY WHEN SUBJECTED TO THE TIME-TEMPERATURE CURVED OF SFM STD. # 12-43-3 AND STD. # 12-43-1. INSTALLATION INSTRUCTIONS SHALL BE MADE AVAILABLE TO THE INSPECTION AUTHORITY AND BE MAINTAINED AT
- 21. PROVIDE WATERTIGHT FLASHING WHEREVER PIPES PASS THROUGH EXTERIOR WALLS, ROOF AND FLOORS.
- 22. CUTTING AND PATCHING: ALL CUTTING & PATCHING OF THE EXISTING STRUCTURE SHALL BE PROVIDED. PROVIDE ALL NECESSARY REQUIREMENTS TO THE PROJECT MANAGER. PROTECTION AGAINST DUST AND DEBRIS SHALL BE TO THE SATISFACTION OF THE PROJECT MANAGER.
- 23. CLEANUP: UPON COMPLETION OF THE WORK UNDER THIS SECTION THE CONTRACTOR SHALL REMOVE ALL SURPLUS MATERIALS. EQUIPMENT & DEBRIS INCIDENTAL TO THIS WORK & LEAVE THE PREMISES CLEAN AND ORDERLY. PROVIDE NEW CEILING TILES (TO MATCH EXISTING) IF ANY DAMAGED DURING CONSTRUCTION.
- 24. FIRE SPRINKLER SYSTEM TO BE HYDRAULICALLY DESIGNED BY FIRE SPRINKLER CONTRACTOR. ALL EQUIPMENT, COMPONENTS & PIPE RUNS SHOWN FOR REFERENCE ONLY.
- 25. ALL SEWER LINES RUN @ SLOPES LESS THAN 2% ARE SUBJECT TO FIELD APPROVAL OF PLUMBING INSPECTOR.
- 26. WASTE PIPE SIZES THAT ARE 3 INCHES OR SMALLER SHALL BE EVALUATED AT 2% SLOPE.
- 27. WATER, SEWER, VENT, FIRE AND GAS PIPES THROUGH CONCRETE WALLS AND FLOORS SHALL HAVE PIPE-SLEEVES WITH NON COMBUSTIBLE SEALING.
- 28. ALL HOSE BIBBS SHALL BE EQUIPPED WITH AN APPROVED NON REMOVABLE VACUUM BREAKER.
- 29. RUN A FULL SIZE DRAIN LINE FROM WATER HEATERS TEMPERATURE AND PRESSURE RELIEF VALVE TO NEAREST FLOOR SINK OR TO AN APPROVED LOCATION.
- 30. PROVIDE ACCESS DOORS TO ALL CONCEALED VALVES, STRAINERS, TRAP PRIMERS, ETC.
- 31. ALL PIPING IN FINISHED AREAS SHALL BE RUN CONCEALED. EXPOSED PIPING, WHERE NECESSARY, SHALL RUN AS HIGH AS POSSIBLE AND TIGHT TO THE WALLS.
- LOCATIONS OF UTILITIES SHOWN ARE APPROXIMATE. CONTRACTOR SHALL VERIFY EXACT LOCATIONS AND DEPTHS 32. NO VENT OUTLET SHALL TERMINATE CLOSER THAN TEN FEET TO OR THREE FOOT ABOVE ANY DOOR, WINDOW OR GRAVITY AIR INTAKE, NOR CLOSER THAN TEN FEET TO OR THREE FEET ABOVE ANY FORCED OR MECHANICAL AIR INTAKE.
  - 33. ALL VENTS AND FLUE OUTLETS SHALL BE A MINIMUM OF 10 FEET FROM ANY FRESH AIR INTAKES.
  - 34. TYPE B VENTS SHALL TERMINATE 2 FT. ABOVE OR 8 FT. AWAY FROM ANY VERTICAL SURFACE.
  - 35. WATER HEATERS SHALL BE SEISMICALLY BRACED.

609.11.2.

- 36. INSTALL WATER HAMMER ARRESTORS ON EACH COLD AND HOT WATER FIXTURE BRANCH AS RECOMMENDED BY PLUMBING AND DRAINAGE INSTITUTE WH-210 STANDARD. DEVICES SHALL BE FACTORY MADE WITH PERMANENT CUSHION OF GAS OR PROVIDE ACCESS PANEL.
- 37. BATHTUBS, SHOWERS AND LAVATORIES TO COMPLY WITH 2019 CPC CHAPTER 4, ASSE 1070, & ASSE 1016
- 38. LAVATORY CONTROLS SHALL LIMIT THE FLOW RATE 0.4 GPM AND 110°F.
- 39. SHOWER TUB-SHOWER COMBINATION SHALL HAVE INDIVIDUAL SHOWER CONTROL VALVE OF THE PRESSURE BALANCE OR THE THERMOSTATIC MIXING VALVE TYPE, SET AT 120°F MAXIMUM.
- 40. USE FEMALE COPPER NIPPLE TO MALE MALE PLASTIC PIPE FOR COPPER TO PLASTIC TRANSITION.
- 41. BUILDING DRAIN AND VENT PIPING MATERIALS SHALL COMPLY WITH SECTIONS 701.0 AND 903.0 OF THE CALIFORNIA PLUMBING CODE.
- 42. ALL SANITARY SYSTEM MATERIALS SHALL BE LISTED BY AN APPROVED LISTING AGENCY.
- 43. EACH VENT SHALL RISE VERTICALLY TO A POINT NOT LESS THAN SIX (6) INCHES ABOVE THE FLOOD-LEVEL RIM OF THE FIXTURE SERVED BEFORE OFFSETTING HORIZONTALLY OR BEFORE BEING CONNECTED TO ANY OTHER VENT.
- 44. PLUMBING FIXTURES AND FITTINGS SHALL COMPLY WITH ALL THE REQUIREMENTS IN SECTION 5.303 IN THE 2019 CALIFORNIA GREEN BUILDING CODE.
- 45. NEW OR REPAIRED POTABLE WATER SYSTEMS SHALL BE DISINFECTED PRIOR TO USE ACCORDING TO SECTION
- 609.9 OF THE PLUMBING CODE.

46. INSULATION OF DOMESTIC HOT WATER PIPING SHALL BE IN ACCORDANCE WITH SECTION 609.11.1 AND SECTION

PLUMBING SHEET INDEX	

SHEET NO.	SHEET TITLE	CURRENT ISSUE							
P0.01	PLUMBING GENERAL NOTES, SYMBOLS LEGEND & SHEET INDEX	DSA RESUBMITTAL							
P0.02	PLUMBING SCHEDULES & CALCULATIONS	DSA RESUBMITTAL							
P1.00	PLUMBING SITE PLAN	DSA RESUBMITTAL							
P2.01	PLUMBING BUNGALOW 01 & 02 PIPING PLANS	DSA RESUBMITTAL							
P2.02	PLUMBING BUNGALOW 03 & 04 PIPING PLANS	DSA RESUBMITTAL							
P4.01	PLUMBING WASTE & VENT RISER DIAGRAMS	DSA RESUBMITTAL							
P4.02	PLUMBING HOT & COLD WATER RISER DIAGRAMS	DSA RESUBMITTAL							
P5.01	PLUMBING DETAILS - SHEET ONE	DSA RESUBMITTAL							
P5.02	PLUMBING DETAILS - SHEET TWO	DSA RESUBMITTAL							

APP: 03-122151 INC: REVIEWED FOR SS 🗹 FLS 🗹 ACS 🗹 DATE: \_\_\_ 11/02/2022

**IDENTIFICATION STAMP** DIV. OF THE STATE ARCHITEC

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	DATE	REV
ROGRESS SET	02.01.22	
SA PROGRESS SET	03.02.22	
SA APPLICATION SET	04.01.22	
SA BACK-CHECK SET	10.05.22	
SA BACK-CHECK SET	10.24.22	

SHEET NAME:

PLUMBING GENERAL NOTES. SYMBOLS LEGEND & SHEET INDEX

SHEET NUMBER:

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	ELECTRIC STORAGE TYPE WATER HEATER SCHEDULE											
MARK	MAKE	MAKE MODEL SERVICE LOCATION QTY CAPACITY (GAL) RECOVERY RA				RECOVERY RATE	ELECTRICAL DATA			OPERATING	REMARKS	
WARK	RN IVIANE IN	MODEL	WODEL SERVICE	VICE LOCATION	QII	OAI AOITT (OAL)	RECOVERTRATE	V	PHASE	HZ	WEIGHT (LBS)	KEWARKS
EWH-1	AMERICAN WATER HEATER	LDCE32-30R-30	DOMESTIC HOT WATER	ONSITE BUNGALOW 01	1	30	46 GPH @ 80°F RISE	208	3	60		WITH SEISMIC STRAPS. TEMPERATURE & PRESSURE RELIEF VALVE TO DRAIN FULL SIZE ABOVE FLOOR SINK WITH 1" MINIMUM AIRGAP.

	ELECTRIC INSTANTANEOUS WATER HEATER SCHEDULE													
MARK	MAKE	MODEL	ODEL SERVICE LOCATION QTY FLOW PRESSURE TEMPERATURE		ELECTRICAL DATA			OI EI ( I II V		REMARKS				
						(GPM)	DROP (FT.)	RISE	٧	KW	PHASE	HZ	WEIGHT (LBS.)	
EWH-2	EEMAX INC.	EX4208	POINT OF USE WATER HEATER	BELOW LAVATORY BUNGALOW 03	1	0.5	-	0.5 GPM @ 56°F RISE	208	4.1	1	60	4	INSTANTANEOUS TYPE, BELOW LAVATORY WITH HIGH TEMPERATURE LIMIT SWITCH. WALL MOUNT PER MANUFACTURER

	THERMAL EXPANSION TANK SCHEDULE										
MARK	MAKE	MODEL	SERVICE	LOCATION	QTY	TYPE	MAX. ACCEPTANCE FACTOR	PRESSURE  MIN. (PSI) MAX.(PSI)		OPERATING WEIGHT (LBS) REMARKS	
TET-1	AMTROL ASME THERM-X-TROL	ST-5-C	DOMESTIC HOT WATER	ONSITE BUNGALOW 01	1	BLADDER (FDA APPROVED)	0.9	20	150	43	PROVIDE SEISMIC STRAPS.

	PUMP SCHEDULE													
						PERFORMANCE			ELECTRICAL DATA					
MARK	MAKE	MODEL	SERVICE	LOCATION	QTY	GPM	TDH (FT.)	MIN. EFF.	RPM	HP/ WATTS	V	PH	HZ	REMARKS
RCP-1	GRUNDFOS	UPS 43-44 BFC	DOMESTIC HOT WATER RECIRCULATION	ONSITE BUNGALOW 01	1	3	10	-	-	⅓ HP	115	1Ø	60	1) ALL PUMPS TO BE ALL BRONZE. 2) SPEED SETTING 3. 3) PROVIDE WITH TIMER CONTROL AND AQUASTAT. 4) INSTALL THERMAL PURGE VALVE SET TO OPEN AT 160°F CLOSE AT 150°F ON THE DISCHARGE OF THE PUMP AS PROTECTION.

	VALVES SCHEDULE									
MARK	MAKE	MODEL	SERVICE	LOCATION	QTY	TYPE	FLOW	PIPE SIZE	VALVE SIZE	REMARKS
TMV-1	POWERS	LFMM433	DOMESTIC HOT WATER TEMPERING	ONSITE BUNGALOW 01	1	THERMOSTATIC MASTER CONTROLLER	37 GPM MAX & 5 PSI LOSS	1½"	1½"	THE VALVE SHALL BE COMPLETE WITH INTEGRAL ISOLATORS, STRAINERS, CHECK VALVES AND GAUGE/FLUSHING PORTS ON EACH INLET, SET TO 120 °F.
TMV-2	CASH ACME	HEATGUARD 145 SERIES	DOMESTIC HOT WATER TEMPERING	BELOW LAVATORY BUNGALOW 02	1	POINT-OF-USE	0.5 MIN - 5.5 MAX	3/4"	-	POINT-OF-USE THERMOSTATIC MIXING VALVE, SET AT 120°F

WASTE FIXTURE CALCULATIONS

BUNGALOW 01

HOT WATER DEMAND CALCULATIONS								
BUNGALOW 01								
FIXTURE	NUMBER OF FIXTURE	Х	HOT WATER DEMAND	II	TOTAL HOT WATER DEMAND			
CLOTHES WASHERS	2	Χ	30.0	=	60.0			
KITCHEN SINK (FOOD PREP)	1	Χ	15.0	=	15.0			
SERVICE SINK	1	Χ	25.0	=	25.0			
BUNGALOW 01 TOTAL HOT WATER DEMAND (GPH) = 100.0								
PROBABLE DEMAND = 100.0 X 0.3 (DEMAND FACTOR PER ASPE) = 30.0 GPH								
STORAGE CAPACITY = 30.0 X	1 (STORAGE FACT	TOR:	) = 30.0 GAL					

DUNGALOW 01							
FIXTURE	NUMBER OF FIXTURE	Х	FIXTURE UNITS	=	TOTAL FIXTURE UNITS		
WATER CLOSET (FLUSH VALVE)	2	Х	4.0	=	8.0		
LAVATORY	1	Χ	1.0	=	1.0		
KITCHEN SINK (CHANGING)	1	Χ	2.0	=	2.0		
KITCHEN SINK (FOOD PREP)	2	Χ	2.0	=	4.0		
FLOOR DRAIN	2	Χ	2.0	=	4.0		
CLOTHES WASHER	2	Χ	3.0	=	6.0		
SERVICE SINK	1	Χ	3.0	=	3.0		
FUNNEL DRAIN	1	Χ	4.0	=	4.0		
BUNGALOW	01 TOTAL WASTE	FIX	TURE UNITS	=	32.0		
	BUNGALOW 02 AND	BUN	GALOW 04				
FIXTURE	NUMBER OF FIXTURE	х	FIXTURE UNITS	=	TOTAL FIXTURE UNITS		
WATER CLOSET (FLUSH VALVE)	2	Χ	4.0	=	8.0		
LAVATORY	1	Χ	1.0	=	1.0		
KITCHEN SINK (CHANGING)	1	Χ	2.0	=	2.0		
KITCHEN SINK (FOOD PREP)	1	Χ	2.0	=	2.0		
FLOOR DRAIN	1	Χ	2.0	=	2.0		
BUNGALOW 02 AND	04 TOTAL WASTE	FIX	TURE UNITS	=	15.0		
	BUNGALC	)W 03	3				
FIXTURE	NUMBER OF FIXTURE	х	FIXTURE UNITS	=	TOTAL FIXTURE UNITS		
WATER CLOSET (FLUSH VALVE)	3	Χ	4.0	=	12.0		
LAVATORY	2	Χ	1.0	=	2.0		
KITCHEN SINK (CHANGING)	1	Χ	2.0	=	2.0		
KITCHEN SINK (FOOD PREP)	1	Χ	2.0	=	2.0		
FLOOR DRAIN	2	Χ	2.0	=	4.0		
BUNGALOW	03 TOTAL WASTE	FIX	TURE UNITS	=	22.0		
	TOTA	L					
UNIT	NUMBER OF UNITS	Х	FIXTURE UNITS	=	TOTAL FIXTURE UNITS		
BUNGALOW 01	1	Х	32.0	=	32.0		

1 X 22.0 TOTAL WASTE FIXTURE UNITS =

BUNGALOW 02 AND 04

BUNGALOW 03

FIXTURE	NUMBER OF FIXTURE	Х	FIXTURE UNITS	=	TOTAL FIXTURE UNITS				
WATER CLOSET (FLUSH VALVE)	2	X	5.0	=	10.0				
LAVATORY	2	Χ	1.0	=	2.0				
KITCHEN SINK (CHANGING)	1	Χ	2.0	=	2.0				
KITCHEN SINK (FOOD PREP)	2	Χ	2.0	=	4.0				
CLOTHES WASHER	2	Χ	4.0	=	8.0				
SERVICE SINK	1	Χ	3.0	=	3.0				
BUNGALOW 01 TOTAL COLD WATER FIXTURE UNITS = 29.0									
GPM (FLUSH VALVE) 41.0									
BUNGALOW 02 AND BUNGALOW 04									
FIXTURE	NUMBER OF FIXTURE	х	FIXTURE UNITS	=	TOTAL FIXTURE UNITS				
WATER CLOSET (FLUSH VALVE)	2	Х	5.0	=	10.0				
LAVATORY	2	Χ	1.0	=	2.0				
KITCHEN SINK (CHANGING)	1	Χ	2.0	=	2.0				
KITCHEN SINK (FOOD PREP)	1	Χ	2.0	=	2.0				
BUNGALOW 02 AND 04 TOTAL COLD WATER FIXTURE UNITS = 16.0									
GPM (FLUSH VALVE) 33.0									
BUNGALOW 03									
FIXTURE	NUMBER OF FIXTURE	Х	FIXTURE UNITS	=	TOTAL FIXTURE UNITS				
WATER CLOSET (FLUSH VALVE)	3	Χ	5.0	=	15.0				
LAVATORY	3	Χ	1.0	=	3.0				
KITCHEN SINK (CHANGING)	1	Χ	2.0	=	2.0				
KITCHEN SINK (FOOD PREP)	1	Χ	2.0	=	2.0				
BUNGALOW 03 TOT	AL COLD WATER	FIXT	TURE UNITS	=	22.0				
	GPM	(FLU	JSH VALVE)		36.5				
	TOTA	L							
UNIT	NUMBER OF UNITS	Х	FIXTURE UNITS	=	TOTAL FIXTURE UNITS				
BUNGALOW 01	1	Χ	29.0	=	29.0				
BUNGALOW 02 AND 04	2	Χ	16.0	=	32.0				
BUNGALOW 03	1	Χ	22.0	=	22.0				
ТОТ	AL COLD WATER	FIXT	TURE UNITS	=	83.0				
GPM (FLUSH VALVE) 63.0									

COLD WATER FIXTURE CALCULATIONS

	FIXTURE/		PIPING C	CONNECTION		FIXTUR	E UNITS	DECODIDE
1ARK	EQUIPMENT	SOIL OR WASTE	VENT	COLD WATER	HOT WATER	WASTE F.U.	COLD WATER F.U.	DESCRIPTION
WC-1	FLOOR MOUNTED WATER CLOSET CHILD'S RESTROOM	4"	2"	1½"	-	4	5	FIXTURE: SLOAN MODEL #ST-2309 JUNIOR TOILET, VITREOUS CHINA, FLOOR MOUNTED, SIPHON JET FLUSH ACTION, 1½" I.P.S TOP SPUD INLET, ELONGATED BOWL, 2½" TRAPWAY DIAMETER, FULLY GLAZED TRAPWAY, INTEGRAL FLUSHING RIM. PROVIDE WITH TOILET SEAT: HOMECRAFT SAVANAH RAISED TOILET SEAT, 2" HIGH ELEVATED SEAT LOCKS FOR ACCESSIBILITY. FLUSHOMETER: ROYAL 111 ESS HARDWIRED FLUSHOMETER VALVE, OPTIMA EL-1500-L SELF-ADAPTIVE INFRARED SENSOR WITH INDICATOR LIGHT, COURTESY FLUSH OVERRIDE BOTTOM.
WC-2	FLOOR MOUNTED WATER CLOSET (ADA) CHILD'S RESTROOM	4"	2"	1½"	-	4	5	FIXTURE: SLOAN MODEL #ST-2309 JUNIOR TOILET, VITREOUS CHINA, FLOOR MOUNTED, SIPHON JET FLUSH ACTION, 1½" I.P.S TOP SPUD INLET, ELONGATED BOWL, 2½" TRAPWAY DIAMETER, FULLY GLAZED TRAPWAY, INTEGRAL FLUSHING RIM. PROVIDE WITH TOILET SEAT: HOMECRAFT SAVANAH RAISED TOILET SEAT, 2" HIGH ELEVATED SEAT LOCKS FOR ACCESSIBILITY. FLUSHOMETER: ROYAL 111 ESS HARDWIRED FLUSHOMETER VALVE, OPTIMA EL-1500-L SELF-ADAPTIVE INFRARED SENSOR WITH INDICATOR LIGHT, COURTESY FLUSH OVERRIDE BOTTOM.
	FLOOR MOUNTED WATER CLOSET (ADA) ADULT'S RESTROOM	4"	2"	1½"	-	4	5	SLOAN MODEL #WETS 2020.1304-1.28 ES-S TMO, OPTIMA SYSTEMS SENSOR ACTIVATED HET FLUSHOMETER AND HET FLOOR MOUNT ADA COMPLIANT WATER CLOSET, 1.28 GPF. FIXTURE: VITREOUS CHINA, FLOOR MOUNT, 1½" IPS TOP SPUD INLET, ELONGATED BOWL, SIPHON JET FLUSH. PROVIDE WITH TOILET WITH COMMERCIAL HEAVY-DUTY PLASTIC TOILET SEAT, BEMIS MODEL # 2155SSCT. FLUSHOMETER: ROYAL 111 ESS 1.28 HARD WIRED SENSOR WITH INDICATOR LIGHT, OPTIMA EL-1500-L SELF ADAPTIVE INFRARED SENSOR WITH INDICATOR LIGHT, NON-HOLD-OPEN TRUE MECHANICAL OVERRIDE BUTTON, CHROME PLATED METAL HANDLE CAP, 1" IPS SCREWDRIVER BAK-CHEK ANGLE STOP, ADJUSTABLE TAILPIECE.
L-1	TROUGH LAVATORY (ADA) CHILD'S RESTROOM	2"	2"	3/4"	-	1	1 EACH FAUCET	LAVATORY: KOHLER BROCKWAY MODEL #K-3200 UTILITY SINK, WALL MOUNTED, ENAMELED CAST IRON KITCHEN SINK. PROVIDE WITH KOHLER TRITON BOWE CANNOCK MODEL #K-730T70-4AJR BATHROOM SINK FAUCET, GOOSENECK SPOUT WITH ROSESPRAY, WALL-TO-SPOUT OUTLET, LEVER HANDLES, 1.2 GPM. PROVIDE TAILPIECE WITH INSULATED COVER. COMPLY WITH ADA REQUIREMENTS FOR HANDICAPPED. FIXTURE PERFORMANCE MEET OR EXCEED ASME A112.18.1/CSA B125.1 STANDARDS.
L-2	WALL HUNG LAVATORY (ADA) ADULT'S RESTROOM	2"	2"	3/4"	-	1	1	LAVATORY: AMERICAN STANDARD MURRO MODEL #0954.004EC, VITREOUS CHINA WITH EVERCLEAN, WITH OVERFLOW, WITH OPTIONAL MODEL #0059.020EC SHROUD/KNEE CONTACT GUARD, 4" CENTERS. PROVIDE WITH 4" CENTER SET, TWO-HANDLE METERING LAVATORY FAUCET, 0.2 GAL. PER HANDLE ACTIVATION, AS DELTA MODEL #86T1153. PROVIDE TAILPIECE WITH INSULATED COVER. COMPLY WITH ADA REQUIREMENTS FOR HANDICAPPED. FIXTURE PERFORMANCE MEET OR EXCEED ASME A112.18.1/CSA B125.1 STANDARDS.
S-1	CLASSROOM CHANGING AREA KITCHEN SINK (ADA)	2"	2"	3/4"	-	2	2	SINK: JUST MANUFACTURING MODEL #1821-A, SINGLE BASIN SEAMLESS DIE-DRAWN CONSTRUCTION OF #18 GAUGE, TYPE 304, STAINLESS STEEL, FULLY COATED UNDERSIDE. PROVIDE WITH DELTA TRINSIC MODEL #9159-DST KITCHEN SINK FAUCET, SINGLE HANDLE DECK MOUNTED, WITH 2-FUNCTION PULL-DOWN SPRAYER, 1.8 GPM. PROVIDED WITH INSULATED COVER, SUPPLIES, STOPS AND P-TRAP.
S-2	CLASSROOM FOOD PREPARATION KITCHEN SINK (ADA)	2"	2"	3/4"	-	2	2	SINK: JUST MANUFACTURING MODEL #1632-A, DOUBLE BOWL BASIN SEAMLESS DIE-DRAWN CONSTRUCTION OF #18 GAUGE, TYPE 304, STAINLESS STEEL, FULLY COATED UNDERSIDE. PROVIDE WITH DELTA TRINSIC MODEL #9159-DST KITCHEN SINK FAUCET, SINGLE HANDLE DECK MOUNTED, WITH 2-FUNCTION PULL-DOWN SPRAYER, 1.8 GPM. PROVIDED WITH INSULATED COVER, SUPPLIES, STOPS AND P-TRAP.
S-3	ADMINISTRATION KITCHEN SINK (ADA)	2"	2"	3/4"	3/4"	2	2	SINK: JUST MANUFACTURING MODEL #1632-A, DOUBLE BOWL BASIN SEAMLESS DIE-DRAWN CONSTRUCTION OF #18 GAUGE, TYPE 304, STAINLESS STEEL, FULLY COATED UNDERSIDE. PROVIDE WITH DELTA TRINSIC MODEL #9159-DST KITCHEN SINK FAUCET, SINGLE HANDLE DECK MOUNTED, WITH 2-FUNCTION PULL-DOWN SPRAYER, 1.8 GPM. PROVIDED WITH INSULATED COVER, SUPPLIES, STOPS AND P-TRAP. PROVIDED WITH GARBAGE DISPOSER (GD-1).
SS-1	SERVICE SINK	3"	2"	3/4"	3/4"	3	3	KOHLER WHITBY MODEL #K-6710 SERVICE SINK, 28" X 28" FLOOR MOUNT, CORNER BASIN, ACID-RESISTANT ENAMEL FINISH, WITHOUT OVERFLOW. PROVIDE WITH CHICAGO FAUCET MODEL #540-LD897SWXFABCP, WALL MOUNTED 8" FIXED CENTERS, POLISHED CHROME PLATED SOLID BRASS BRASS CONSTRUCTION, WITH VACUUM BREAKER SPOUT, MALE HOSE AND PALE HOOK, METAL LEVER HANDLES, ½" FEMALE THREAD SUPPLY INLET.
WB-1	WASHING MACHINE BOX	3"	2"	3/4"	3/4"	3	4	PRECISION PLUMBING PRODUCTS MODEL#MM-500PLB RECESSED LAUNDRY BOX WITH WATER HAMMER ARRESTORS, 1/4 TURN SHUTOFFS & 2" WASTE OUTLET PROVIDE ONE PER MACHINE & 12"x12" STAINLESS STEEL ACCESS PANEL FOR 2" TRAP.
GD-1	GARBAGE DISPOSER	-	-	-	-	-	-	MOEN GX PRO FOOD WASTE DISPOSER, ½HP VORTEX MOTOR, ULTRA COMPACT DESIGN, CONTINUOUS FEED WITH GALVANIZED STEEL GRIND COMPONENTS, WITH MANUAL RESET BUTTON.
FD-1	FLOOR DRAIN	2"	2"	½" TPL	-	2	-	ZURN FD-2240 WOOD DECK DRAIN, CAST IRON BODY WITH A STEEL ANCHOR FLANGE AND A CAST IRON FRAME AND GRATE.
FN-1	FUNNEL DRAIN	2"	2"	½" TPL	-	4	-	FUNNEL DRAIN WITH "P" TRAP, MODEL # Z1019-F6, 6" HIGH X 6" DIAMETER FUNNEL, DURA COATED CAST IRON COMBINATION FUNNEL AND TRAP DRAIN, COMPLETE WITH BRONZE BOTTOM, CLEANOUT PLUG.
TP-1	TRAP PRIMER	-	-	1/2"	-	-	-	MIFAB MODEL #MR-500-NPB, AUTOMATIC, MULTI-TRAP PRIMER, CAST BRONZE WITH ACCESS PANEL. PRESSURE DROP OF 3 PSI SHALL ACTIVATE TRAP SEAL PRIMERS.
HB-1	HOSE BIBB	-	-	3/4"	-	-	2.5	ACORN #8151 RECESSED HOSE BOX WITH $^3\!4$ " HOSE CONNECTION AND NON-REMOVABLE BACKFLOW PREVENTER WITH WALL FRAME AND DOOR.
WHA	WATER HAMMER ARRESTER	-	-	-	-	-	-	PRECISION PLUMBING PRODUCTS WATER HAMMER ARRESTORS, HYDRAULIC DISPLACEMENT, PERMANENTLY SEALED, PISTON OPERATED, SIZED IN ACCORDANCE TO SCHEDULE:

4. ALL ACCESSIBLE LAVATORIES & SINKS TO BE PROVIDED WITH INSULATION FOR THE DRAIN & HOT WATER PIPING AS TRUEBRO KIT #101 INSULATION KIT OR EQUAL.

5. NEW PLUMBING FIXTURES AND FITTINGS SHALL NOT EXCEED THE MAXIMUM ALLOWABLE FLOW RATE SPECIFIED IN TABLE 5.303.2.3.

6. HAND-OPERATED METERING FAUCETS FOR LAVATORIES OR SINKS SHALL REMAIN OPEN FOR 10 SECONDS MINIMUM.

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## abode communities architecture

## LAEP EARLY CHILDHOOD CENTER

13928 KORNBLUM AVE. HAWTHORNE, CA 90250

Los Angeles Education

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**Abode Communities** 1149 S. Hill Street, Suite 700 Los Angeles, CA 90015 T: 213.629.2702

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DSA APPLICATION NUMBER: 03-122151 PROJECT NO: 219-22-001

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DATE REV PROGRESS SET 02.01.22 DSA PROGRESS SET 03.02.22 DSA APPLICATION SET 04.01.22 DSA BACK-CHECK SET 10.05.22 DSA BACK-CHECK SET 10.24.22

SHEET NAME:

PLUMBING SCHEDULES & CALCULATIONS


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APP: 03-122151 INC:

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SHEET NAME:

PLUMBING SITE PLAN

JT SCALE:

JT SHEET NUMBER:

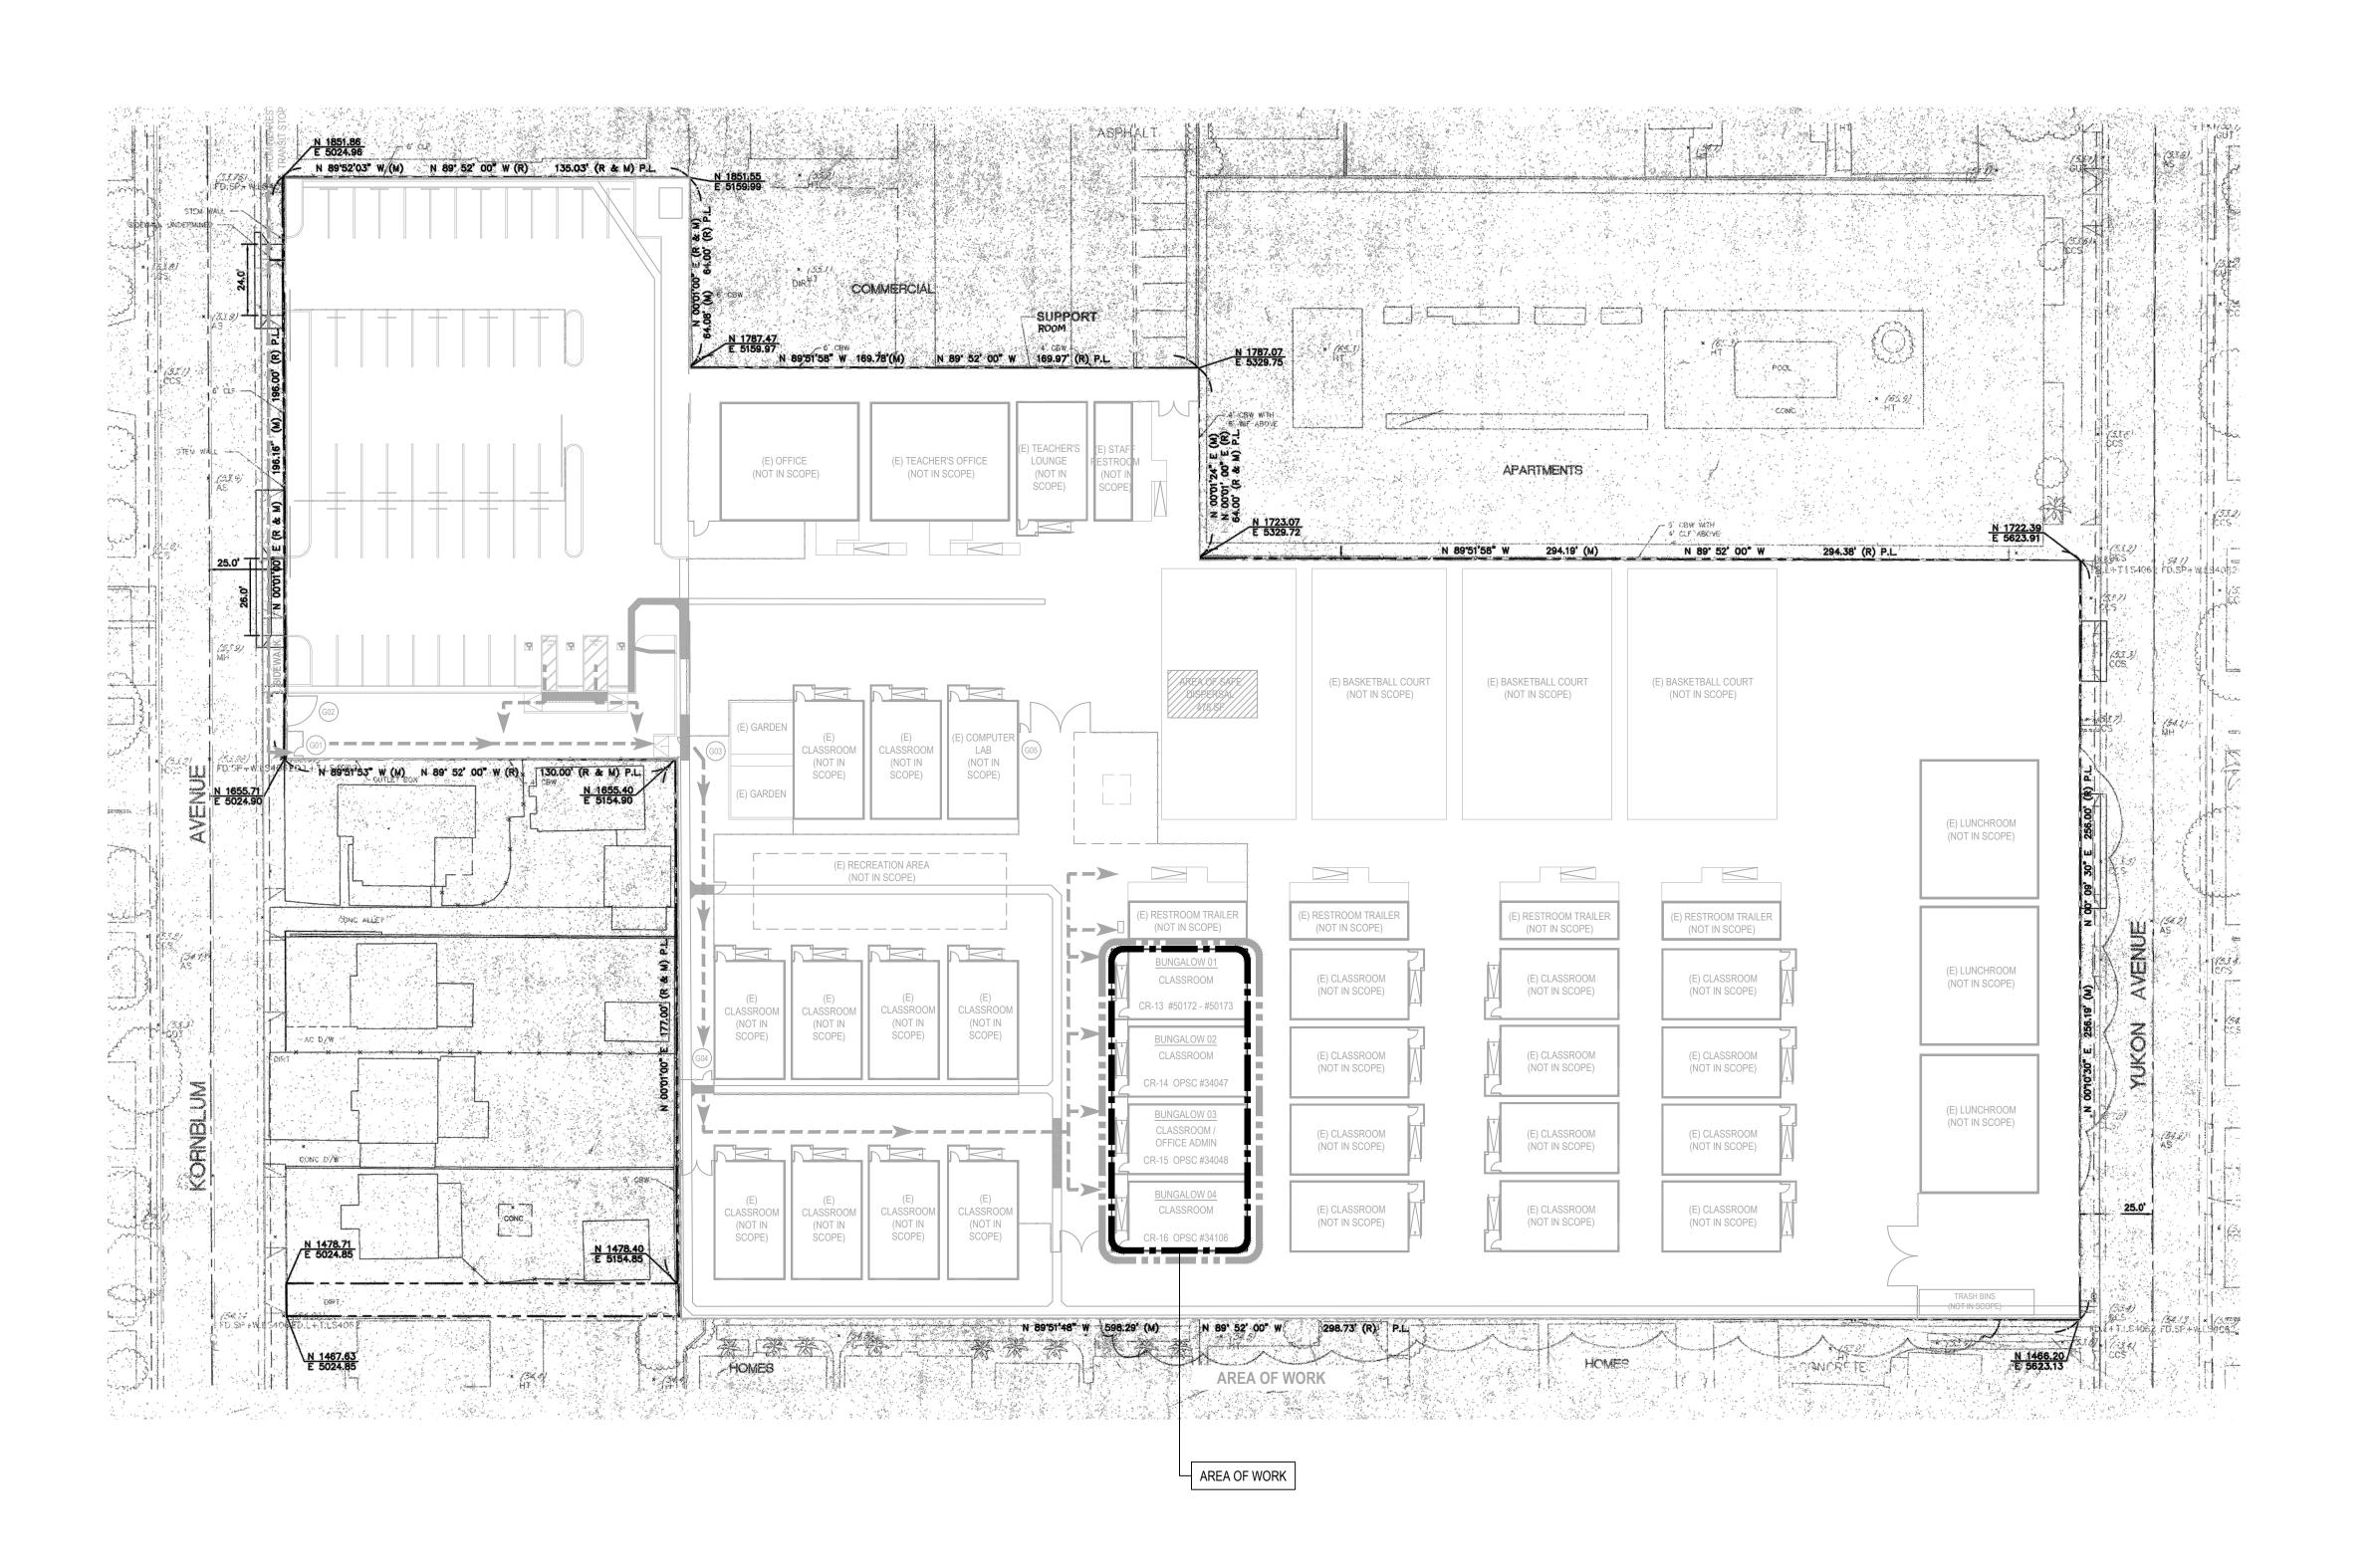
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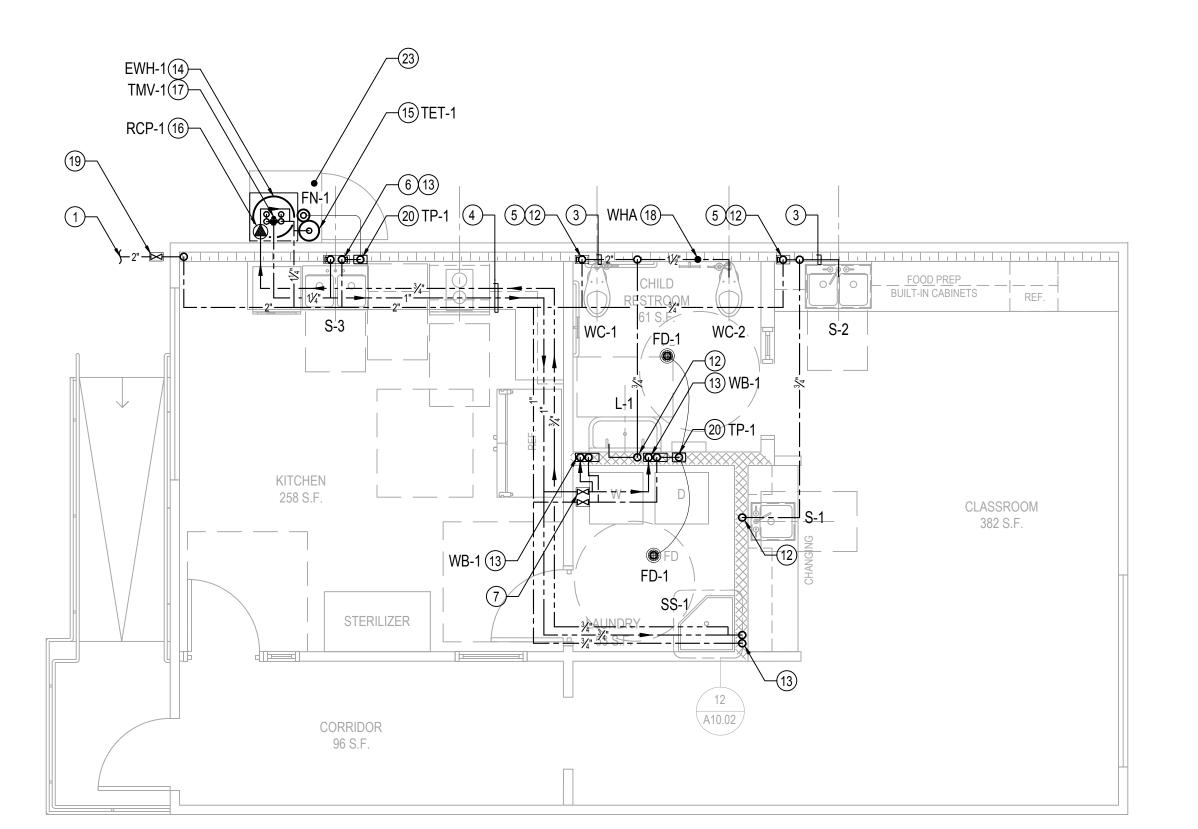
CHECKED BY

APPROVED BY

P1.00

1/32" = 1'-0"



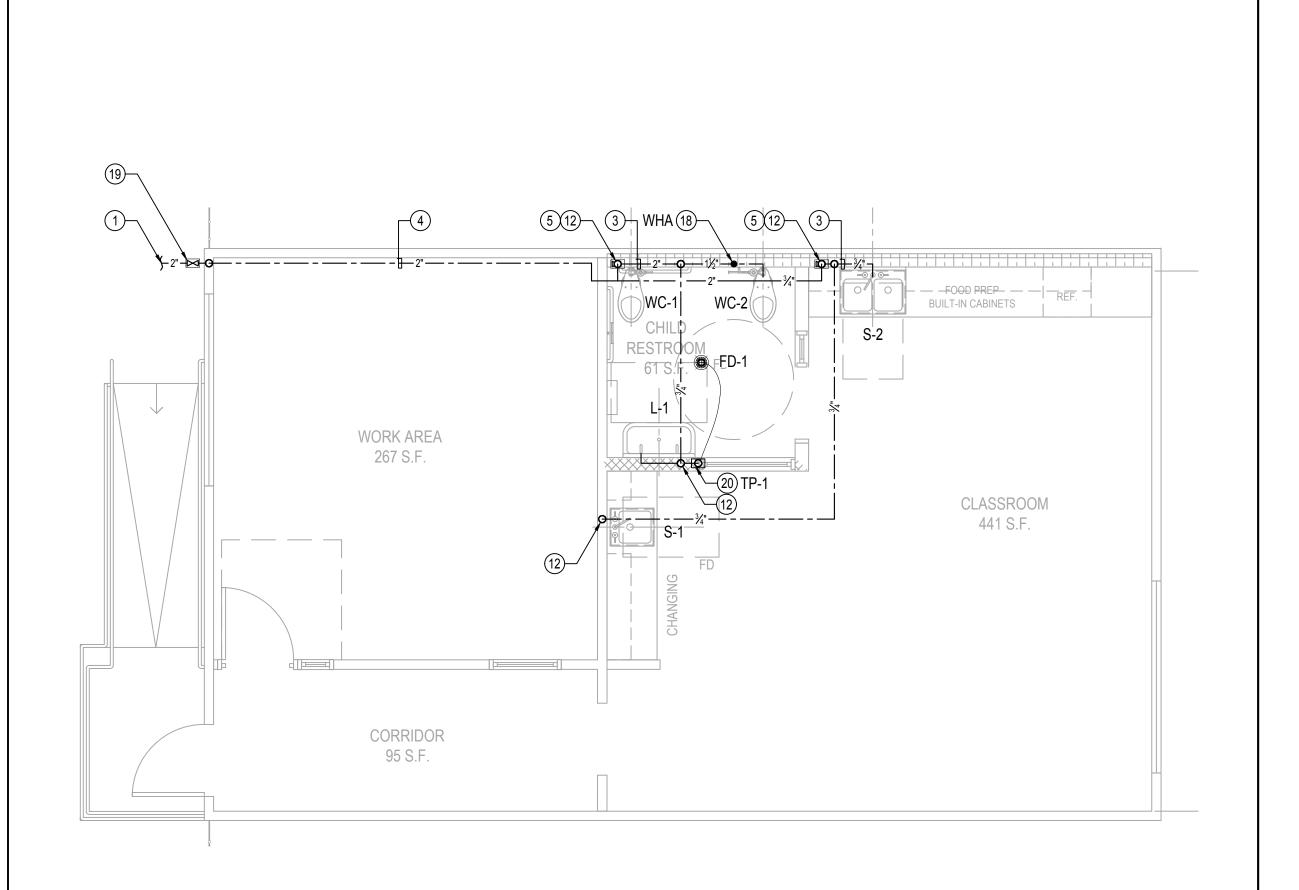

PLUMBING BUNGALOW 02 WATER & GAS PIPING PLAN

PLUMBING BUNGALOW 01 WATER & GAS PIPING PLAN


PLUMBING BUNGALOW 01 WASTE & VENT PIPING PLAN

1/4" = 1'-0"

SCALE:

SCALE:

1/4" = 1'-0"

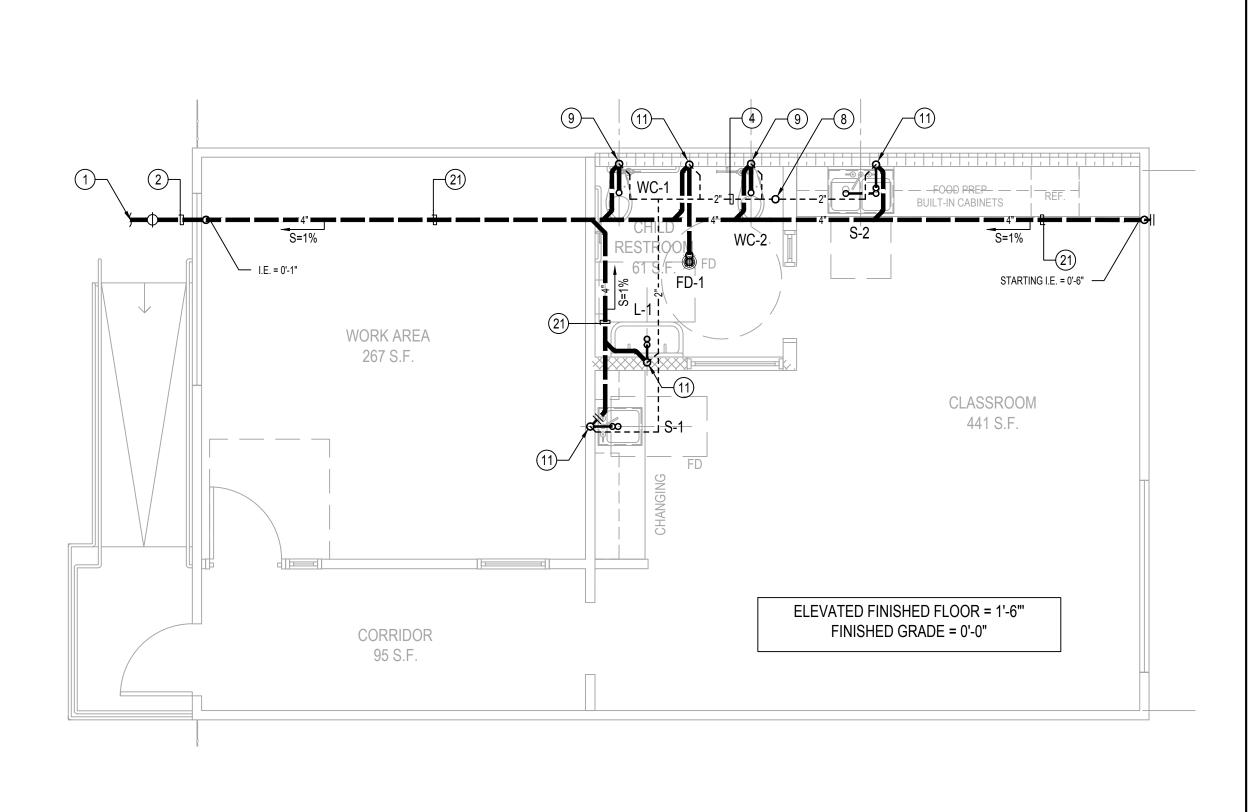


PLUMBING BUNGALOW 02 WASTE & VENT PIPING PLAN

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1/4" = 1'-0"

1/4" = 1'-0"

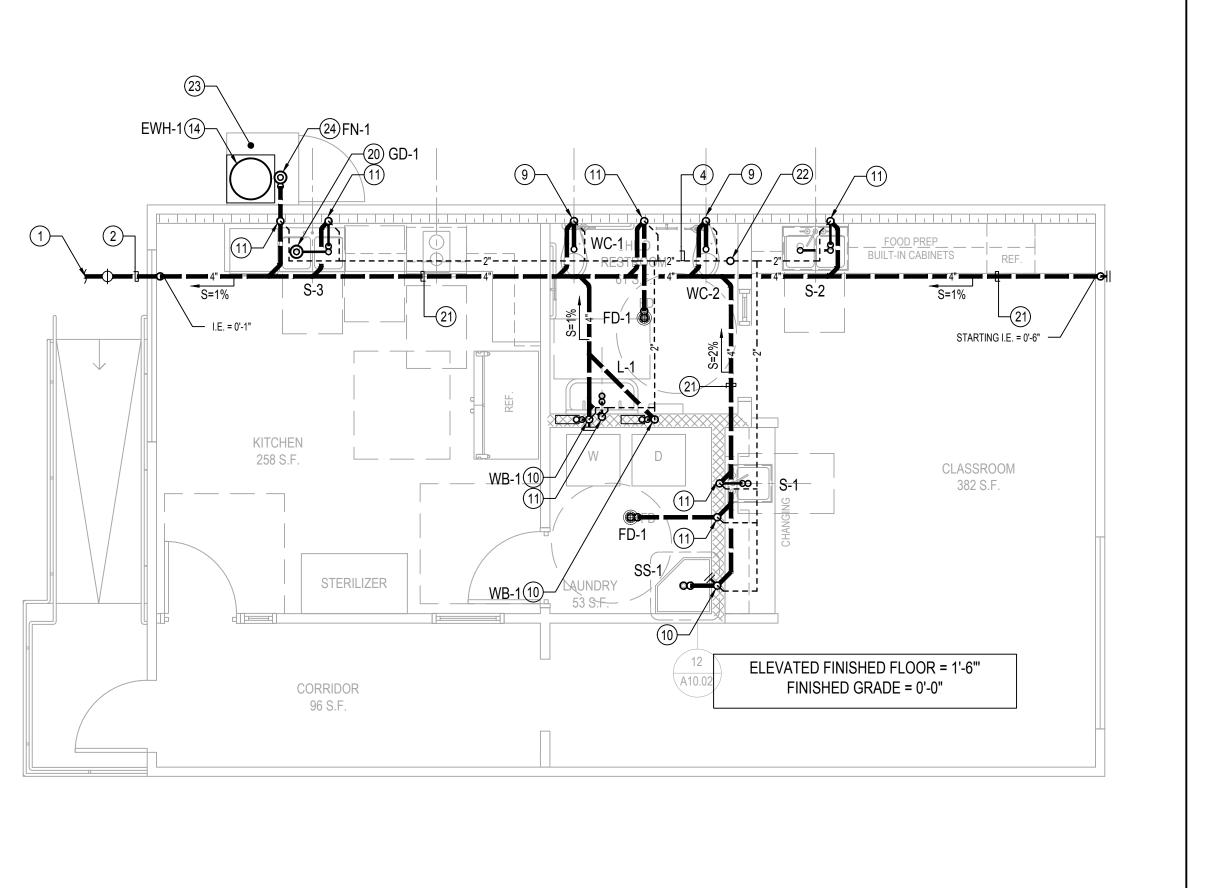

**GENERAL NOTES** 

SEE ARCHITECTURAL DRAWINGS FOR EXACT DIMENSIONS.

PROVIDE INSULATION FOR TRAPS ON ALL ADA ACCESS FIXTURES.

READ WITH SCHEMATIC RISER DIAGRAMS.

HOT WATER AND DRAIN PIPES UNDER SINKS SHALL BE INSULATED.

6 LOWER ROUGH-IN HEIGHTS FOR ALL ADA & ADAPTABLE KITCHENS.

## REFERENCE NOTES

1) SEE PLUMBING SITE PLAN FOR CONTINUATION.

(2) PIPING BELOW GRADE.

3 PIPING AT LOW LEVEL INSIDE WALL.

4 PIPING AT HIGH LEVEL INSIDE CEILING SPACE. REFER TO DETAIL 7 OF SHEET P5.01 FOR SUPPORT AND BRACING DETAIL.

5 COLD WATER SHUT-OFF VALVE AT LOW LEVEL INSIDE WALL. PROVIDE WITH ACCESS PANEL.

6 HOT AND COLD WATER SHUT-OFF VALVE AT LOW LEVEL. PROVIDE WITH ACCESS PANEL.

7 HOT AND COLD WATER SHUT-OFF VALVE AT HIGH LEVEL INSIDE CEILING SPACE. PROVIDE WITH ACCESS PANEL.

(8) 2" VENT THRU ROOF.

(9) 4" WASTE DOWN, 2" VENT UP.

(10) 3" WASTE DOWN, 2" VENT UP.

11) 2" WASTE DOWN, 2" VENT UP.

(12) COLD WATER DOWN TO SUPPLY FIXTURES.

(3) HOT AND COLD WATER DOWN TO SUPPLY FIXTURES.

ELECTRIC STORAGE TYPE WATER HEATER SET TO 140 °F. SEE DETAIL 1 SHEET P5.02 FOR DETAILS.

(15) THERMAL EXPANSION TANK.

(6) RECIRCULATING PUMP.

17) TEMPERATURE MIXING VALVE MAIN SET TO 120 °F.

(18) WATER HAMMER ARRESTOR.

DOMESTIC COLD WATER SHUT-OFF VALVE BELOW GRADE INSIDE YARD BOX.

20 ½" COLD WATER LINE DOWN TO TRAP PRIMER. RUN SEPARATE ½" COPPER LINE FROM TRAP PRIMER OUTLET UP TO FLOOR DRAIN TAILPIECE. PROVIDE ACCESS PANEL TO TRAP PRIMER.

(21) PIPING ABOVE GROUND UNDER ELEVATED FLOOR.

② 3" VENT THRU ROOF.

(23) WATER HEATER ENCLOSURE TO BE PROVIDED BY ARCHITECT.

6"HIGH X 6"DIA. FUNNEL DRAIN WITH 2" WASTE STRAPPED TO

WATER HEATER STAND.

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DATE: 11/02/2022

# abode communities architecture

PROJECT:

## LAEP EARLY CHILDHOOD CENTER

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DSA APPLICATION NUMBER: 03-122151
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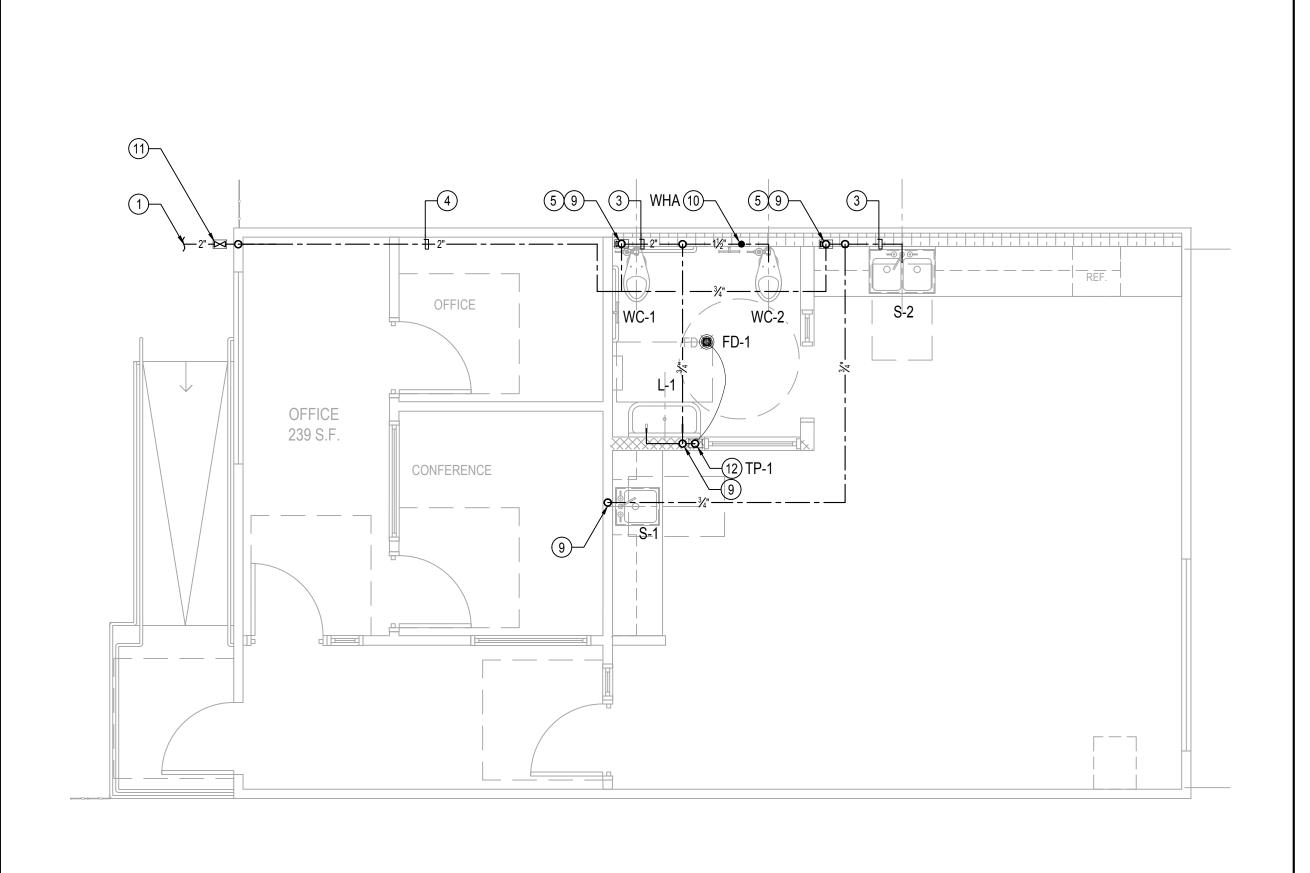
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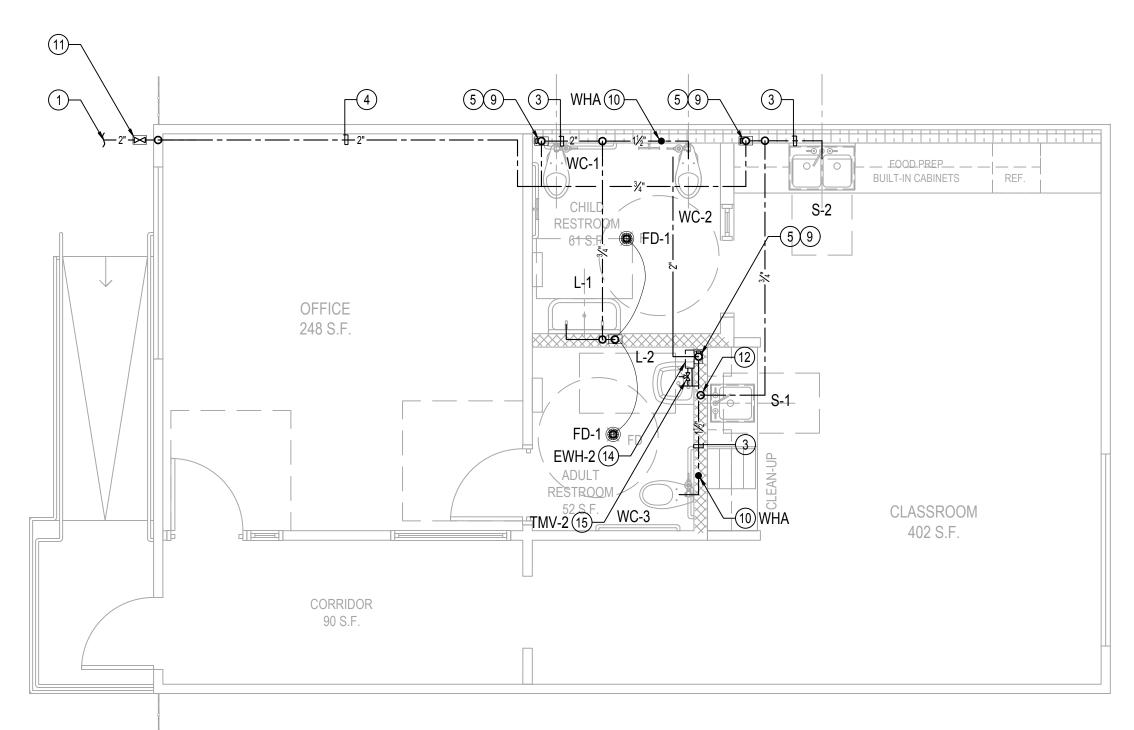
PLUMBING BUNGALOW 01 & 02 PIPING PLANS

SCALE: AS NOTED

SHEET NUMBER: P2.01

DRAWN BY JT
DESIGNED BY JT
CHECKED BY JT
APPROVED BY PB





PLUMBING BUNGALOW 03 WATER & GAS PIPING PLAN

PLUMBING BUNGALOW 03 WASTE & VENT PIPING PLAN

# WCZ SZ SENG SENGRICE TO THE FINANCE FLOOR = 1'-S" FINANCE ORADE = 0'-0' T

1/4" = 1'-0"


SCALE:

1/4" = 1'-0"

PLUMBING BUNGALOW 04 WATER & GAS PIPING PLAN

PLUMBING BUNGALOW 04 WASTE & VENT PIPING PLAN

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## **GENERAL NOTES**

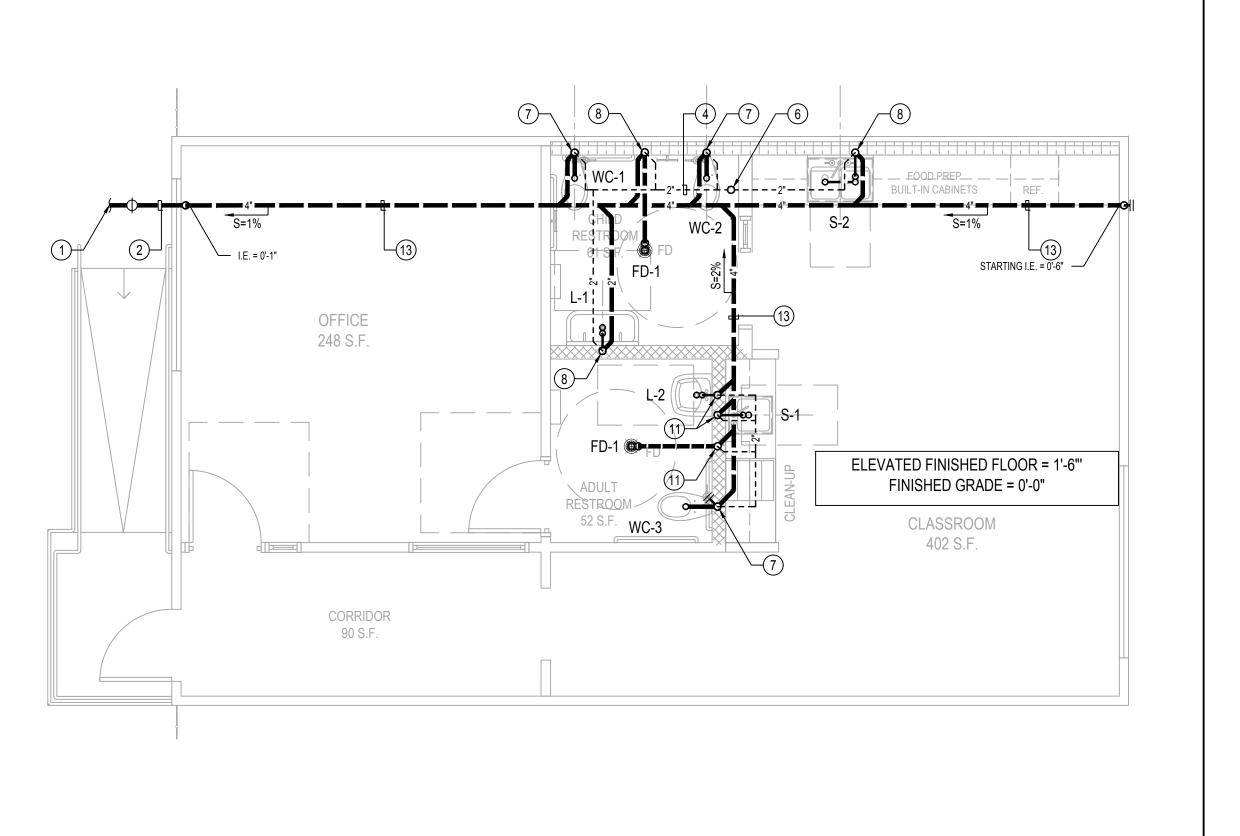- 1 SEE ARCHITECTURAL DRAWINGS FOR EXACT DIMENSIONS.
- PROVIDE INSULATION FOR TRAPS ON ALL ADA ACCESS FIXTURES.
- READ WITH SCHEMATIC RISER DIAGRAMS.
- 65 HOT WATER AND DRAIN PIPES UNDER SINKS SHALL BE INSULATED.
- 6 LOWER ROUGH-IN HEIGHTS FOR ALL ADA & ADAPTABLE KITCHENS.

## REFERENCE NOTES

- 1) SEE PLUMBING SITE PLAN FOR CONTINUATION.
- (2) PIPING BELOW GRADE.
- 3 PIPING AT LOW LEVEL INSIDE WALL.
- 4 PIPING AT HIGH LEVEL INSIDE CEILING SPACE. REFER TO DETAIL 7 OF SHEET P5.01 FOR SUPPORT AND BRACING DETAIL.
- 5 COLD WATER SHUT-OFF VALVE AT LOW LEVEL INSIDE WALL. PROVIDE WITH ACCESS PANEL.
- 6 2" VENT THRU ROOF.

1/4" = 1'-0"

SCALE:

1/4" = 1'-0"

- (7) 4" WASTE DOWN, 2" VENT UP.
- 8) 2" WASTE DOWN, 2" VENT UP.
- (9) COLD WATER DOWN TO SUPPLY FIXTURES.
- (10) WATER HAMMER ARRESTOR.
- DOMESTIC COLD WATER SHUT-OFF VALVE BELOW GRADE INSIDE YARD BOX.
- 12) ½" COLD WATER LINE DOWN TO TRAP PRIMER. RUN SEPARATE ½" COPPER LINE FROM TRAP PRIMER OUTLET UP TO FLOOR DRAIN TAILPIECE. PROVIDE ACCESS PANEL TO TRAP PRIMER.
- 13 PIPING ABOVE GROUND UNDER ELEVATED FLOOR.
- (14) INSTANTANEOUS WATER HEATER. SEE DETAIL 4 SHEET P5.02 FOR DETAILS.
- POINT-OF-USE THERMOSTATIC MIXING VALVE SERVING LAVATORY, SET AT 120°F.

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## LAEP EARLY CHILDHOOD CENTER

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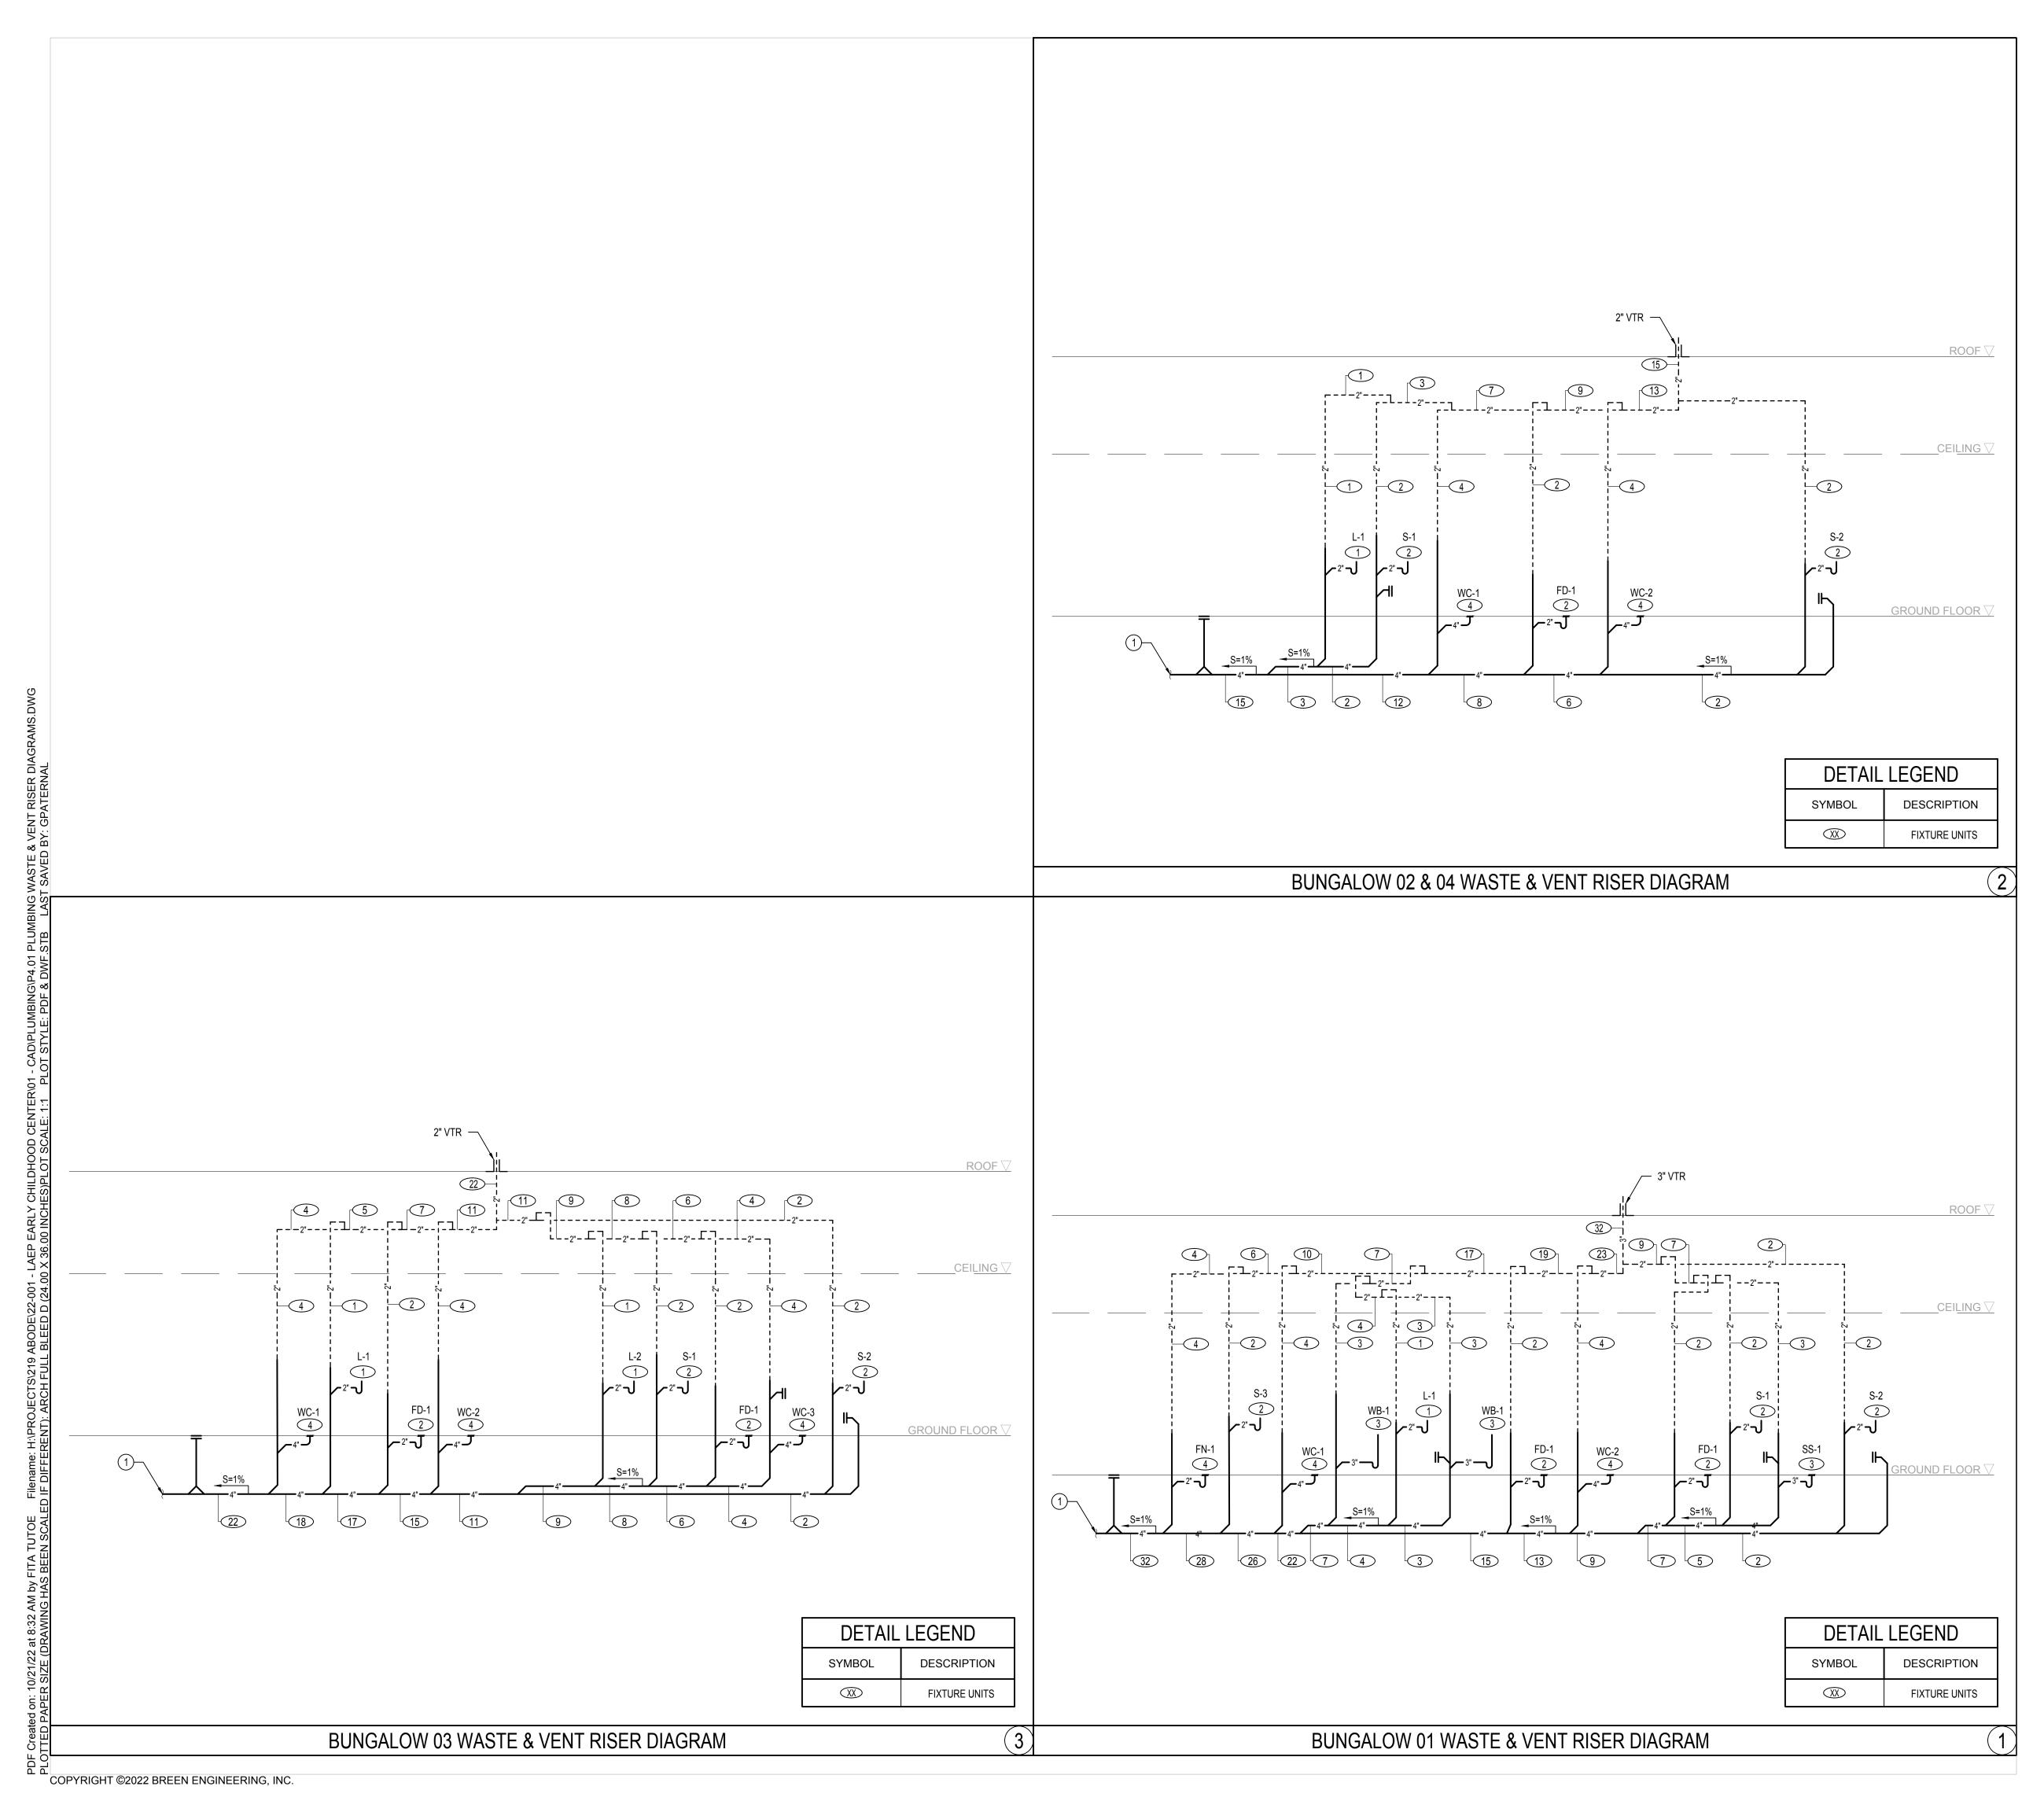
SHEET NAME:

PLUMBING BUNGALOW 03 & 04 PIPING PLANS

SCALE: AS NOTED

SHEET NUMBER:

P2.02



## **GENERAL NOTES**

DRAWINGS ARE DIAGRAMMATIC AND DOES NOT REPRESENT ACTUAL CONNECTIONS.

## REFERENCE NOTES

1 4" BUILDING SEWER LATERAL TO CONNECT TO ONSITE SEWER SYSTEM. SEE PLUMBING SITE PLAN FOR CONTINUATION.

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SHEET NAME:

PLUMBING WASTE & VENT RISER DIAGRAMS

SCALE: N.T.S.


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DESIGNED BY

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APPROVED BY

SHEET NUMBER:

P4.01

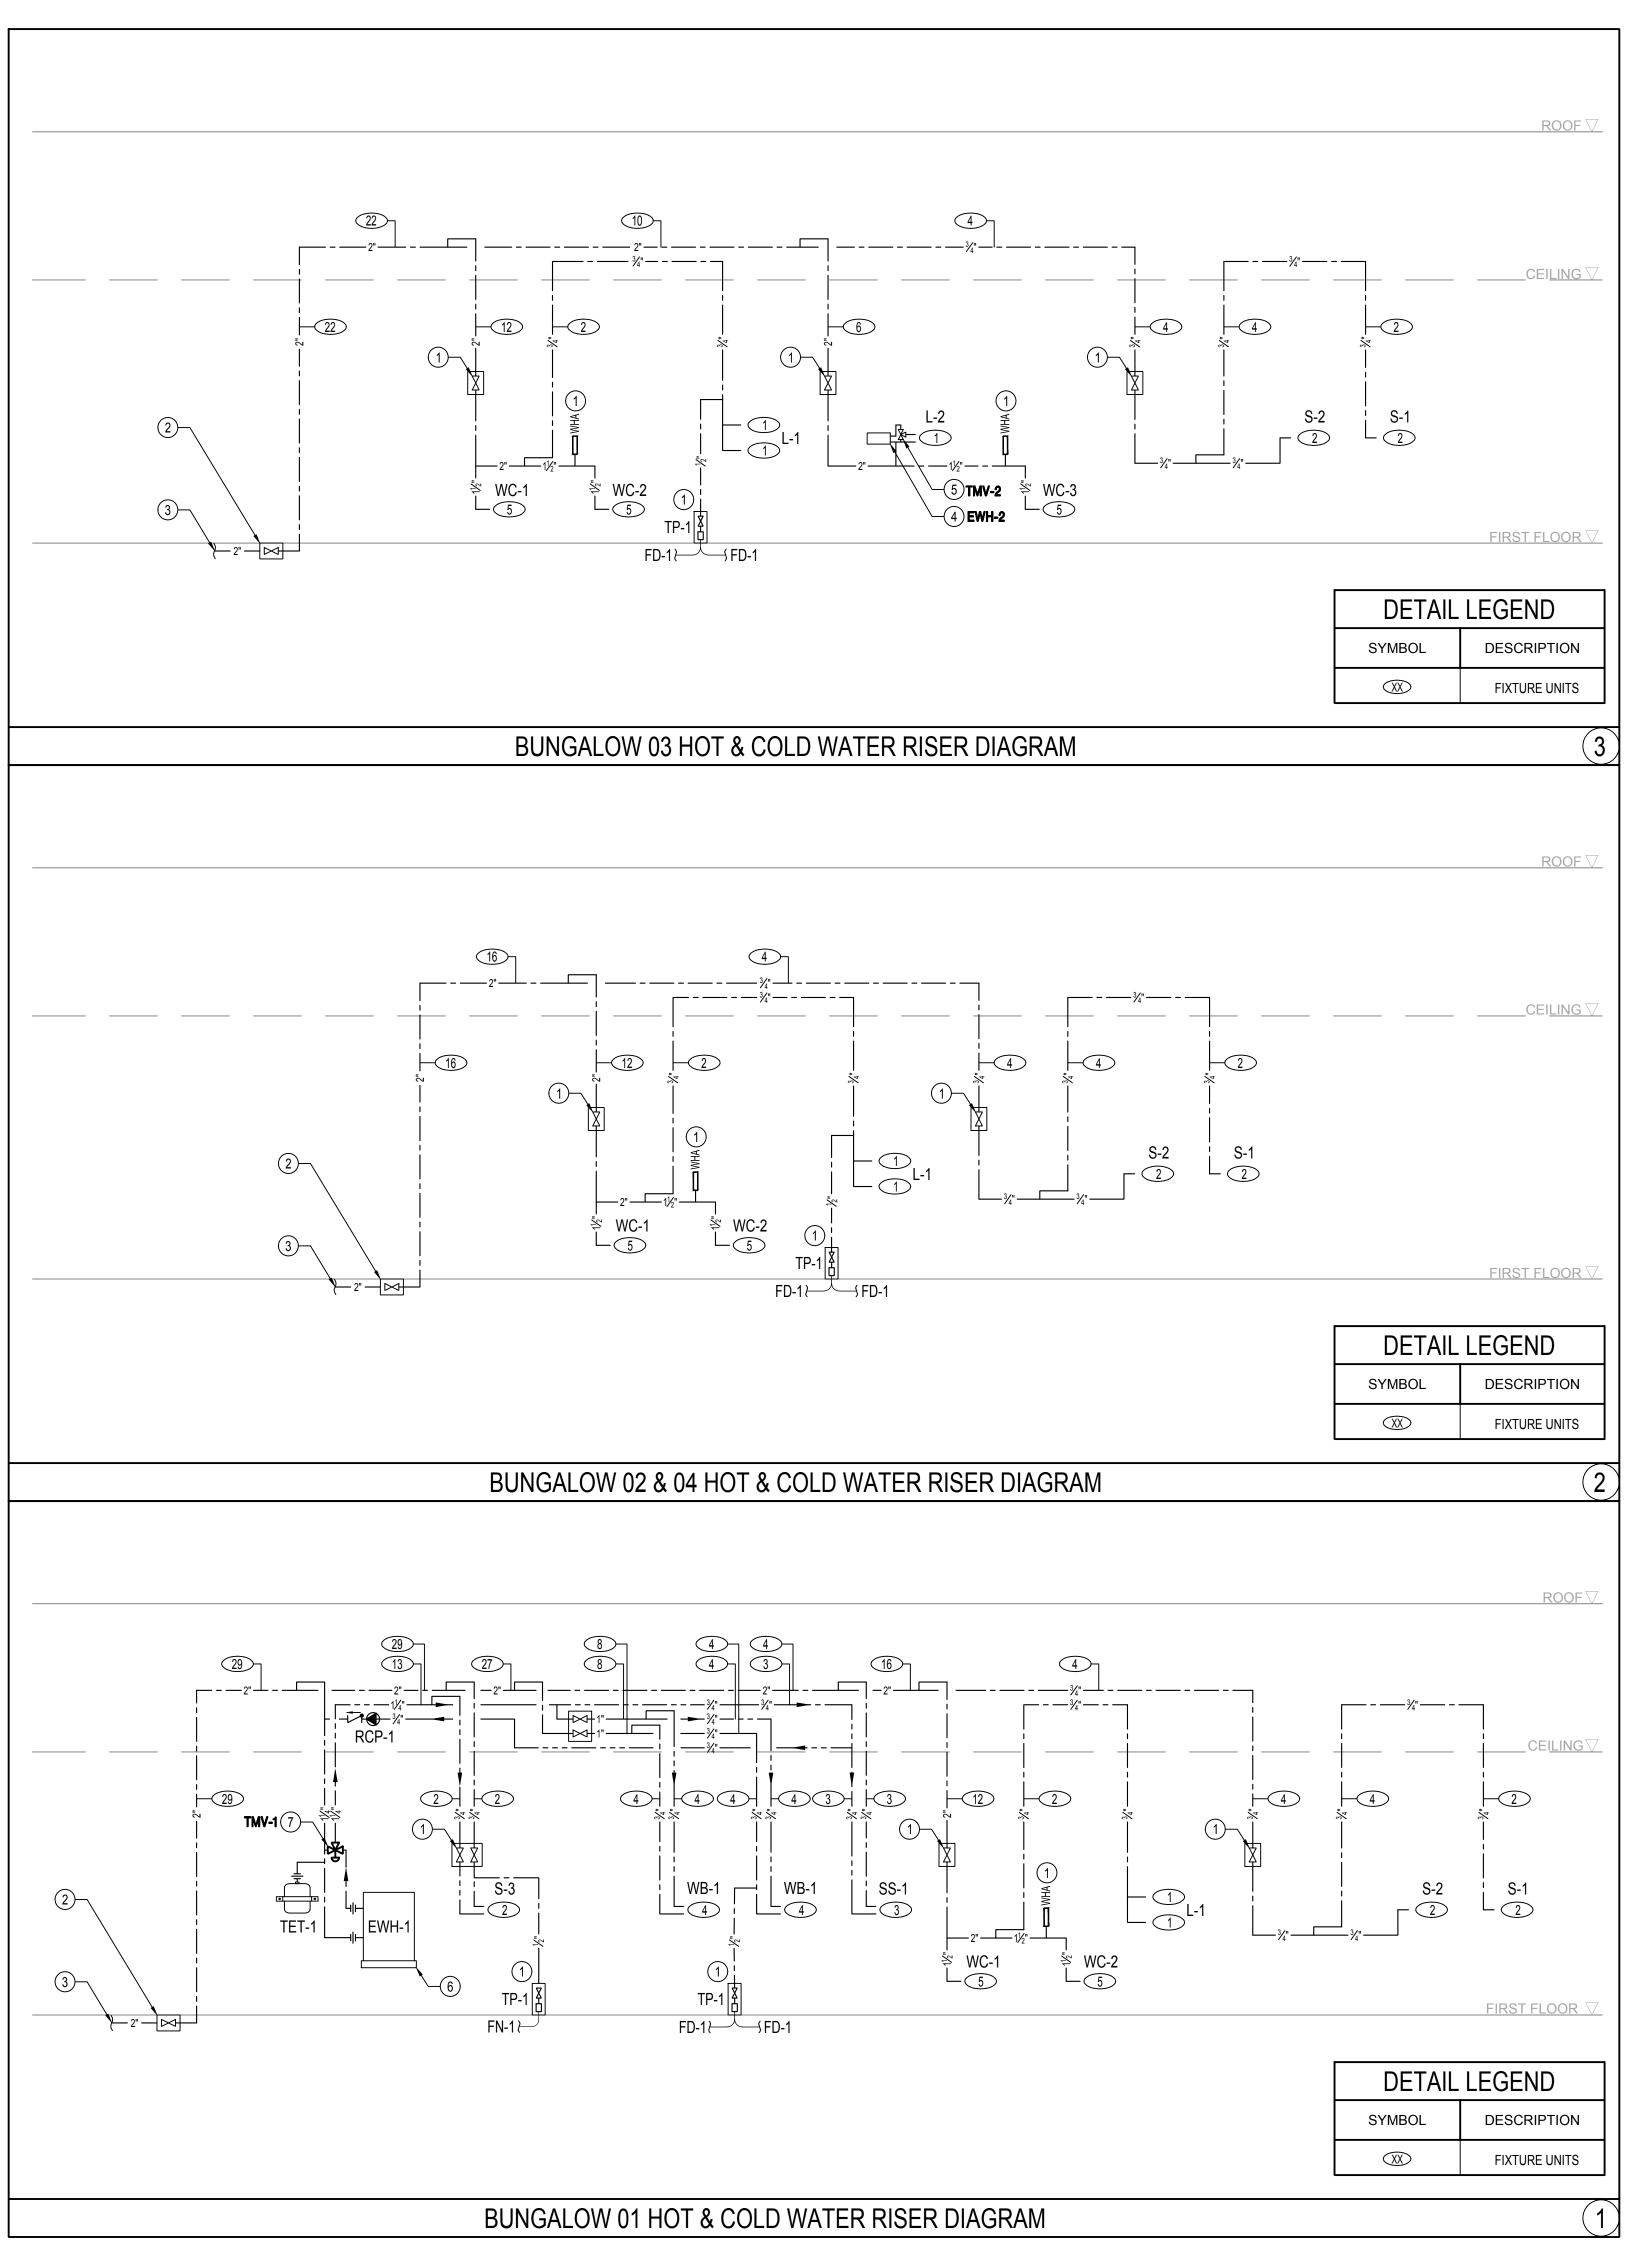

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## **GENERAL NOTES**

DRAWINGS ARE DIAGRAMMATIC AND DOES NOT REPRESENT ACTUAL CONNECTIONS.

## REFERENCE NOTES

- 1) PROVIDE WITH ACCESS PANEL.
- 2 DOMESTIC COLD WATER SHUT-OFF VALVE BELOW GRADE INSIDE YARD BOX.
- 3 SEE PLUMBING SITE PLAN FOR CONTINUATION.
- (4) INSTANTANEOUS WATER HEATER BELOW LAVATORY. SEE DETAIL 4/P5.02.
- 5 POINT-OF-USE THERMOSTATIC MIXING VALVE BELOW SINK, SET AT 120°F.
- 6 ELECTRIC STORAGE TYPE WATER HEATER SET TO 140 °F. SEE DETAIL 1 SHEET P5.02 FOR DETAILS.

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(7) TEMPERATURE MIXING VALVE MAIN SET TO 120 °F.

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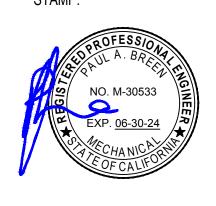
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WWW.BREENENG.COM
DSA APPLICATION NUMBER: 03-122151

PROJECT NO: 219-22-001

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CTAM



	DATE	REV
PROGRESS SET	02.01.22	
DSA PROGRESS SET	03.02.22	
DSA APPLICATION SET	04.01.22	
DSA BACK-CHECK SET	10.05.22	
DSA BACK-CHECK SET	10.24.22	


SHEET NAME:


PLUMBING HOT & COLD WATER RISER DIAGRAMS

SCALE: N.T.S.

SHEET NUMBER:

P4.02

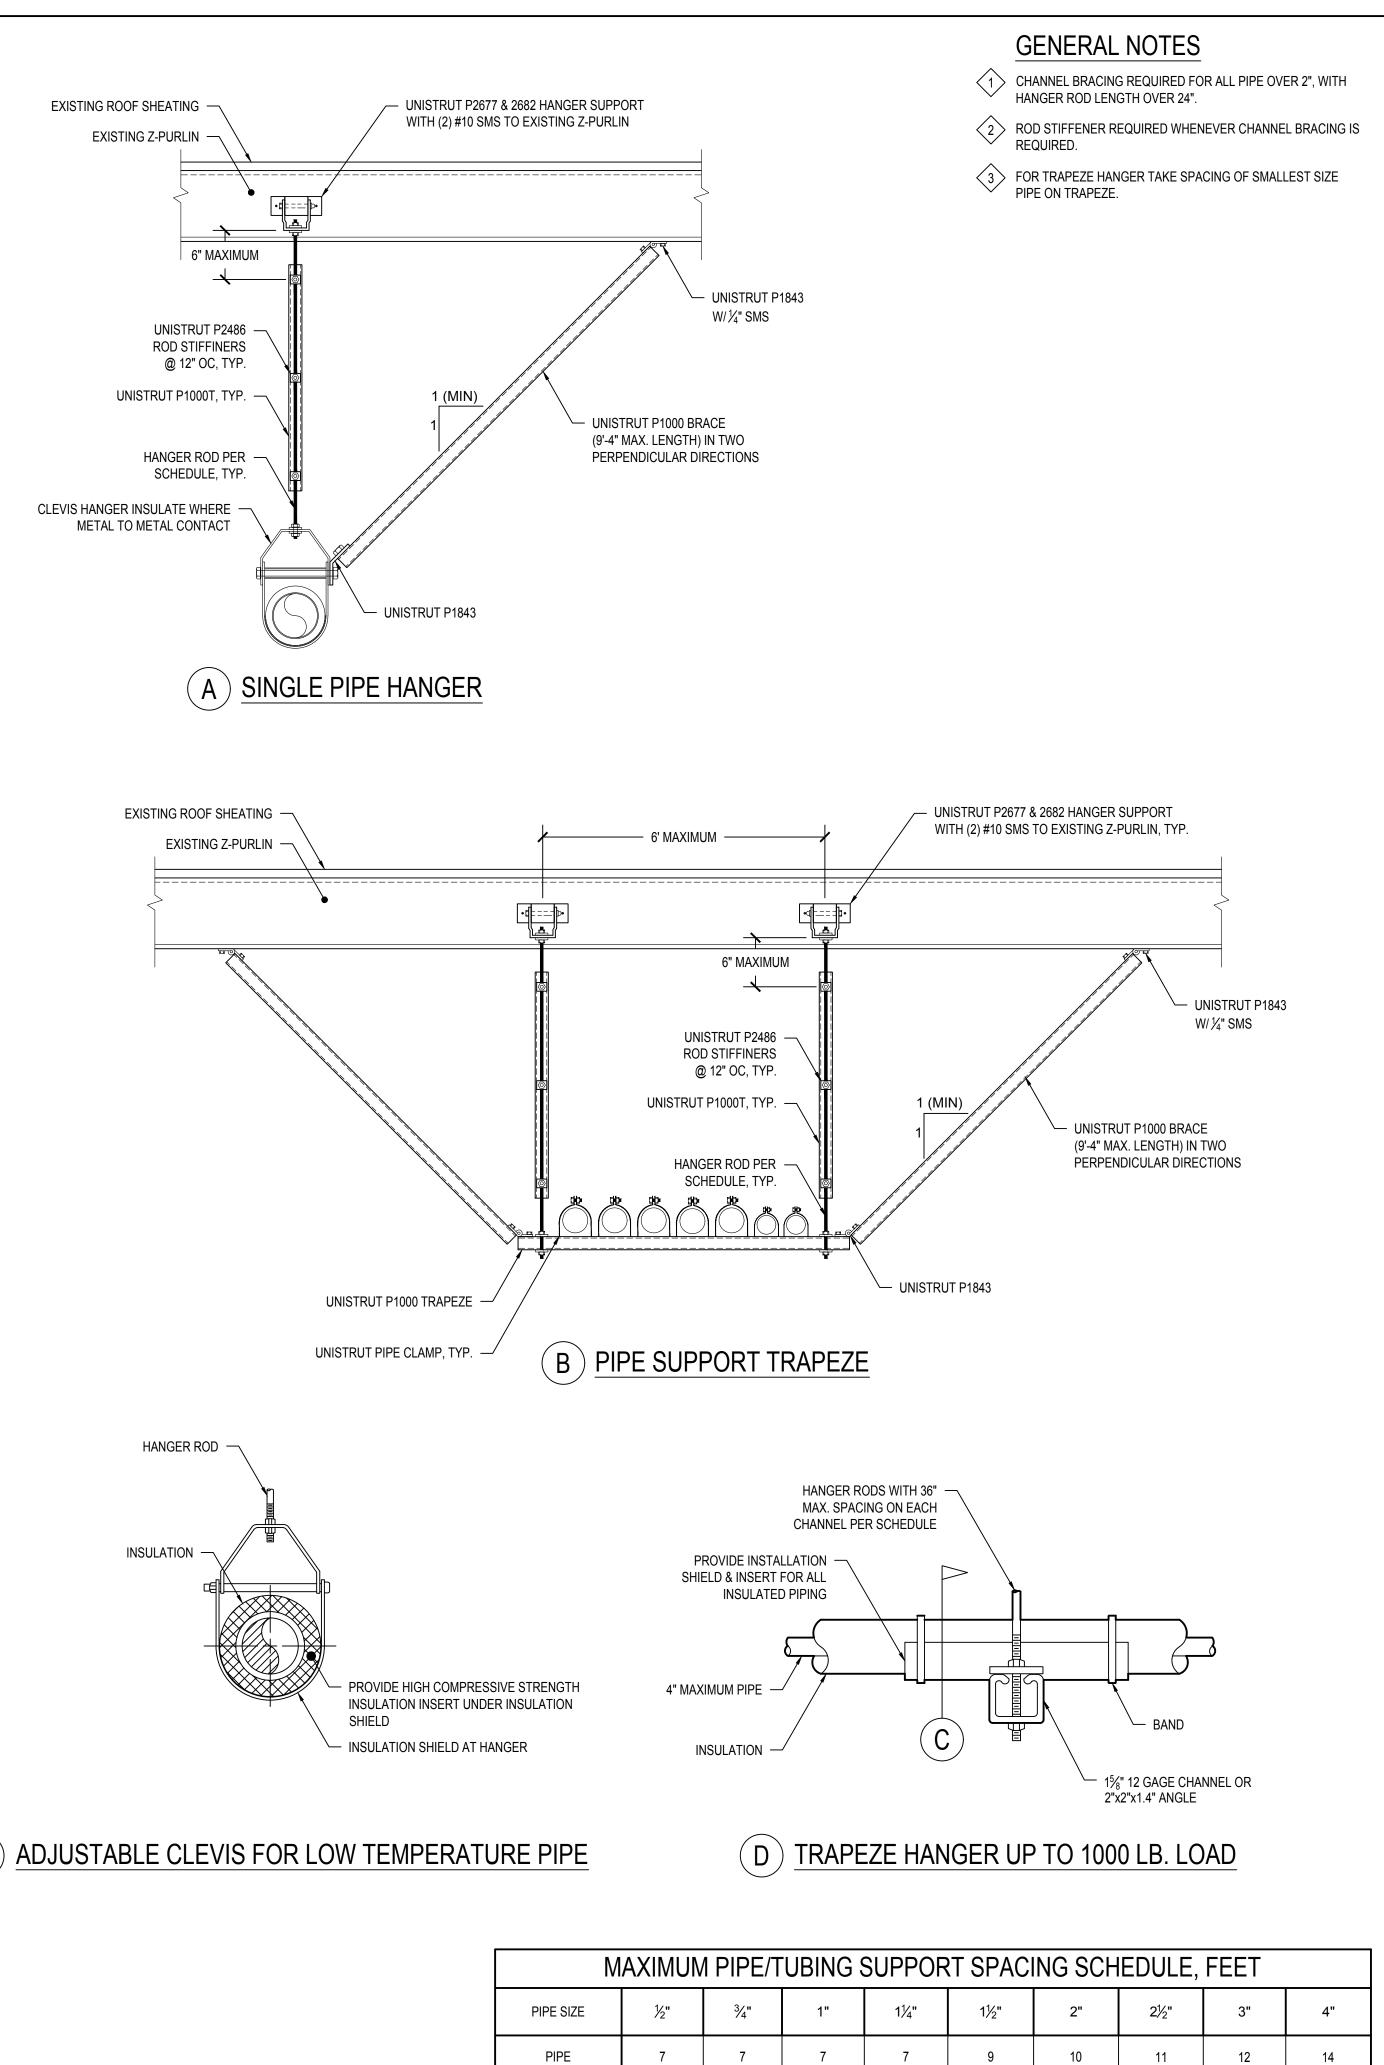

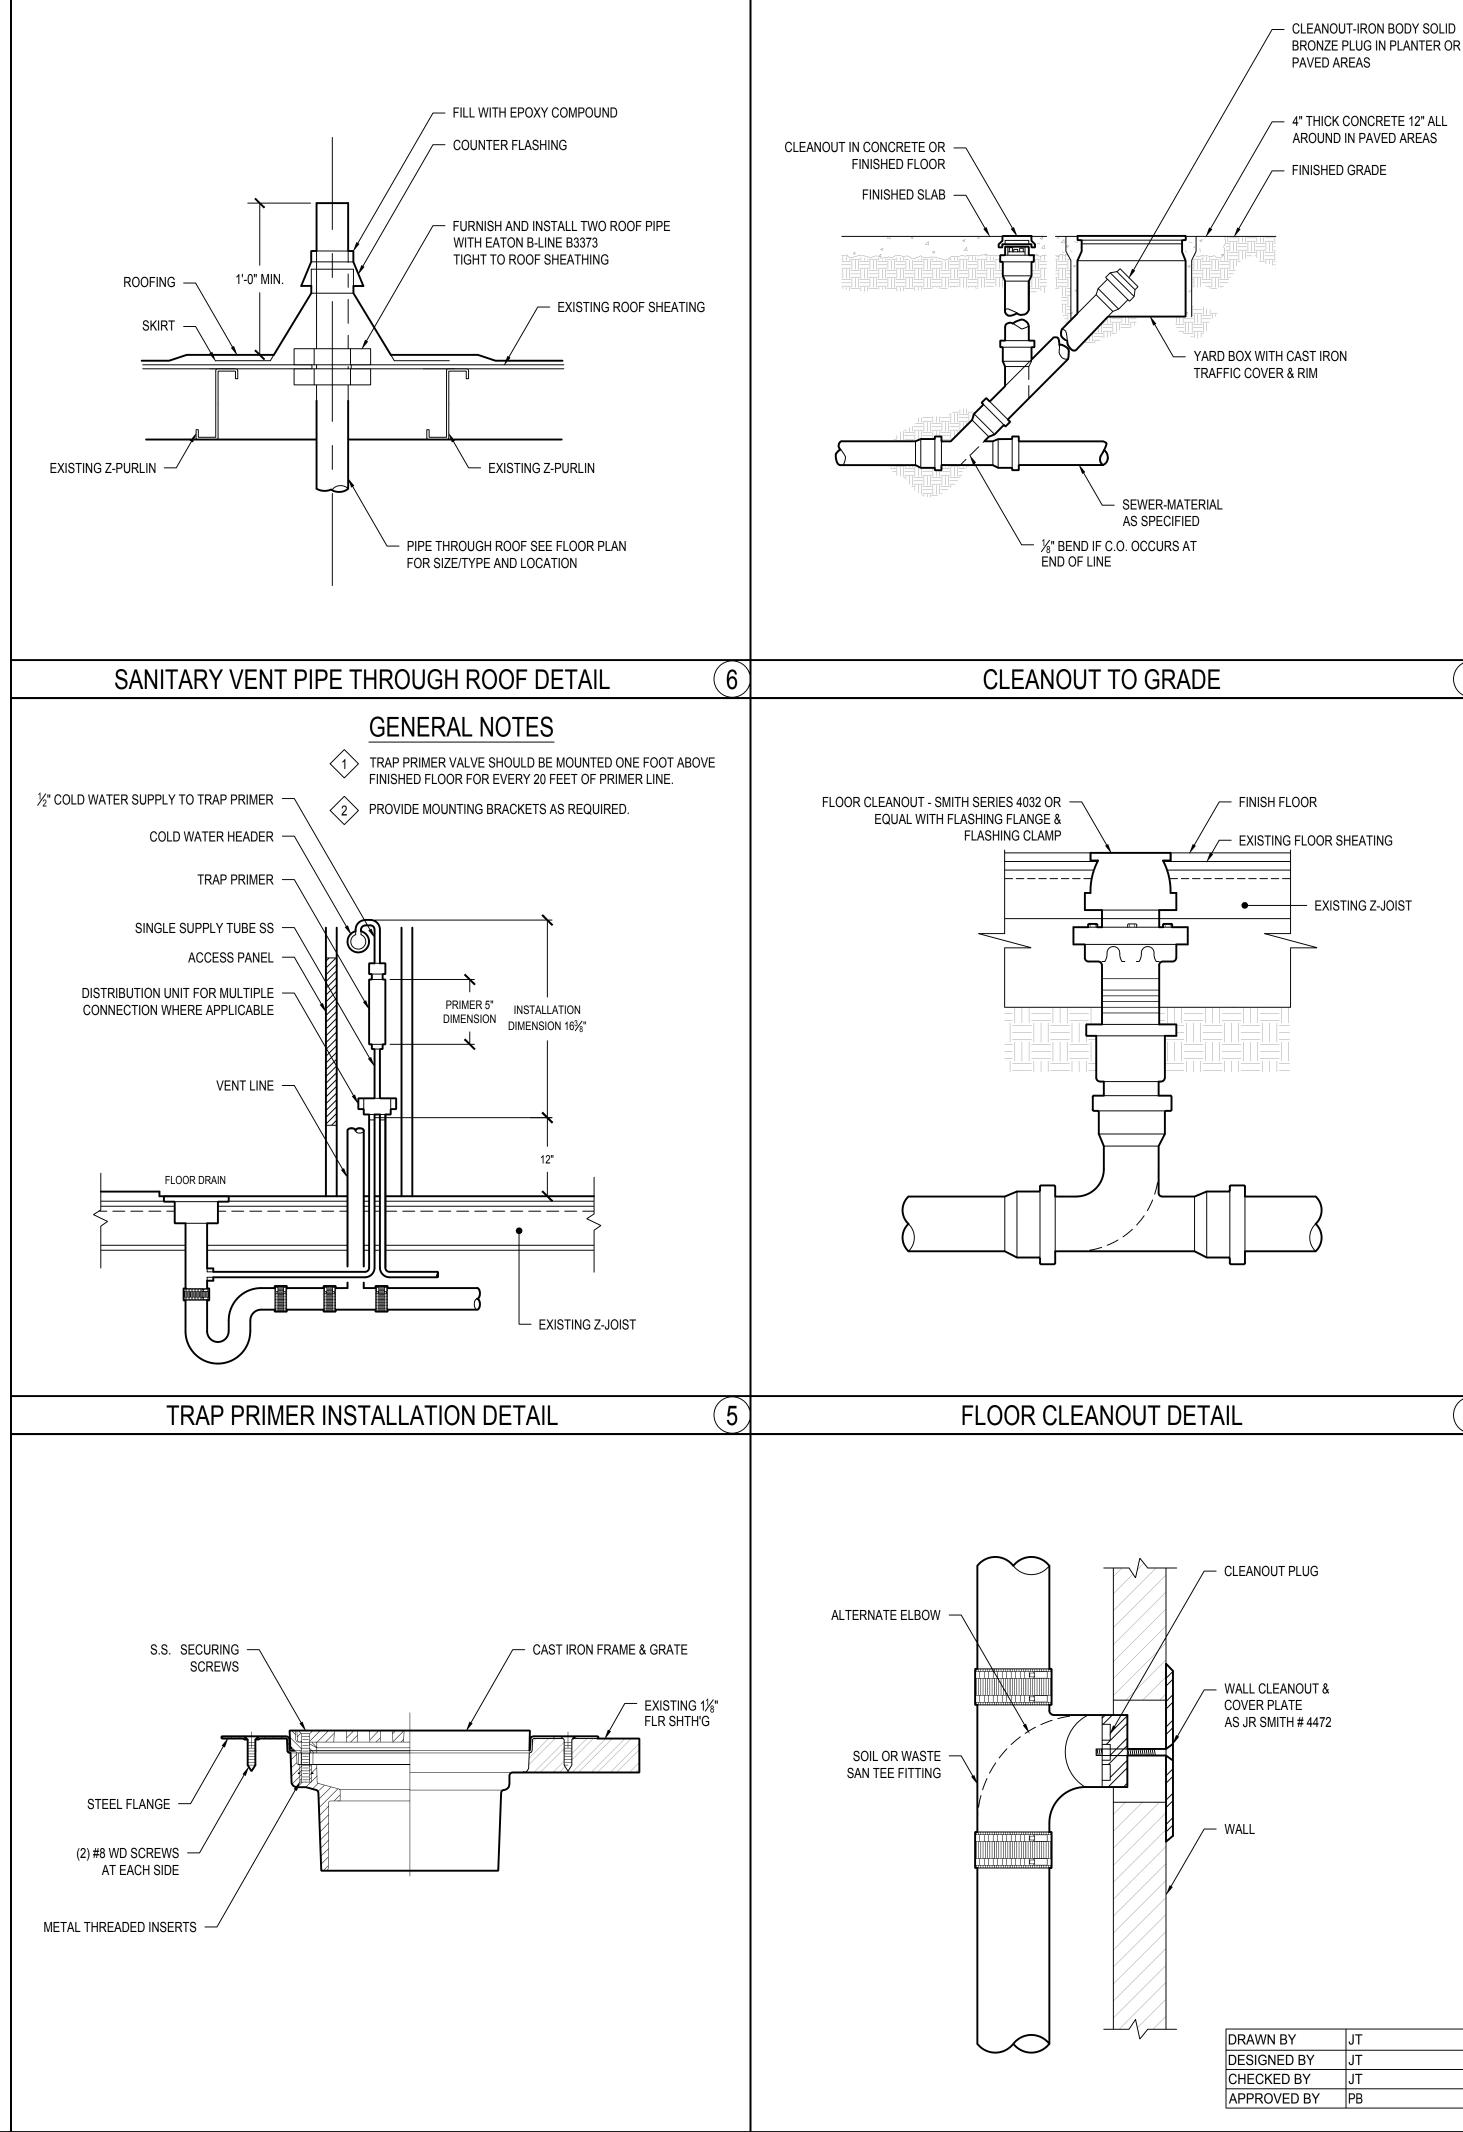

FLOOR DRAIN DETAIL

IDENTIFICATION STAMP DIV. OF THE STATE ARCHITECT

APP: 03-122151 INC:

REVIEWED FOR

SS FLS ACS D

DATE: 11/02/2022

# abode communities architecture

PROJECT:

## LAEP EARLY CHILDHOOD CENTER

13928 KORNBLUM AVE. HAWTHORNE, CA 90250

CLIENT:

Los Angeles Education

Partnership 1541 Wilshire Blvd., Suite 200 Los Angeles, CA 90017 T: 213.622.5237

ARCHITECT:

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OSA BACK-CHECK SET	10.05.22	
SA BACK-CHECK SET	10.24.22	
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SHEET NAME:
PLUMBING DETAILS - SHEET ONE

SCALE: N.T.S.

SHEET NUMBER:


WALL CLEANOUT DETAIL

P5.01

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## abode communities architecture

## LAEP EARLY CHILDHOOD CENTER

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SHEET NAME:

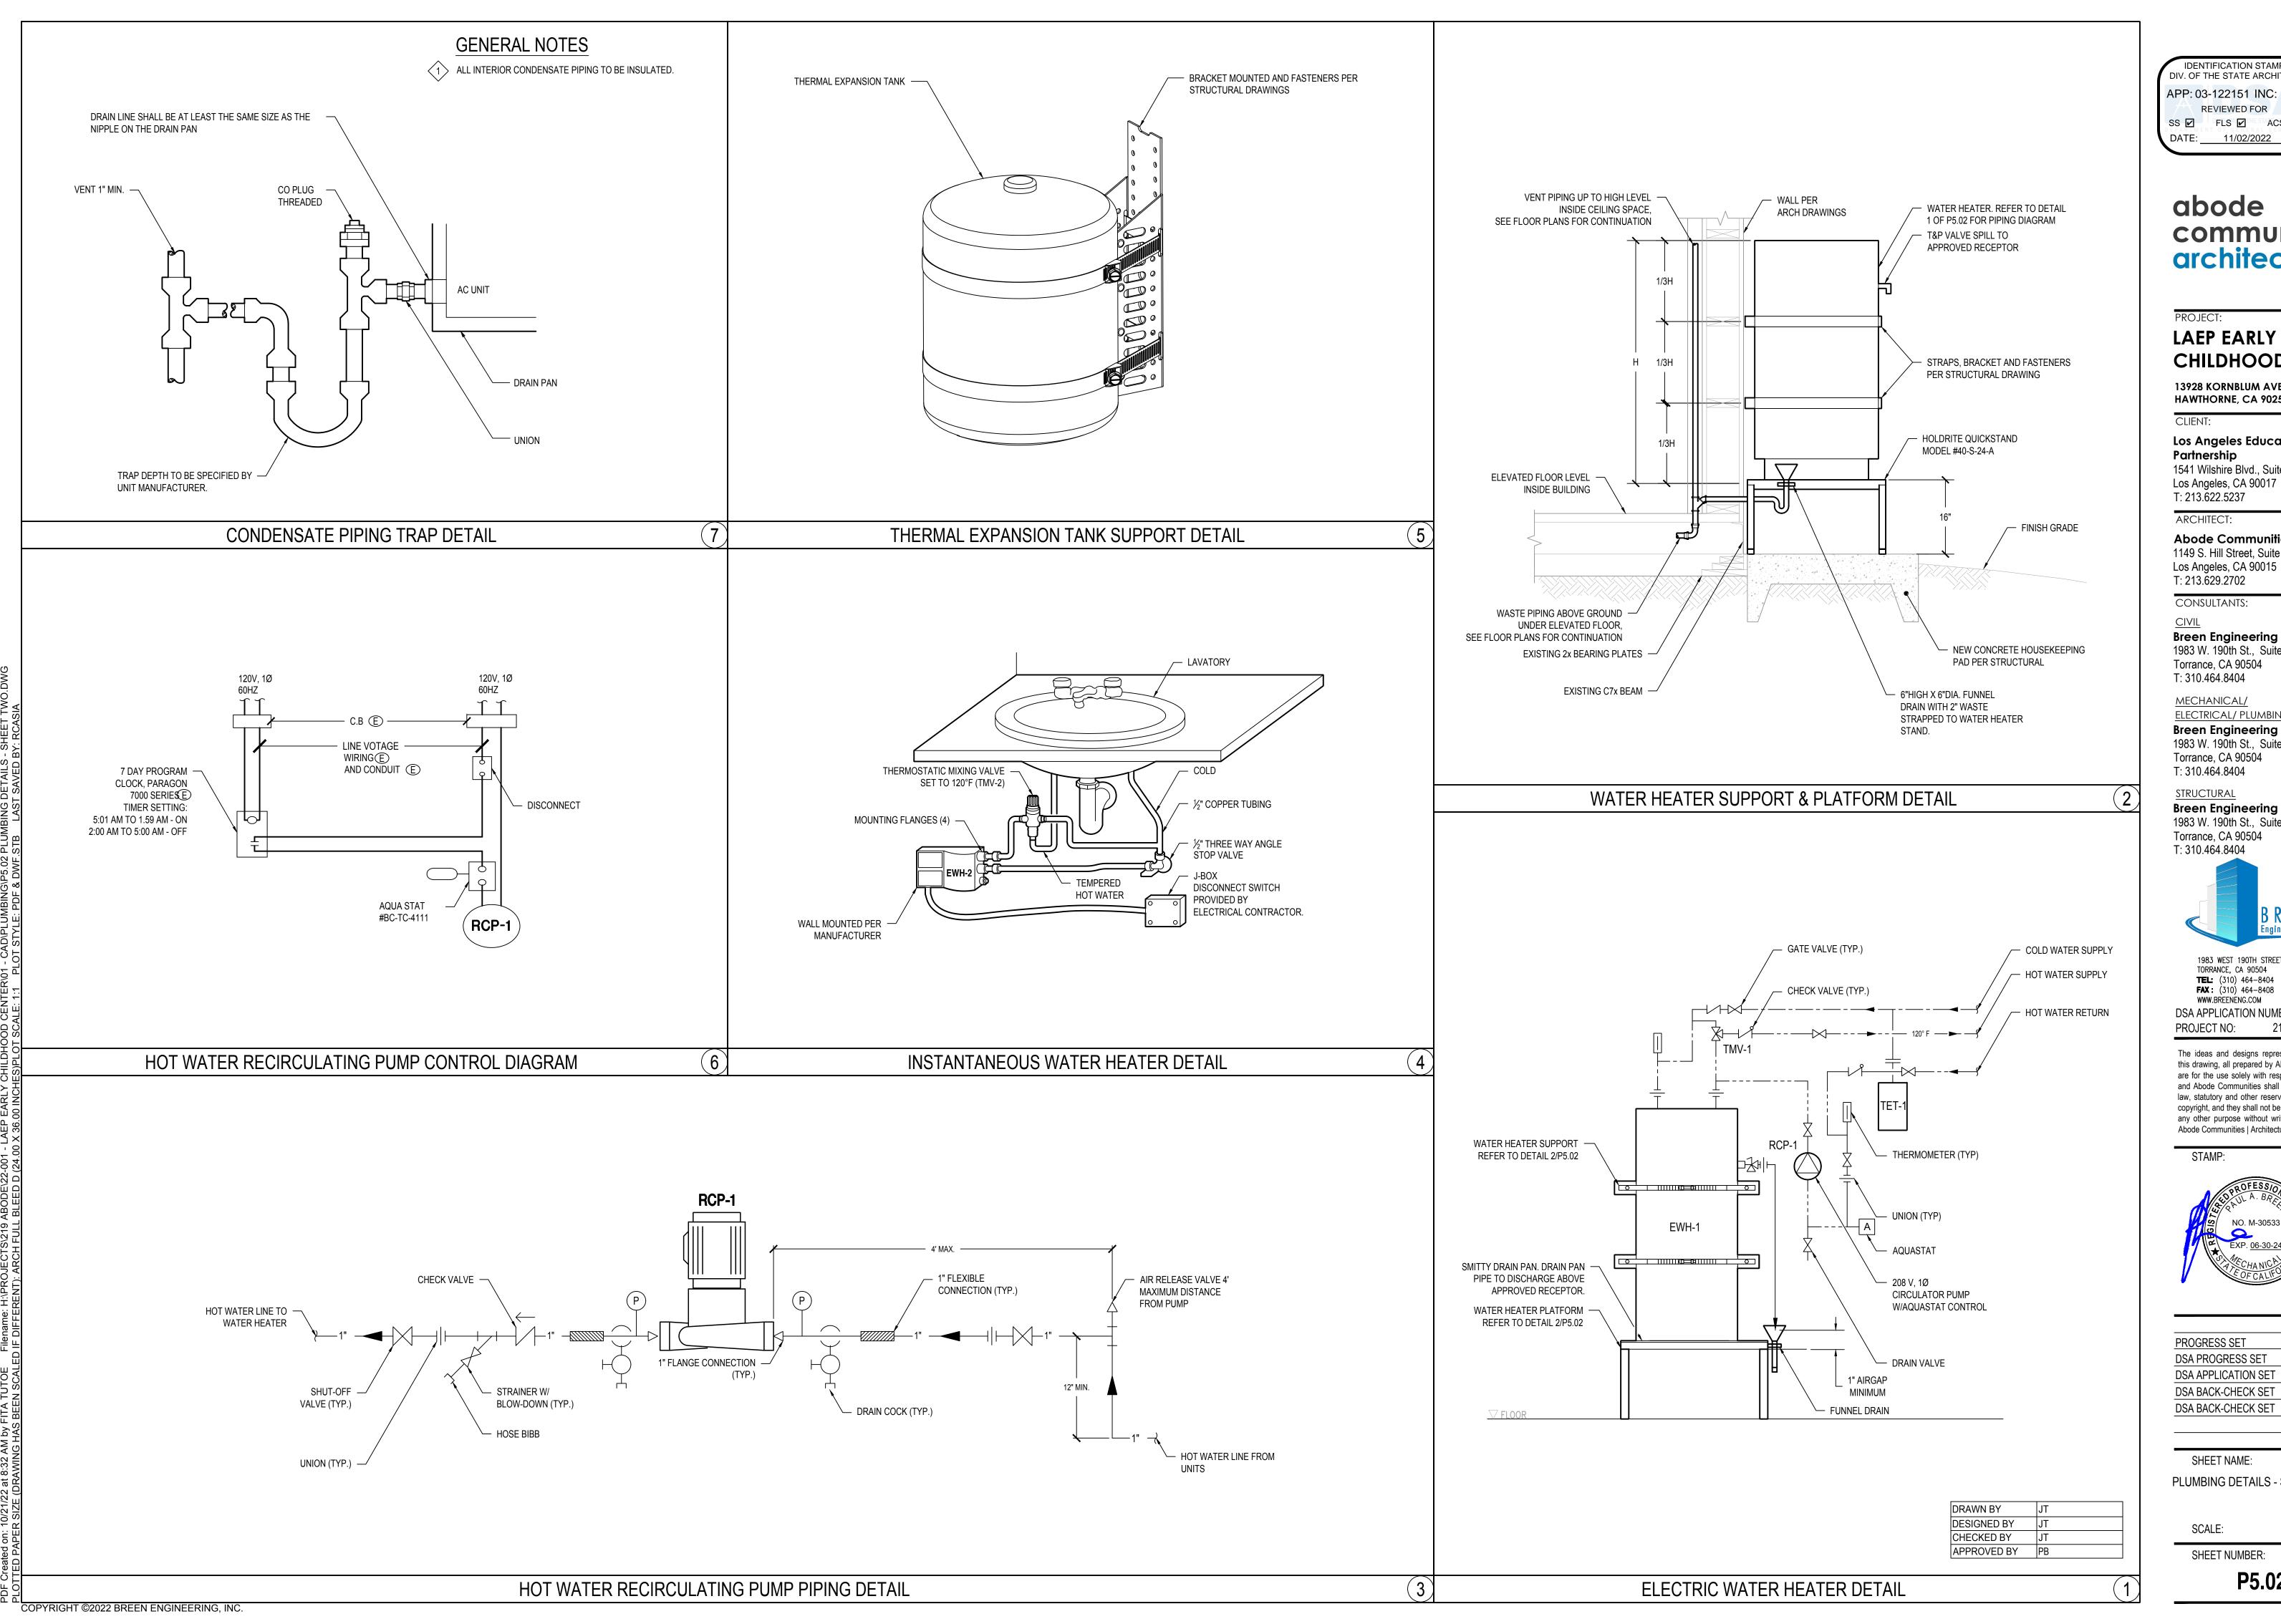PLUMBING DETAILS - SHEET TWO

SCALE: N.T.S.

SHEET NUMBER:

P5.02

- 1. BEFORE COMMENCING WORK, THE CONTRACTOR SHALL: CONDUCT A SURVEY AT THE JOB SITE INCLUDING ALL AREA UPON WHICH THIS WORK IS IN ANY WAY DEPENDENT FOR VERIFICATION OF EXISTING CONDITIONS AND INSPECT EACH AND EVERY AREA AFFECTED BY THE TOTAL ALTERATION OF THE EXISTING PORTABLE CLASSROOM BUILDING BEFORE SUBMITTING BID.
- A. REPORT TO THE GENERAL CONTRACTOR ANY CONDITION THAT PREVENTS IN AN WAY THE INSTALLATION OF WORK AS SHOWN ON DRAWING. ANY DISCREPANCY SHALL BE REFERRED IMMEDIATELY TO THE ARCHITECT OR ENGINEER FOR RESOLUTION. NO WAIVER OF RESPONSIBILITY FOR INCOMPLETE, INADEQUATE OR DEFECTIVE ADJOINING WORK WILL BE CONSIDERED UNLESS NOTIFICATION HAS BEEN FILED BEFORE SUBMITTAL OF PROPOSAL.
- B. BECOME THOROUGHLY FAMILIAR WITH INTENT OF WORK SHOWN ON DRAWINGS, AND THE ACTUAL EXISTING CONDITIONS OF WHICH CONNECTIONS MUST BE MADE TO BE IN ACCORDANCE WITH THESE DRAWINGS. THE ELECTRICAL DRAWINGS INDICATE NEW WORK, EXISTING ELECTRICAL SYSTEMS ARE NOT SHOWN EXCEPT WHERE INTERFACE IS REQUIRED. NO CONSIDERATION WILL BE GRANTED TO THE CONTRACTOR BY REASON UNFAMILIARITY WITH THE ACTUAL PHYSICAL CONDITIONS AT SITE.
- THE CONTRACTOR SCOPE OF WORK IN THIS CONTRACT IS TO CONFIRMED AND FAMILIARIZE HIMSELF WITH ALL EXISTING ELECTRICAL SYSTEMS AND SHALL INCLUDE ALL NECESSARY DEMOLITION AND NEW AND RELOCATION WORK REQUIRED BY CHANGES TO WALLS, CEILINGS AND OTHER ARCHITECTURAL WORK. THE CONTRACTOR IS URGE TO REUSE EXISTING JUNCTION BOXES, ELECTRICAL AND TELEPHONE OUTLETS, SWITCHES, CIRCUIT BREAKERS CABLING AND CONDUITS WHEREVER POSSIBLE. DEVICES AND CONDUITS DESIGNATED "X" SHOULD MEET THESE REQUIREMENTS. ALL OUTLETS TO BE FIELD CHECKED FOR DETERMINATION OF CONFORMANCE WITH THESE REQUIREMENTS.

REFER TO CONTRACTOR DOCUMENTS FOR THE EXTENT OF THESE CHANGES

- A. WHERE ELECTRICAL LIGHT FIXTURES OR OTHER ELECTRICAL DEVICES ARE TO BE REMOVED, ALL WIRING BACK TO THE NEXT REMAINING LIGHT FIXTURE OR OUTLET SHALL BE REMOVED. MAINTAIN CONTINUITY OF BRANCH CIRCUITS AND OTHER WIRING TO ALL REMAINING LIGHT FIXTURES, OUTLETS AND/OR EQUIPMENT.
- B. UNLESS OTHERWISE NOTED ON PLANS, ELECTRICAL OUTLETS SUCH AS CONVENIENCE RECEPTACLES UNAFFECTED BY ARCHITECTURAL CHANGES SHALL REMAIN AS IS, ENERGIZED FOR SERVICE.
- C. DISCONNECT AND CAP ALL EXISTING FLOOR BOXES AND FLUSH FLOOR COUPLINGS NOT BEING REUSED.
- D. ALL EXISTING CIRCUIT BREAKERS RENDERED "SPARE" DUE TO CLASSROOM SPACE REMODELING SHALL BE TURNED TO THE "OFF" POSITION AND LABELED "SPARE".
- E. SHOULD ANY DOUBT ARISE REGARDING THE PROPER DISPOSITION OF ANY EXISTING ELECTRICAL WORK, THE ARCHITECT AND ENGINEERS SHALL BE CONTACTED IMMEDIATELY.
- 3. THE LIGHTING LAYOUT SHOWN ON THE FLOOR PLANS IS THE OVERALL LIGHTING INSTALLATION OF ALL NEW REPLACEMENT LED LIGHT FIXTURES BEING INSTALLED WITHIN THE APARTMENT UNIT IN THIS CONTRACT, CONTRACTOR OF ALL NEW LIGHT FIXTURES BEING INSTALLED WITHIN THE APARTMENT UNIT IN THIS CONTRACT, CONTRACTOR OF ALL NEW LIGHT FIXTURES BEING INSTALLED WITHIN THE APARTMENT UNIT IN THIS CONTRACT, CONTRACTOR OF ALL NEW LIGHT FIXTURES BEING INSTALLED WITHIN THE APARTMENT UNIT IN THIS CONTRACT, CONTRACTOR OF ALL NEW LIGHT FIXTURES BEING INSTALLED WITHIN THE APARTMENT UNIT IN THIS CONTRACT, CONTRACTOR OF ALL NEW LIGHT FIXTURES BEING INSTALLED WITHIN THE APARTMENT UNIT IN THIS CONTRACT, CONTRACTOR OF ALL NEW LIGHT FIXTURES BEING INSTALLED WITHIN THE APARTMENT UNIT IN THIS CONTRACT, CONTRACTOR OF ALL NEW LIGHT FIXTURES BEING INSTALLED WITHIN THE APARTMENT UNIT IN THIS CONTRACT, CONTRACTOR OF ALL NEW LIGHT FIXTURES BEING INSTALLED WITHIN THE APARTMENT UNIT IN THIS CONTRACTOR OF ALL NEW LIGHT FIXTURES BEING INSTALLED WITHIN THE APARTMENT UNIT IN THIS CONTRACTOR OF ALL NEW LIGHT FIXTURES BEING INSTALLED WITHIN THE APARTMENT UNIT IN THIS CONTRACTOR OF ALL NEW LIGHT FIXTURES BEING INSTALLED WITHIN THE APARTMENT UNIT IN THIS CONTRACTOR OF ALL NEW LIGHT FIXTURES BEING INSTALLED WITHIN THE APARTMENT UNIT IN THIS CONTRACTOR OF ALL NEW LIGHT FIXTURES BEING INSTALLED WITHIN THE APARTMENT UNIT IN THIS CONTRACTOR OF ALL NEW LIGHT FIXTURES BEING INSTALLED WITHIN THE APARTMENT UNIT IN THIS CONTRACTOR OF ALL NEW LIGHT FIXTURES BEING INSTALLED WITHIN THE APARTMENT UNIT IN THE A
- SHALL INCLUDE IN HIS SCOPE OF WORK BUT NOT LIMITED TO:

  A. WITHIN THE CLASSROOM AREAS, CONTRACTOR SHALL DEMO AND/OR REMOVE ALL EXISTING CEILING FLUORESCENT LIGHT FIXTURES. INCLUDING ALL ASSOCIATED EXISTING BRANCH CIRCUITRY (CONDUIT AND WIRES)
- B. WHERE EXISTING LIGHT FIXTURES AND CONTROL DEVICES (I.E. SWITCHES) ARE TO BE REMOVED, ALL EXISTING BRANCH CIRCUITRY WIRING BACK TO THE NEXT REMAINING LIGHT FIXTURE OR DEVICE SHALL BE REMOVED.

AS SHOWN TO RECONNECT NEW REPLACEMENT LED LIGHT FIXTURE SHOWN.

- WHERE EXISTING LIGHT FIXTURES CONTROL DEVICES (I.E. SWITCHES) ARE BEING REMOVED AND REPLACE WITH NEW CONTROLS (I.E. LOW VOLTAGE LIGHTIN G MOTION SENSORS, DIMMER SWITCHES, ETC.) WHERE EXISTING BRANCH CONTINUITY IS BEING REUSED TO RE-CONNECT AND CONTROL OF NEW REPLACEMENT LIGHT FIXTURE.
- 1. WHERE EXISTING HVAC EQUIPMENT AND PLUMBING EQUIPMENT ARE BEING REMOVED AND/OR ABANDONED IN RECONSTRUCTION OF THE CLASSROOMS, IT SHALL BE THE RESPONSIBILITY OF THE ELECTRICAL CONTRACTOR TO INCLUDE IN HIS BID, SCOPE OF WORK, BUT NOT LIMITED TO:
- A. WHERE APPLICABLE REMOVAL OF ALL ELECTRICAL BRANCH CIRCUITRY SERVING THOSE PLUMBING EQUIPMENT (I.E GARAGE DISPOSAL, ETC.) BEING REMOVED IN THIS CONTRACT.
- B. REFER TO MECHANICAL, PLUMBING DRAWINGS TO DETERMINE EQUIPMENT BEING REMOVED IN THIS CONTRACT AND FOR ADDITIONAL INFORMATION TO DETERMINE AND SCOPE OF WORK REQUIRED IN THIS CONTRACT.
- 5. IN AREAS WHERE DEMOLITION WORK IS PERFORMED BY OTHER TRADES, IT SHALL BE THE RESPONSIBILITY OF THE ELECTRICAL CONTRACTOR TO COORDINATE WITH OTHER TRADES, SHOULD ANY OF THE EXISTING ELECTRICAL DEVICES, OUTLETS OR EQUIPMENT (WHICH IS TO REMAIN IN SERVICE) BE DISCONNECT, IT SHALL BE RESPONSIBILITY OF THE ELECTRICAL CONTRACTOR TO RECONNECT AS REQUIRED THOSE ITEMS WHICH ARE TO REMAIN ENERGIZED FOR SERVICE AT NO EXTRA COST TO THE OWNER.
- 6. CONTRACTOR OPTIONS: CONTRACTOR IS URGE TO REUSED EXISTING CONDUIT RACEWAY SYSTEM WHERE EVER POSSIBLE, IF INSTALLATIONS ARE PER CURRENT CODES AND UNDAMAGED.
- 7. THE FINAL ELECTRICAL SYSTEM AFTER NEW WORK AND DEMOLITION SHALL MEET ALL LOCAL AND STATE ELECTRICAL CODES.

## GENERAL NOTES

- 1. THE DRAWINGS DESCRIBE THE SYSTEMS. FURNISH ALL MATERIAL AND DO ALL WORK REQUIRED AS INDICATED ON THE DRAWINGS AND SPECIFICATIONS UNLESS OTHERWISE NOTED. FURNISH AND INSTALL ALL NEW MATERIAL AND EQUIPMENT AS REQUIRED TO PRODUCE A COMPLETE OPERATING SYSTEM. ALL WORK SHALL COMPLY WITH 2019 EDITION OF THE CALIFORNIA ELECTRICAL CODE (BASED ON 2017 NEC).
- CODES AND PERMITS: ALL ELECTRICAL EQUIPMENT, INSTALLATION, ETC., SHALL CONFORM TO 2019 CITY CODES INCLUDING CALIFORNIA TITLE 24. CONSTRUCTION SHALL COMPLY WITH THE FOLLOWING PARTS OF TITLE 24, CALIFORNIA CODE OF REGULATIONS (CCR):
  - TLE 24, PART 2, CCR (2019 CALIFORNIA BUILDING CODE)
    TLE 24, PART 3, CCR (2019 CALIFORNIA ELECTRICAL CODE
    TLE 24, PART 4, CCR (2019 CALIFORNIA MECHANICAL CODI
    TLE 24, PART 5, CCR (2019 CALIFORNIA PLUMBING CODE)
    TLE 24, PART 9, CCR (2019 CALIFORNIA FIRE CODE)
    016 CALIFORNIA GREEN BUILDINGS STANDARDS CODES)
    CONTRACTOR SHALL OBTAIN AND PAY FOR ALL PERMITS.
- 3. PROVIDE AND INSTALL ALL MATERIALS IN CONFORMANCE WITH 2019 CALIFORNIA ELECTRICAL CODE (BASED ON 2017 NEC) WITH LOCAL CITY AMENDMENTS, ORDINANCES AND LOCAL AUTHORITIES HAVING JURISDICTION. INSTALL ALL EQUIPMENT IN ACCORDANCE WITH THE REQUIREMENTS OF THE INSPECTING AUTHORITY AND THE MANUFACTURER'S RECOMMENDATIONS.
- 4. FOR PURPOSES OF CLEARNESS AND LEGIBILITY, THE ELECTRICAL DRAWINGS ARE ESSENTIALLY DIAGRAMMATIC. THE SIZE AND LOCATION OF EQUIPMENT IS SHOWN TO SCALE WHEREVER POSSIBLE. THE CONTRACTOR SHALL VERIFY ALL CONDITIONS.
- 5. THE SYMBOLS DESIGNATING CONDUIT SIZES AND QUANTITIES OF BRANCH CIRCUIT WIRING DO NOT INCLUDE THE EQUIPMENT GROUNDING CONDUCTOR REQUIRED. INSTALL REQUIRED EQUIPMENT GROUNDING CONDUCTOR IN ALL CONDUITS, SIZE PER CEC 250-122, EQUIPMENT GROUNDING CONDUCTOR SHALL BE GREEN.
- 6. BEFORE SUBMITTING BID, BECOME THOROUGHLY FAMILIAR WITH ACTUAL EXISTING CONDITIONS AT THE BUILDING. THE INTENT OF THE WORK IS SHOWN ON THE DRAWINGS AND DESCRIBED HEREINAFTER. BY THE ACT OF SUBMITTING A BID PROPOSAL FOR WORK, THE CONTRACTOR SHALL BE DEEMED TO HAVE MADE SUCH A STUDY AND EXAMINATION AND TO ACCEPT ALL CONDITIONS PRESENT AT THE SITE. NO REQUEST FOR ADDITIONAL PAYMENT SHALL BE CONSIDERED AS VALID, DUE TO FAILURE TO ALLOW FOR CONDITIONS WHICH MAY EXIST.
- 7. REFER TO ALL DRAWINGS FOR ADDITIONAL INFORMATION, EXACT EQUIPMENT LOCATION, MOUNTING HEIGHTS, MOUNTING REQUIREMENTS AND MAKE ALL FINAL ELECTRICAL CONNECTIONS TO ALL ELECTRICAL EQUIPMENT AS REQUIRED.
- 8. LOCATIONS OF CEILING MOUNTED DEVICES SHOWN ON THE ARCHITECTURAL DRAWINGS TAKE PRECEDENCE OVER THOSE SHOWN ON THE ELECTRICAL DRAWINGS. CONTRACTOR TO COORDINATE WITH OTHER TRADES FOR ADDITIONAL INFORMATION, EQUIPMENT LOCATION, MOUNTING HEIGHTS, MOUNTING REQUIREMENTS AND MAKE FINAL CONNECTIONS TO ALL ELECTRICAL EQUIPMENT.
- 9. CONTRACTOR'S BID SHALL BE BASED ON ALL WORK SHOWN ON THE PLANS AND SPECIFICATIONS. ALL PREMIUM TIME COSTS REQUIRED SHALL BE INCLUDED IN HIS BID. IF CONTRACTOR PROPOSES TO SUBSTITUTE FOR EQUIPMENT SPECIFIED, HE SHALL SUBMIT HIS REQUEST FOR CONSIDERATION TO THE OWNER AND ENGINEER PRIOR TO THE BID, IN WRITING. ALL SUBSTITUTIONS MUST BE REVIEWED BY THE ENGINEER. SUCH REVIEW SHALL NOT RELIEVE THE CONTRACTOR FROM COMPLYING WITH THE REQUIREMENTS OF THE DRAWINGS AND SPECIFICATIONS. THE CONTRACTOR SHALL BE RESPONSIBLE AT HIS OWN EXPENSE FOR ANY CHANGES RESULTING FROM HIS PROPOSED SUBSTITUTIONS WHICH MAY AFFECT OTHER PARTS OF HIS OWN WORK OR THE WORK OF OTHER CONTRACTORS.
- 10. CONTRACTOR TO PROVIDE TEMPORARY ELECTRICAL SERVICE SUITABLE TO CONDUCT CONSTRUCTION WORK
- 11. REFER TO REFLECTED CEILING PLAN FOR EXACT LOCATION OF ALL LIGHTING FIXTURES, SMOKE DETECTORS AND FIRE ALARM DEVICES.
- 12. ALL MATERIALS AND EQUIPMENT SHALL BE NEW AND SHALL BEAR THE UNDERWRITERS LABEL (UL) AND BE INSTALLED IN THE MANNER FOR WHICH THEY ARE DESIGNED AND APPROVED.
- 13. ANY SUBSTITUTIONS OF SPECIFIED MATERIALS REQUIRE WRITTEN NOTIFICATION BY THE CONTRACTOR AND FORMAL APPROVAL BY OWNER REPRESENTATIVE AND/OR THE ENGINEER.
- 14. SEAL ALL NEW CONDUIT PENETRATIONS THROUGH FIRE RATED WALLS, CEILINGS, FLOORS, ETC., TO MAINTAIN EXISTING FIRE RATING CONDITIONS. FURNISH AND INSTALL FIRE RATED ENCLOSURES FOR ALL EQUIPMENT PENETRATING INTO FIRE RATED ENVELOPES, SPACES, ETC.
- 15. WHENEVER CONDUITS PENETRATE A PERIMETER WALL, IT IS TO BE SEALED IN AN APPROVED MANNER.
- 16. PROVIDE AN ENCLOSURE OF EQUAL FIRE RESISTANT RATING AROUND ALL FIXTURES AND EQUIPMENT INSTALLED IN OR PENETRATING THROUGH FIRE RATED SEPARATIONS.
- 17. OUTLET BOXES AND PANELS INSTALLED IN FIRE RATED WALLS AND CEILINGS SHALL NOT EXCEED 100 SQUARE INCHES FOR ANY 100 SQUARE FEET OF WALL OR CEILING AREA. INDIVIDUAL OUTLET BOXES OR FIXTURES SHALL BE STEEL AND NOT GREATER THAN 16 SQUARE INCHES.
- 18. ALL ROOF PENETRATIONS SHALL BE THROUGH ROOF CURB.
- 19. ISOLATED EQUIPMENT GROUNDING CONDUCTOR INSULATION SHALL BE GREEN WITH A YELLOW STRIPE. EQUIPMENT GROUNDING CONDUCTOR SHALL BE GREEN.
- 20. ALL DEVICES INSTALLED OUTSIDE OR SUBJECT TO WATER SPRAY SHALL BE APPROVED FOR WET LOCATION. ALL DEVICES SUBJECT TO VAPORS, STEAM AND MOISTURE SHALL BE APPROVED FOR DAMP LOCATION. FOR WALL MOUNTED OUTLETS EXACT LOCATION AND MOUNTING HEIGHTS, REFER TO ARCHITECTURAL DRAWINGS INTERIOR ELEVATIONS IF PROVIDED.
- 21. INSTALL "GFI" GROUND FAULT INTERRUPTER RECEPTACLES WITHIN 6 FEET OF A SINK OR ANY AREA SUBJECT TO WATER SPRAY.
- 22. INSTALL "GFI" GROUND FAULT INTERRUPTER RECEPTACLES WITH WEATHERPROOF COVER ON ROOF WITHIN 25 FEET OF "HVAC/PLUMBING" EQUIPMENT, MOUNT RECEPTACLE ON UNISTRUT SUPPORT.

- 3. WITHIN COMMON AREAS SWITCHES AND RECEPTACLES SHALL BE 20 AMP SPECIFICATION GRADE (HUBBEL #5362 AND #1221 OR EQUAL). SPECIAL RECEPTACLES SHALL MATCH EQUIPMENT SERVED.
- 24. GENERAL DUPLEX CONVENIENCE OUTLETS SHALL BE WHITE COLOR FACEPLATE.
- E 25. DUPLEX CONVENIENCE WITH ISOLATED GROUND TYPE SHALL BE WHITE WITH ORANGE TRIANGLE MARKING
- 26. RECEPTACLE COVER PLATES SHALL BE LABELED WITH A LABEL MAKER SHOWING PANEL NAME AND CIRCUIT NUMBER.
- 27. PROVIDE SUPPORT FOR ALL LIGHTING FIXTURES AND ALL ELECTRICAL EQUIPMENT TO COMPLY WITH THE SEISMIC REQUIREMENTS OF THE CURRENT CALIFORNIA BUILDING AND ELECTRICAL CODES AND LOCAL AUTHORITIES.
- 28. ALL LIGHT FIXTURES SHALL BE FURNISHED AND INSTALLED COMPLETE WITH ALL NECESSARY HARDWARE, FITTINGS LAMPS AND LED DIMMABLE DRIVER. LED LAMPS SHALL HAVE A CRI RATING OF 80 OR HIGHER AND FIXTURES SHALL BE CEC CERTIFIED.
- 29. FUSES FOR MOTOR PROTECTION SHALL BE PER NAMEPLATE RATING OF EQUIPMENT SPECIFIED MANUAL MOTOR STARTERS FOR FRACTIONAL HORSEPOWER MOTORS SHALL BE SQUARE 'D' WITH OVERLOAD PROTECTION. PROVIDE OVERLOAD PROTECTION IN EACH PHASE FOR 3-PHASE MOTORS.
- 30. PROVIDE NAMEPLATES FOR ALL PANELBOARDS, DISTRIBUTION BOARDS, DISCONNECTS SWITCHES AND TRANSFORMERS, MOTOR STARTERS, TERMINAL CABINETS AND ALL ELECTRICAL EQUIPMENT IDENTIFIED B NAME ON DRAWINGS.
- 31. BUILDING SERVICE ENTRANCE GROUNDING SYSTEM NOT EXCEED EARTH RESISTANCE OF 5 OHMS.
- 32. PROVIDE ALL ROUGH-IN WORK AND MAKE FINAL CONNECTIONS REQUIRED TO ALL EQUIPMENT. VERIFY EXACT POINT OF CONNECTION AND TYPE OF RECEPTACLES REQUIRED WITH RESPECTIVE EQUIPMENT SUPPLIER
- 33. IN ADDITION TO JUNCTION BOXES INDICATED ON DRAWINGS, INSTALL JUNCTION BOXES AND PULL BOXES FOR CABLE SPLICES, CABLE PULLING AND CONNECTIONS NECESSARY FOR THE INSTALLATION OF A COMPLETE OPERATING SYSTEM. JUNCTION BOXES AND PULL BOXES SHALL BE ACCESSIBLE. LABEL JUNCTION BOXES AND PULL BOXES WITH APPROPRIATE DESIGNATION. MAXIMUM (3) 90° BENDS.
- 34. INSTALLATION OF 600 VOLTS CONDUCTORS, SHALL BE CONTINUOUS BETWEEN OUTLETS OR JUNCTION BOXES. MAKE SPLICES IN OUTLET BOXES, PULLBOXES, GUTTERS AND/OR PANELBOARD. DO NOT SPLICE PANELBOARD FEEDERS.
- 35. NEW ELECTRICAL FEEDER CONDUITS SHALL BE PVC SCHEDULE 40, RIGID METAL CONDUITS AND/OR ELECTRICAL METALLIC TUBING UNLESS OTHERWISE NOTED. STEEL FLEXIBLE CONDUITS FOR SHORT EQUIPMENT CONNECTIONS, EQUIPMENT CONNECTIONS SUBJECT TO VIBRATIONS AND EQUIPMENT LOCATED OUTSIDE OR SUBJECT TO WATER SPRAY MAKE CONNECTIONS WITH LIQUID-TIGHT CONDUIT AND WEATHERPROOF COMPONENTS, LENGTH IS LIMITED TO SIX FEET, IN ALL CONDUIT SYSTEM PROVIDE EQUIPMENT GROUNDING CONDUCTOR SIZE PER 2019 CEC TABLE 250-122.
- 36. PAINT ALL NEW EXPOSED ELECTRICAL RACEWAYS, CABINETS, ENCLOSURES AND FITTINGS TO MATCH ADJACENT FINISHES. EXPOSED CONDUIT RUNS SHALL BE INSTALLED AS CLOSED AS POSSIBLE TO THE CEILING.
- 37. CONDUIT STUBBED-OUTS AND CONDUIT STUBBED-UPS SHALL BE PROVIDED WITH BUSHING ON ENDS.
- 38. PROVIDE PULL STRING IN EMPTY CONDUITS INSTALLED AS PART OF THIS PROJECT.
- 39. UNLESS OTHERWISE NOTED PROVIDE COPPER CONDUCTORS, MINIMUM SIZE #12 AWG. PROVIDE SOLID CONDUCTORS #10 AWG AND SMALLER UNLESS OTHERWISE NOTED. PROVIDE STRANDED CONDUCTORS #8 AWG AND LARGER UNLESS OTHERWISE NOTED. USE CONDUCTORS WITH THHN/THWN 600 VOLTS INSULATION FOR SIZES #6 AWG AND SMALLER, UNLESS OTHERWISE NOTED. CONDUCTORS #4 AWG AND LARGER SHALL BE THAW INSULATION, UNLESS OTHERWISE NOTED.
- 40. DELIVER ALL CONDUCTORS TO THE JOB SITE IN ORIGINAL UNBROKEN CARTON OR REEL, PROPERLY TAGGED WITH U.L. LABEL, SIZE, MANUFACTURER'S TRADE NAME AND THE DATE MANUFACTURED.
- 41. IT IS THE RESPONSIBILITY OF THE CONTRACTOR TO MAINTAIN WORK AREA CLEAR OF DEBRIS ON DAILY
- BASIS DURING CONSTRUCTION.
- 42. ALL NEW ELECTRICAL HOOKUPS REQUIRED DURING OFF HOURS WILL BE PERFORMED BY THE CONTRACTOR AT NO ADDITIONAL COST.
- 43. NO PIPING, DUCTS OR EQUIPMENT FOREIGN TO ELECTRICAL EQUIPMENT SHALL BE PERMITTED TO BE LOCATED WITHIN DEDICATED WORKING SPACE OF EQUIPMENT, INCLUDING THE DEDICATED SPACE BETWEEN THE TOP OF EQUIPMENT TO THE STRUCTURAL CEILING ABOVE. ALL FOREIGN INSTALLATION WITHIN THE SPACE (I.E. FIRE SPRINKLER, ETC) SHALL BE INSTALLED IN ACCORDANCE WITH CEC 2019 11026(E)(1)(c)
- 44. IDENTIFY DATA & COMMUNICATION PULL ROPE OR CABLE AT BOTH ENDS DESIGNATING OPPOSITE
- 45. USE PLASTIC COATED SELF-STICKING MARKERS SUCH AS THOMAS & BETTS E-Z CODE FOR IDENTIFICATION
- 46. PROVIDE A TYPE WRITTEN PANELBOARD DIRECTORY
- 47. FIRE ALARM SYSTEM SHALL BE DESIGN BUILD.
- 48. ALL RECEPTACLES SHALL BE INSTALLED WITH GROUND PLUG UP.

OF CONDUCTORS AND METAL EDGE BANDED PAPER TAGS ON PULL ROPES.

	ELECTRICAL SHEET INDEX	
SHEET NO.	SHEET TITLE	CURRENT ISSUE
E0.01	ELECTRICAL GENERAL NOTES, SYMBOLS LEGEND & SHEET INDEX	DSA SUBMITTAL
E0.02	ELECTRICAL SCHEDULES & CALCULATIONS	DSA SUBMITTAL
E1.00	ELECTRICAL SITE PLAN	DSA SUBMITTAL
E2.01	ELECTRICAL BUNGALOW 01 FLOOR PLANS	DSA SUBMITTAL
E2.02	ELECTRICAL BUNGALOW 02 FLOOR PLANS	DSA SUBMITTAL
E2.03	ELECTRICAL BUNGALOW 03 FLOOR PLANS	DSA SUBMITTAL
E2.04	ELECTRICAL BUNGALOW 04 FLOOR PLANS	DSA SUBMITTAL
EN.01	TITLE 24 COMPLIANCE FORMS - SHEET ONE	DSA SUBMITTAL
EN.02	TITLE 24 COMPLIANCE FORMS - SHEET TWO	DSA SUBMITTAL

$\ominus$	GROUNDED TYPE DUPLEX RECEPTACLE, 20A NEMA 5-20R, WALL MOUNTED.
<b>#</b>	DOUBLE DUPLEX CONVENIENCE OUTLET, WALL MOUNTED +15" A.F.F. TO BOTTOM OF BOX (U.O.N.)
JSB⊖J	GROUNDED TYPE DUPLEX RECEPTACLE, 20A NEMA 5-20R, WALL MOUNTED. USB DENOTES COMBO ELECTRICAL AND USB CHARGER OUTLET (MFR. BY COOPER #TR7740 OR EQUAL).
· <del> </del>	20A GFCI WEATHER PROOF RECEPTACLE MOUNTED ON ROOF
f⇔l	GROUNDED TYPE DUPLEX RECEPTACLE, WALL MOUNTED FOR REFRIGERATOR.
$\Theta$	GROUNDED TYPE DUPLEX RECEPTACLE, WALL MOUNTED FOR DISH WASHER.
Ø4	ELECTRICAL COOKING OUTLET +15" A.F.F 120/208V, 50A, 4W GROUNDED RECEPTACLE.
	GROUNDED TYPE DUPLEX RECEPTACLE (HALF SWITCH), WALL MOUNTED +15"A.F.F.
	CONSTRUCTION NOTES:
	1. WHERE NEMA 5-15R OR 5-20R RECEPTACLE ARE BEING PROVIDED WITHIN RESIDENTIAL UNIT SHALL BE
	RESISTANT RESIDENTIAL TYPE AND BE HALF SWITCH.
	2. WHERE NEMA 5-15R OR 5-20R RECEPTACLE ARE BEING PROVIDED WITHIN GENERAL OFFICE FACILITY (I.E. OFFICE,
	CONFERENCE, OFFICE HALLWAYS, OFFICE LUNCH ROOM, ETC.) THE RECEPTACLE SHALL BE COMMERCIAL GRADE TYPE AND BE TITLE 24 APPROVED CONTROL RECEPTACLE WITH ENGRAVED SWITCH LABELING.
#	CEILING MOUNTED RECEPTACLE
<u> </u>	CEILING MOUNTED JUNCTION BOX, 4S TYPE UNLESS OTHERWISE NOTED.
Τ̈́V	COMBINATION TELEVISION OUTLET AND DUPLEX RECEPTACLE +66" (U.O.N.).
¥	TELEPHONE OUTLET, WALL MOUNTED +15" C A.F.F.
	DATA OUTLET, WALL MOUNTED +15" C A.F.F.
<b>T</b>	COMBINED TELEPHONE & DATA OUTLET +15" C A.F.F.
	TOGGLE SWITCH, +4'-0" SUFFIX ON SWITCH SYMBOLS SHALL INDICATE THE FOLLOWING:
	NO SUFFIX = SINGLE POLE
	2 = 2 POLE 3 = 3 WAY
	K = KEY OPERATED
	R = SPOT MOMENTARY CONTACT SWITCH P = WITH PILOT LIGHT
	a,b,c,d, ETC. INDICATES FIXTURE CONTROLLED
Sm	30A,2P OR 60A,2P MOTOR RATED TOGGLE TYPE DISCONNECT SWITCH TO BE MOUNTED ON HVAC/PLUMBING EQUIPMENT.
•	FLEXIBLE CONNECTION TO EQUIPMENT.
	SURFACE MOUNTED CABINET OR EQUIPMENT AS NOTED.
	FLUSH MOUNTED CABINET OR EQUIPMENT AS NOTED.
	SURFACE MOUNTED BRANCH CIRCUIT PANELBOARD.
	FLUSH MOUNTED BRANCH CIRCUIT PANELBOARD.
	SWITCHBOARD, DISTRIBUTION BOARD.
7777	TELEPHONE PLYWOOD BACKBOARD SIZE AS INDICATED ON PLANS.  CONDUIT RUN IN OR BELOW FLOOR SLAB OR UNDERGROUND - 3/4"C. MINIMUM.
	CONDUIT RUN CONCEALED IN WALL OR ABOVE FINISHED CEILING - ½ "C.
	CONDUIT RUN EXPOSED.
<del>X</del>	—————————————————————————————————————
	—————————————————————————————————————
	#10 #10 ————————————————————————————————————
	—
<del>                                     </del>	#1U #8 #8
	—————————————————————————————————————
	WIRE SIZE OTHER THAN #12, #10 OR #8 IS NOTED ON EACH CONDUIT RUN WITH SIZE OF CONDUIT (I.E. 3#6 - 1"C.) SEE GENERAL WIRE SIZE OTHER THAN #12, #10 OR #8 IS NOTED ON EACH CONDUIT RUN WITH SIZE OF CONDUIT (I.E. 3#6 - 1"C.)
	NOTE #42.  EMERGENCY LIGHTING SYSTEM BRANCH CIRCUITRY CONDUIT RUN.
#1()	HASH MARKS INDICATES THE QUANTITY OF CONDUCTORS REQUIRED. NO HASH MARKS INDICATES 2 #12 AWG. CONDUCTORS LARGER THAN SIZE #12 AWG ARE INDICATED NEXT TO HASH MARKS.
	EAROLIT ITIAN SIZE #12 AWS ARE INDICATED NEXT TO HASTI WARRS.
D 1 2 5	INDICATES HOMERUN TO PANEL, CIRCUITS 1,3,5 WITH SHARED NEUTRAL
└ P-1,3,5	
	AREA SMOKE DETECTOR / DUCT SMOKE DETECTOR
HA )	INDICATES REFERENCE TO PANELBOARD 'P1A'.
HA	ELECTRICAL FEEDER DESIGNATION.
Ø	ELECTRICAL COOKING (RANGE OUTLET) +15" A.F.F 120/240V, 50A, 4W GROUNDED RECEPTACLE.
	EXHAUST FAN.
	EAUTOOT 17NA.
IM-1A	SIGNAL SYSTEM COMMUNICATION BACKBOARD DESIGNATION.
1)	REFERENCE NOTE DESIGNATION.
M	METERING AND TEST BLOCKS AS REQUIRED BY THE UTILITY SERVING AGENCY.
$\overline{}$	CIRCUIT BREAKER.
'	ODOLIND.
_	GROUND.
1/	MOTOR (NUMBER INSIDE SYMBOL DESIGNATES HP OF MOTOR)
1)/	MOTOR (NUMBER INSIDE SYMBOL DESIGNATES HP OF MOTOR).
	MOTOR (NUMBER INSIDE SYMBOL DESIGNATES HP OF MOTOR).  TE: FOR ADDITIONAL SYSTEM SYMBOLS AND WIRING LEGEND REFER TO SITE PLANS AND RISER DIAGRAMS.

ELECTRICAL SYMBOLS LEGEND

DESCRIPTION

SYMBOL

EXIT LIGHT FIXTURE, WALL MOUNTED.

EXIT LIGHT FIXTURE, CEILING OR PENDANT MOUNTED.

IDENTIFICATION STAMP DIV. OF THE STATE ARCHITECT APP: 03-122151 INC:

REVIEWED FOR
SS FLS ACS DATE: 11/02/2022

# abode communities architecture

PROJECT:

## LAEP EARLY CHILDHOOD CENTER

HAWTHORNE, CA 90250

13928 KORNBLUM AVE

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DSA APPLICATION NUMBER: 03-122151

PROJECT NO: 219-22-001

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STAI



DATE REV
PROGRESS SET 02.01.22
DSA PROGRESS SET 03.02.22
DSA APPLICATION SET 04.01.22
DSA BACK-CHECK SET 10.05.22
DSA BACK-CHECK SET 10.24.22

SHEET NAME:

ELECTRICAL GENERAL NOTES, SYMBOLS LEGEND & SHEET INDEX


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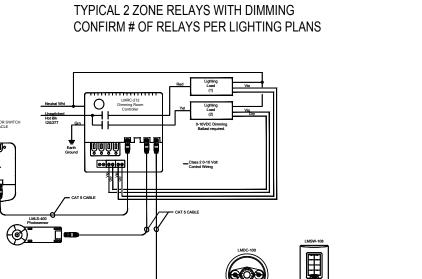
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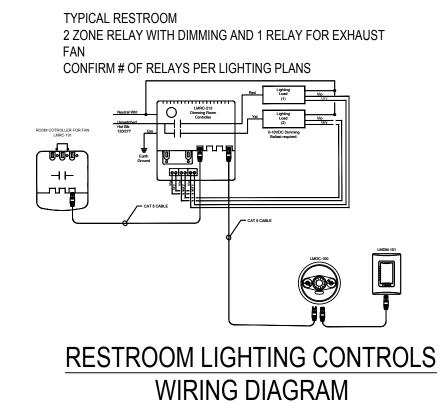
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TYPICAL LARGE OFFICES/CLASSROOM
AREAS LIGHTING CONTROLS DIAGRAM



TYPICAL LIGHTING CONTROL CHAIRING BLACKANG	
TITICAL LIGITING CONTROLS WIRING DIAGRANS	
TYPICAL LIGHTING CONTROLS WIRING DIAGRAMS	

-		LMDC - 100
<b>р</b> <sub>101</sub>		LMDM - 101 (ON/OFF DIM)
LMPL 101		LMPL - 101
LMBC 300		LMBC - 300
LMLS 400		LMLS - 400
LMLS 500		LMLS - 500
\$ <sub>101</sub>		LMSW - 101 (1 BUTTON ON/OFF DIM)
\$ <sub>102</sub>		LMSW - 102 (2 BUTTON ON/OFF DIM)
\$ <sub>105</sub>		LMSW - 105 (1 BUTTON ON/OFF DIM)
Pw		PW - 100 WALL MOUNT MOTION SENSOR (ON/OFF DIM)
		LMCT - 100
LMSM 603		LMSM - 603
ELCU 200		ELCU - 200
		OLTAGE CAT 5 CONTROL WIRING BETWEEN CONTROL ES
	CIRCU	WITH 2#12 BRANCH ITRY LINE VOLTAGE AND 2#12 CONTROL WIRES

LIGHTING CONTROL

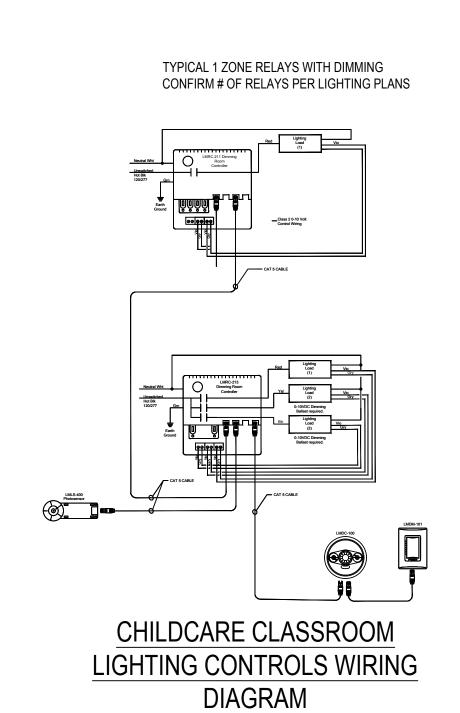SYMBOL LEGEND

(NOTE: NOT ALL SYMBOLS SHOWN

MAYBE APPLICABLE TO THIS PROJECT)

LMRC - 213

LMRC - 212

LMRC - 101

DESCRIPTION

SYMBOL

				NE'	W LIGHTING FIXTURE SCHEDULE	
	TYPE	SYMBOL	MOUNTING	LAMP/COLOR WATTAGE	DESCRIPTION	MANUFACTURER
)	А	А	RECESSED IN T-BAR CEILING	LED/3500°K LOW LUMEN 3394 24W	2' X 4' LED EDGE LIT FLAT PANEL LIGHT FIXTURE, WITH O-10 DIMMABLE DRIVER.  LOCATED IN HALLWAY, RESTROOM, EQUIPMENT/STORAGE, WASHER/DRYER ROOM	COLUMBIA LIGHTING CFP EDGE-LIT PANEL CFP22-LSCS (24 WATTS/3225 LUMENS)
	A1	A1	RECESSED IN T-BAR CEILING	LED/3500°K MED LUMEN 4291 33W	2' X 4' LED EDGE LIT FLAT PANEL LIGHT FIXTURE, WITH O-10 DIMMABLE DRIVER.  LOCATED IN KITCHEN AND CLASSROOM	COLUMBIA LIGHTING CFP EDGE-LIT PANEL CFP24-LSCS (33 WATTS/4318 LUMENS)
	В	H	WALL MOUNTED	LED/300K 2124LUMENS 24W	VANITY LIGHT LOCATED IN RESTROOM	PROGRESS CCT SLECTABLE BATH LIGHT P300239-060-CS
	С		UNDERMOUNT	LED/300K 650LUMENS 10W	UNDERMOUNT CABINET LIGHT  LOCATED IN THE KITCHEN	BRUCK WUNDERCAB 138546-16-3000K-90-120V-WH
	D	오	WALL MOUNTED	LED, 20W	WALL MOUNTED LED LIGHT FIXTURE  LOCATED AT THE BUILDING EXTERIOR	TBD
	EX	<b>⊕</b>	CEILING MOUNTED	4.5W	8"X13" EDG AMD EDGR	EDG-G/EDGR

## LIGHTING FIXTURE NOTES

- 1. THE CONTRACTOR IS RESPONSIBLE FOR COORDINATING RECESSED LUMINARIES WITH THE CEILINGS INTO WHICH THEY ARE TO BE INSTALLED, REGARDLESS OF THE MANUFACTURERS' PRODUCT NUMBERS SPECIFIED AND ORDERED BY THE OWNER OR CONTRACTOR.
- 2. LUMINARIES AND CONNECTIONS TO BUILDING CONSTRUCTION SHALL CONFORM TO APPLICABLE SEISMIC CODES. PROVIDE ALL SEISMIC HANGER WIRES (DIAGONAL CORNER) AND SCREWS (OPPOSITE CORNER) PER LOCAL AUTHORITY HAVING JURISDICTION.
- 3. THE CONTRACTOR SHALL PROVIDE ALL MOUNTING HARDWARE AS REQUIRED AND AS NECESSARY TO ENSURE PROPER INSTALLATION OF EACH LIGHT FIXTURE AS TO THEIR RESPECTIVE CEILING CONDITION.
- PRIOR TO ORDERING AND SHIPMENT OF FIXTURE, THE CONTRACTOR SHALL COORDINATE AND VERIFY EXACT QUANTITY REQUIRED FOR INSTALLATION AT SITE.

## NON-RESIDENTIAL LIGHTING CONTROLS NOTES

THE INTENT OF THE CONSTRUCTION DOCUMENTS AND THE LIGHTING CONTROLS SHOWN ON THE PLANS IS TO PROVIDE IN THIS CONTRACT A COMPLETE TURN-KEY LIGHTING CONTROL SYSTEM AND/OR CONTROL DEVICES FOR ALL LIGHTING SYSTEMS, REGARDLESS OF THE PART ORDERING NUMBER LISTED ON THE PLANS OR SPECIFICATION. LIGHTING CONTROLS INSTALLATION SHALL INCLUDE, BUT NOT LIMITED TO THE FOLLOWING:

- 1. THE CONTRACTOR SHALL CONSULT WITH THE AUTOMATIC LIGHTING CONTROLS MANUFACTURER PRIOR TO PLACEMENT OF ORDER TO ENSURE THAT THE AUTOMATIC WALL AND/OR CEILING LIGHTING CONTROL SENSORS, DEVICES, COMPONENT, LOW VOLTAGE WIRING, ETC. PROVIDED WILL OPERATE THE DESIGNATED LIGHTING SHOWN ON THE LIGHTING PLANS AND THAT ALL MATERIAL REQUIRED FOR THE INSTALLATION ARE IN ACCORDANCE WITH MANUFACTURER'S RECOMMENDATION AND SPECIFICATIONS. CONTRACTOR SHALL PROVIDE COMPLETE SET OF MANUFACTURER SHOP DRAWING AND CUT SHEETS FOR A/E REVIEW AND APPROVAL PRIOR TO ORDERING AND SHIPMENT OF MATERIALS. SUBMITTAL SHALL BE A SEPARATE SUBMITTAL (MINIMUM 4 COPIES).
- 2. ALL LIGHTING CONTROLS COMMISSIONING, INSPECTIONS (INCLUDING STATE OF CALIFORNIA ENERGY COMMISSION INSPECTION FORMS AND APPLICATIONS), TESTING, PROGRAMMING AND TUNING OF LIGHTING CONTROL SENSORS, DEVICES AND COMPONENT, ETC. SHALL BE INCLUDED IN THE LIGHTING CONTROL PACKAGE AND PRICE. ANY LABOR, TOOLS AND MATERIAL REQUIRED TO PROVIDE A COMPLETE THE LIGHTING CONTROL SYSTEM SHALL BE AT NO EXTRA COST TO THE OWNERS OR END-USERS.
- 3. THE LIGHTING CONTROLS DESIGN SHOWN ON THE PLANS ARE BASED ON WATTSTOPPER CONTROLS. ALL AUTOMATIC LIGHTING CONTROLS AND MATERIAL SHALL BE MANUFACTURED BY ACUITY BRAND/LCD CONTROLS, LEVITON, OR APPROVED EQUAL.

# NON-RESIDENTIAL BUILDING INTERIOR SPACES LIGHTING CONTROL SEQUENCE

- ALL LIGHTING INSTALLED WITHIN ENCLOSED SPACES SHALL BE CONTROLLED VIA AN AUTOMATIC MOTION SENSOR AND HAVE DIMMING CAPABILITY TO REDUCE LIGHT FIXTURE OUTPUT LEVEL 10%-100% OR 20%-100% DEPENDING ON LIGHT LAMP SOURCE. (NOTE: CONTRACTOR SHALL PROGRAM FIXTURE LUMEN OUTPUT SHALL BE REDUCE TO MINIMUM 20% WHEN SPACE IS UN-OCCUPIED)
- 2. ALL LIGHTING INSTALLED WITHIN A LARGE ROOM GREATER THAN 250 SQUARE FEET SHALL BE CONTROLLED VIA AN AUTOMATIC MOTION SENSORS OR AUTOMATIC TIME CONTROLS, AND HAVE DIMMING CAPABILITY TO REDUCE LIGHT FIXTURES LUMENS OUTPUT LEVEL 10%-100% OR 20%-100% DEPENDING ON LIGHT LAMP SOURCE. (NOTE: CONTRACTOR SHALL PROGRAM FIXTURE LUMENS OUTPUT SHALL BE REDUCE TO MINIMUM 20% WHEN SPACE IS UN-OCCUPIED)
- 3. DAYLIGHT HARVESTING ALL LIGHTING INSTALLED WITHIN WINDOW AND/OR SKYLIGHT PRIMARY AND SECONDARY DAYLIGHT ZONE. SHALL BE CONTROLLED VIA AUTOMATIC MOTION SENSORS OR AUTOMATIC TIME CONTROLS AND PHOTOCONTROL SENSOR AND HAVE DIMMING CAPABILITY TO REDUCE LIGHT FIXTURE LUMENS OUTPUT LEVEL 10%-100% OR 20%-100% (DEPENDING ON LIGHT LAMP SOURCE) DURING DAYLIGHT PERIOD OF THE DAY. (NOTE: CONTRACTOR SHALL PROGRAM FIXTURE LUMENS TO OFF OR LUMENS OUTPUT SHALL BE REDUCE TO MINIMUM 5% WHEN DURING DAY LIGHT PERIOD).
- 5. FOR EACH SPACE, THE COMBINED ILLUMINANCE FROM THE CONTROLLED LIGHTING AND DAYLIGHT SHALL NOT BE LESS THAN THE ILLUMINANCE FROM CONTROLLED LIGHTING WHEN DAYLIGHT IS AVAILABLE.
- IN AREAS SERVED BY LIGHTING THAT IS DAYLIGHT CONTROLLED LIGHTING WHEN THE ILLUMINANCE RECEIVED FROM THE DAYLIGHT IS GREATER THAN 150 PERCENT OF THE DESIGN ILLUMINANCE RECEIVED FROM THE GENERAL LIGHTING SYSTEM AT FULL POWER, THE GENERAL LIGHTING POWER IN THAT DAYLIGHT ZONE SHALL BE REDUCED BY A MINIMUM OF 65 PERCENT. (130.1(d)(2)(D)).

abode communities

IDENTIFICATION STAMP DIV. OF THE STATE ARCHITE

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APP: 03-122151 INC:

# communities architecture

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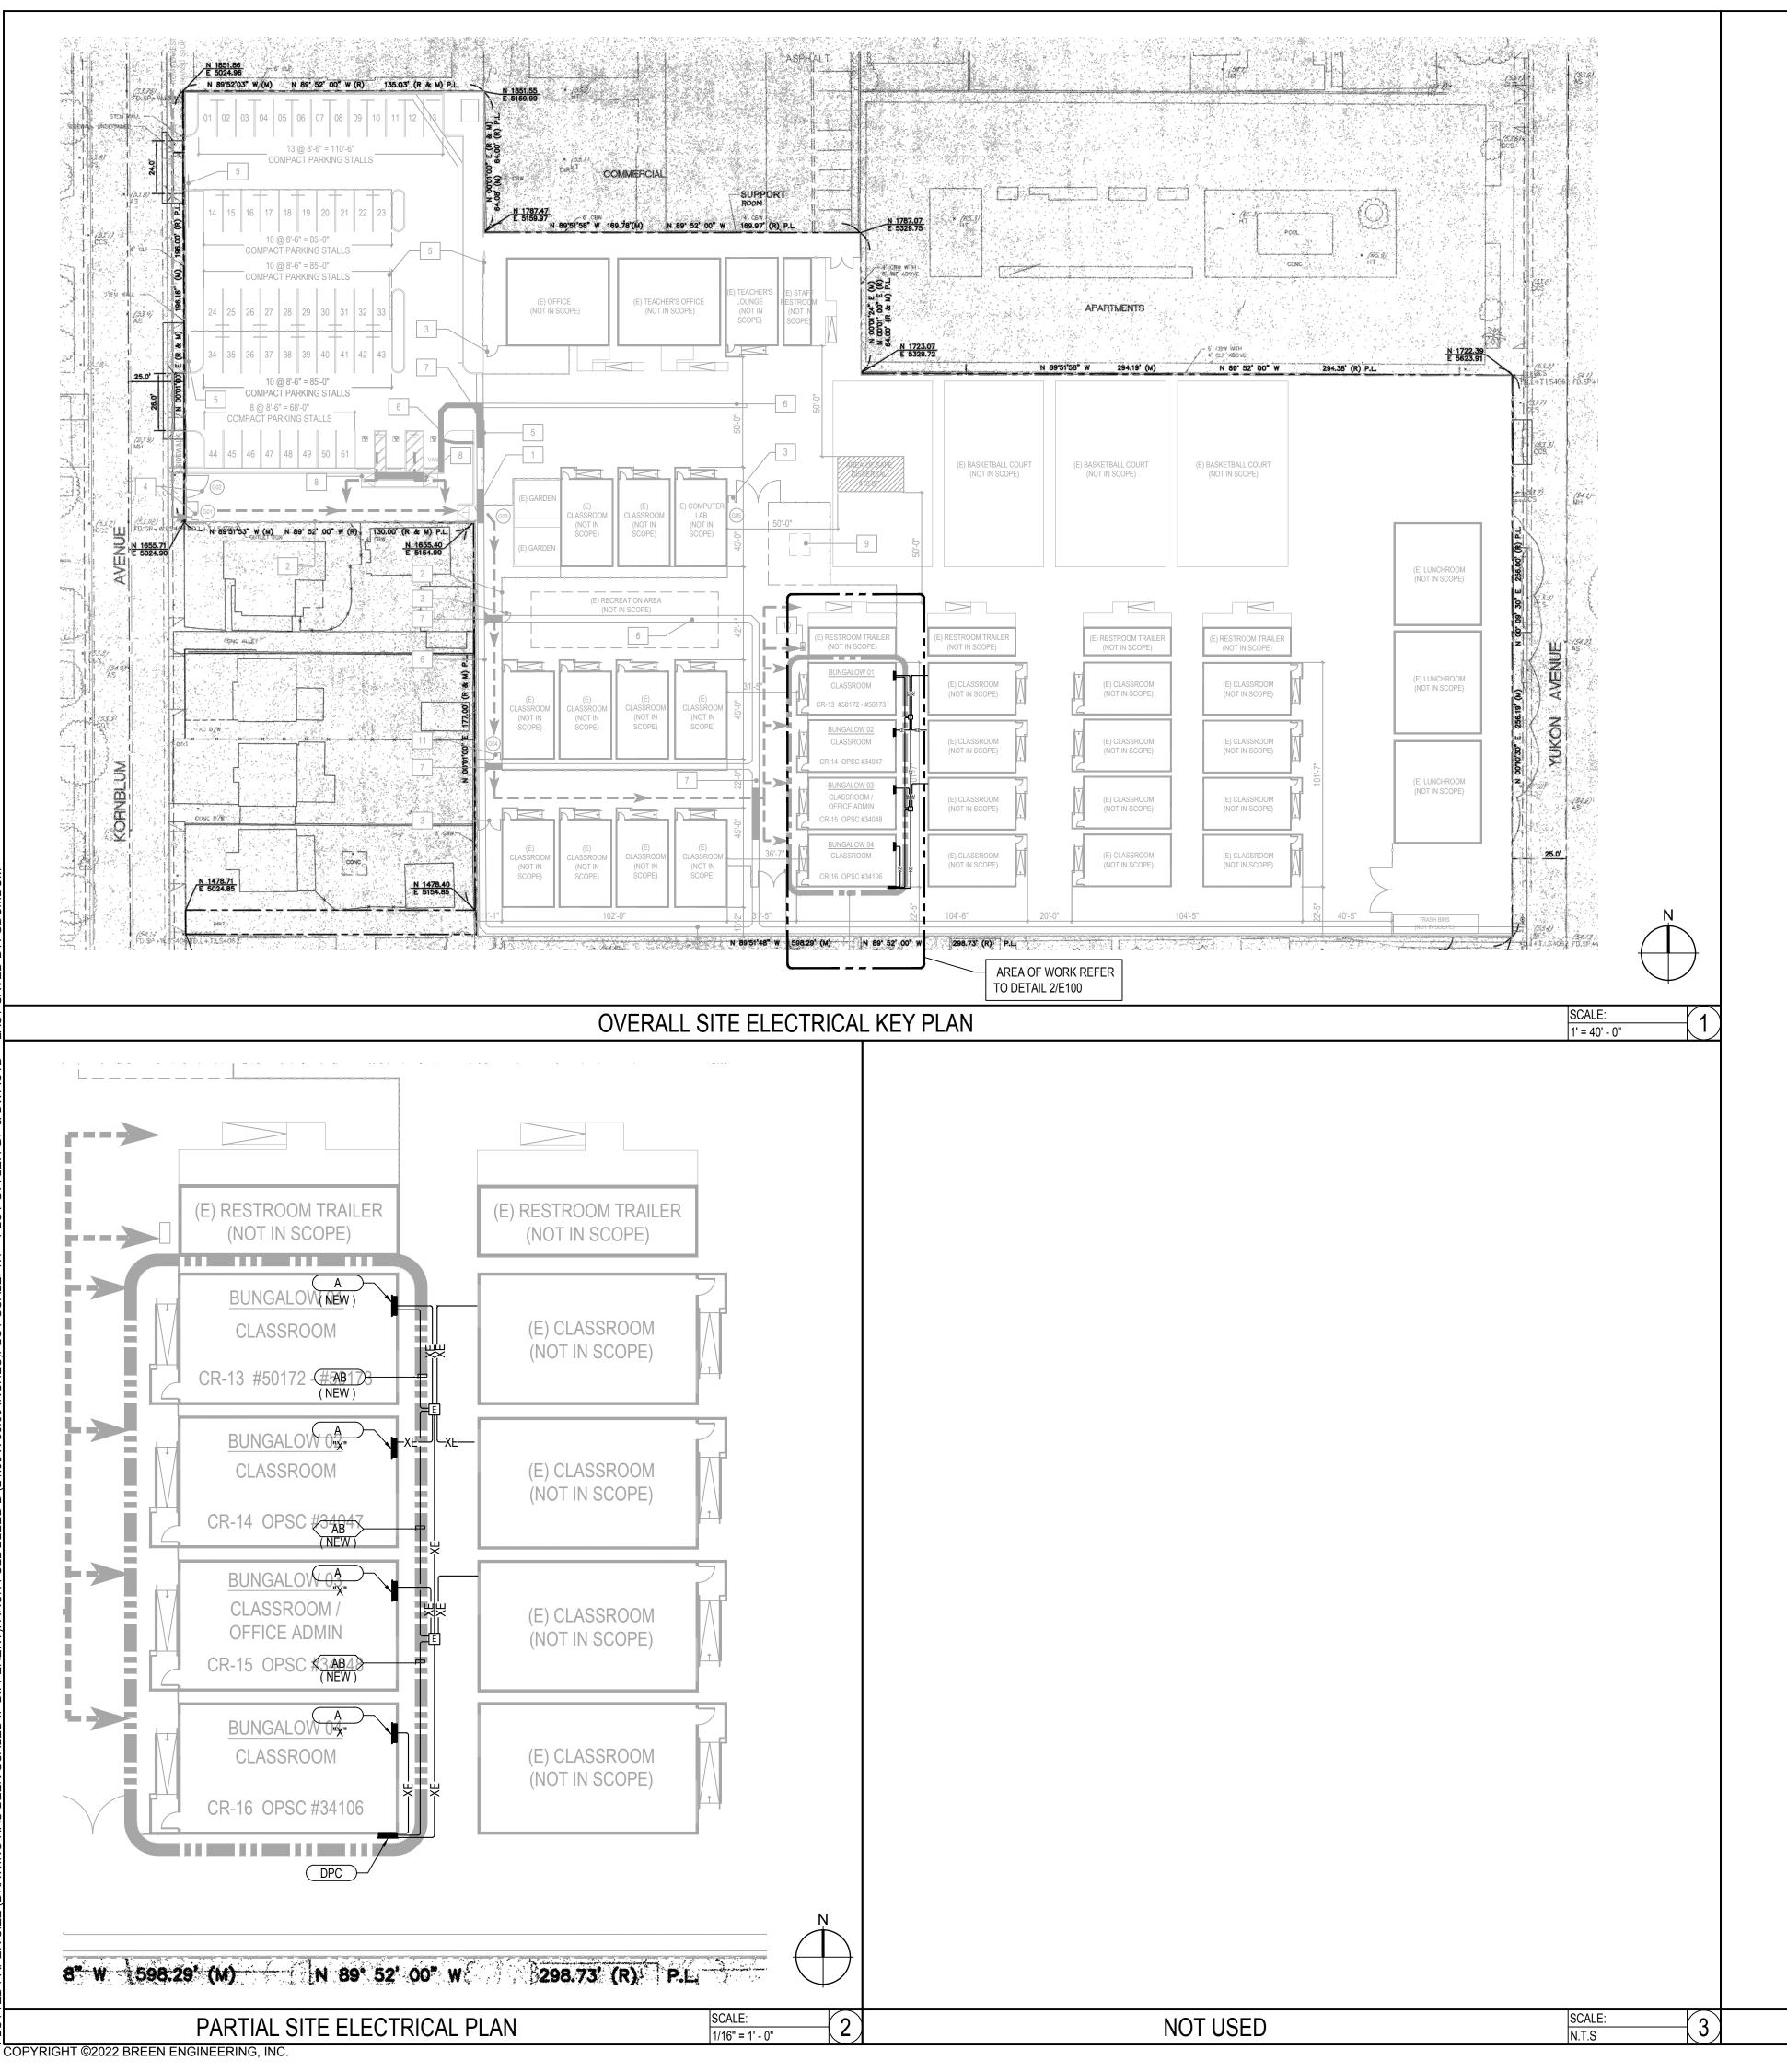
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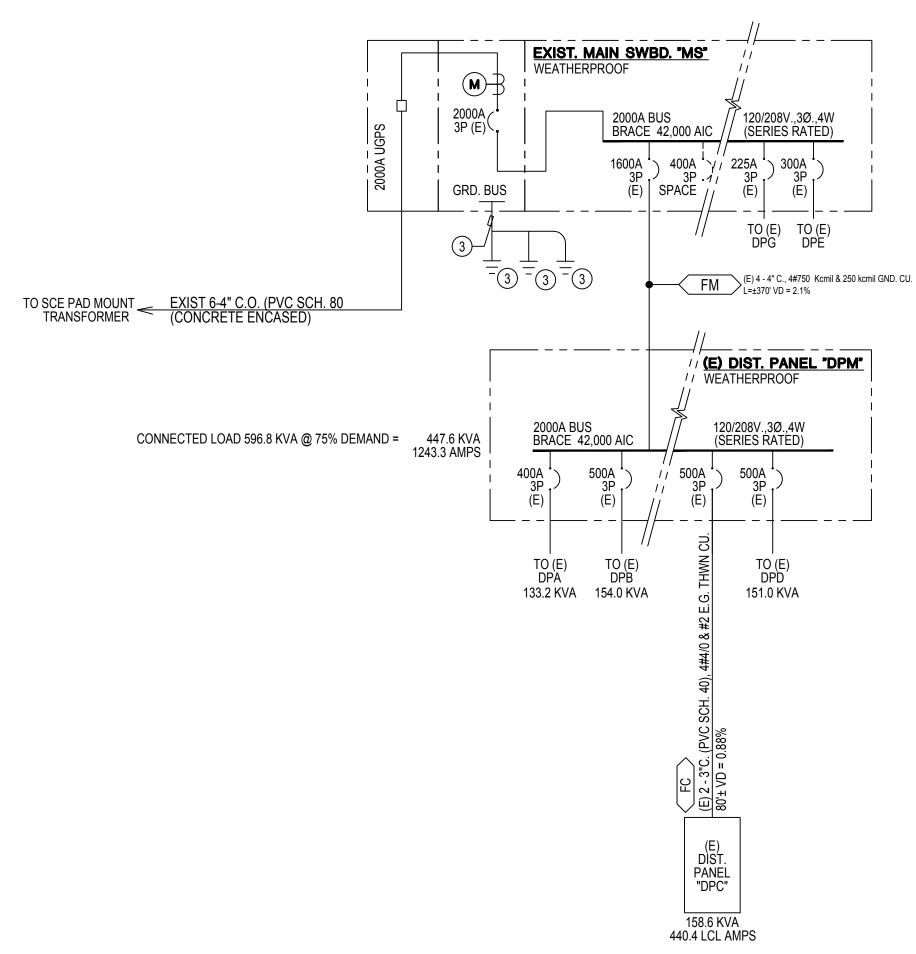
ELECTRICAL SCHEDULES & CALCULATIONS

SCALE:

SHEET NUMBER:

DRAWN BY DESIGNED BY CHECKED BY DM
APPROVED BY DM





## SINGLE LINE DIAGRAM NOTES

- ALL CONDUIT SIZES AND CONDUCTOR AMPACITY ARE BASED ON 75°C "THWN" OR "XHHW" TYPE COPPER.
- TERMINAL LUGS AT PANELBOARDS SHALL BE PROVIDED TO MATCH THE INSULATION RATING OF THE CONDUCTORS, I.E. 60° OR 75° RATING.
- VOLTAGE DROP PERCENTAGES SHOWN IN THE FEEDER CABLE SCHEDULES ARE BASED ON THE WORST CASE UNLESS OTHERWISE NOTED. THE MAXIMUM FEEDER VOLT DROP SHALL NOT EXCEED 2% AND BRANCH CIRCUITRY VOLT DROP SHALL NOT EXCEED 3% TO THE FURTHEST OUTLET, FOR A TOTAL OF 5% WITHIN THE ENTIRE ELECTRICAL DISTRIBUTION AND BRANCH CIRCUITRY SYSTEM. VOLTAGE DROP SHALL COMPLY WITH 2019 CEC AND LOCAL BUILDING CODE.
- FEEDER LENGTH SHOWN FOR VOLTAGE DROP CALCULATION ONLY. CONTRACTOR SHALL VERIFY ACTUAL LENGTH OF RUN IN THIS BID AND VERIFY ANY DISCREPANCIES WITH THE ENGINEER PRIOR TO AWARD OF CONTROL.
- 5 ELECTRICAL EQUIPMENT SHALL BE LISTED AND BY RECOGNIZED ELECTRICAL TESTING LABORATORY.

## REFERENCE NOTES

PROVIDE AT CU-1 UNIT (2) WEATHERPROOF 60AS.,3P.,50AF FUSED DISCONNECT SWITCH AND CONNECT 3#8 & 1#8 G, 3/4" WATERTIGHT FLEX CONDUIT TO EACH COMPRESSOR MOTOR AS DIRECTED BY MANUFACTURER.

SINGLE LINE DIAGRAM

N.T.S.

- 2 PROVIDE AT ELEVATOR MACHINE ROOM 60AS.,3P.,60AF CONNECT 3#6 & 1#8 G, 3/4" WATERTIGHT FLEX CONDUIT TO EACH COMPRESSOR MOTOR AS DIRECTED BY MANUFACTURER.
- 3/4"C.,1#1/0 GROUND BONDED TO BUILDING FOUNDATION #8 20 FOOT LONG RE-BAR UFER GROUND, (2) 3/4"Ø.x 8 FT LONG COPPER DRIVEN GROUND RODS AND (IF AVAILABLE) METAL COLD WATER LINE (WITHIN 5FT OF BUILDING POINT OF ENTRY).
- PANEL AND CIRCUIT BREAKERS TO BE FULLY BRACE 42,000 AIC

## (E) SITE ELECTRICAL DISTRIBUTION PANEL BY SQUARE 'D' MOUNTED ON EXISTING BUILDING CR \*16

	TYPE	120/208 <b>VOLTS</b> 3 <b>PHASE</b>				DI	ST		PA	ION NEL ATION		-	<b>"</b> 16 (BU	NGALC			N B	KR: L	.UGS ON	ILY	600 <b>A. Bussing</b>	TYPE	
REMARKS	BREAKER	4 <b>WIRE</b> PANEL AND CIRCUIT BREAKERS	BRACE	FEEDE ACE FOR 10,000 AIC												ENT	TER ·	CAB'T	. AT	BOTTO	M SURFACE MTG.	BREAKER	REMARKS
	BRE	LOCATION		LT AM		LTG	REC	MIS	CIR	BKR			BKR	CIR	MIS	REC	LTG		DLT AM		LOCATION		Ĭ,
		- 00.05	φA	φВ	φC	LCL			<u> </u>	00.7	<u> </u>	1 1	1		+-	-	LCL	•		фC	(5) 00 110		╨
1		= SPARE	0			_	<u> </u>	_	1	90/	┦		90	+	+	<del>  -</del>	_	7072			(E) CR #9	<u> </u>	╀-
1		= W/CIR. #1		0	<b>5</b>	_	-	-	3	/2	†	1	/2	4	+	<u> -</u>	-		7072	7070	W/CIR. #2	<u> </u>	<u> </u>
1		=(E) CR #14			5412	_	-	1	5	90/	17	11	90	6	+ <u> </u>	-	4			/0/2	(E) CR #10	<u> </u>	<u> </u>
1		= W/CIR. #5	6048			_	-	L.	7	/2	🕈	$\top$	/2	8	+	-	-	7072	1		W/CIR. #6	<u> </u>	<b>!</b> -
1		=(E) CR #15		6768		_	<u> </u>	1	9	90/	↓†	•	·   90	10	+-	<del>  -</del>	-		7072		(E) CR #11	<u> </u>	ᆣ
1		= W/CIR. #9			5052	_	<u> </u>	_	11	/2	1 🕇	1 🕈	/2	12	+	<u>↓−</u>	_			7072	W/CIR. #8	<b>I</b>	┷
1		=(E) CR #16	6242			_	<u> </u>	1	13	90/	╛╇	$\top$	90	14	+ <u> </u>	<del>↓</del> -	-	7072			(E) CR #12	<u> </u>	<u> </u>
1		=W/CIR. #13		5812		-	<u> </u>	_	15	/2	1 🕇	+ +	/2	16		↓-	_		7072		W/CIR. #14	<u> </u>	<u> </u>
1		=(E) PORT RESTROOM BLD'G			2080	_	-	1	17	60/	1 🕇	+	20/			<u> </u>	5			1080	(E) EXTERIOR LIGHTS	<u> </u>	<u> </u>
1		=W/CIR. #17	2080			_	<u> </u>	_	19	/2	╛	+	20/	_	+	<u> </u>	5	1080			(E) EXTERIOR LIGHTS	<u> </u>	<u> </u>
1		=(E) PORT RESTROOM BLD'G		2080		_	<u> </u>	1	21	60/	] 🕇	++	20/	_	<u> </u>	1	_		180		(E) GFCI WP RECEPTACLE	<u> </u>	<u> </u>
-		=W/CIR. #19			2080	_	-		23	/2	] 🕂	+	20/	24	<u> </u>	<u> </u>	<u> </u>			100	(E) 24V CONTROL TRANSF.	<u> </u>	<u> </u>
-	-	= SPARE	0			_	_	_	25	20/1	<b>│ →</b>	+	200	, 26	-	-	_	19234	-		CR. #13 (BUNGALOW 1)	= -	N
-	-	= SPARE		0		-	_	_	27	20/1	] +	++	·	28		<u> </u>	_		17932		W/CIR. #26	<u> </u>	N
-	-	= SPARE			0	_	<u> </u>	_	29	20/1	] +	+	· [ 3	30		<u> </u>	_			18272	W/CIR. #26	_= -	N
-	-	= SPACE	0			-	-	_	31	20/1	<u></u> →	+	·	32		-	_	-			SPARE	= -	_
-	1	= SPACE		_		_	-	-	33	_	] +	++	· 📗 🗕	34	-	-	_		_		SPACE	= -	-
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		TOTAL CONNECTED LOA	<b>D:</b> 15	8108	W	AT	TS (	OR	438	.9 AN	IPS	• 2	08 VO	LTS	-	3 <b>ø</b>						3	
		= LCL: 2160 VA x 125% = 2700 VA = = = = = = = = = = = = = = = = = =														3							
															<b>=</b>								
		HACR = HACR TYPE CIRCUIT		R L	/0 =	PRO	VIDE	LOC	K-01	FF DEVI	CE O	N CIRC	uit bre	AKER	Al	FCI =	= ARC	FAUL	T INTER	RUPTING	TYPE CIRCUIT BREAKER	#	
		= GFCI = GROUND FAULT INTER	RRUPTIN	G TYPE	CIRCU	IT B	REAKI	ER														#	
							,																

PARTIAL SINGLE LINE DIAGRAM

DRAWN BY DESIGNED BY CHECKED BY DM
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SS FLS ACS DATE: 11/02/2022

# abode communities architecture

PROJECT:

## LAEP EARLY CHILDHOOD CENTER

13928 KORNBLUM AVE. HAWTHORNE, CA 90250

CLIENT:

Los Angeles Education

Partnership 1541 Wilshire Blvd., Suite 200 Los Angeles, CA 90017 T: 213.622.5237

ARCHITECT:

Abode Communities 1149 S. Hill Street, Suite 700 Los Angeles, CA 90015 T: 213.629.2702

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1983 WEST 190TH STREET, SUITE 200 TORRANCE, CA 90504 **TEL:** (310) 464-8404 **FAX:** (310) 464-8408 WWW.BREENENG.COM

DSA APPLICATION NUMBER: 03-122151
PROJECT NO: 219-22-001

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PROGRESS SET 02.01.22

DSA PROGRESS SET 03.02.22

DSA APPLICATION SET 04.01.22


DSA BACK-CHECK SET 10.05.22


DSA BACK-CHECK SET 10.24.22

SHEET NAME:
ELECTRICAL SITE PLAN

SCALE: AS NOTED

SHEET NUMBER: **E1.00** 

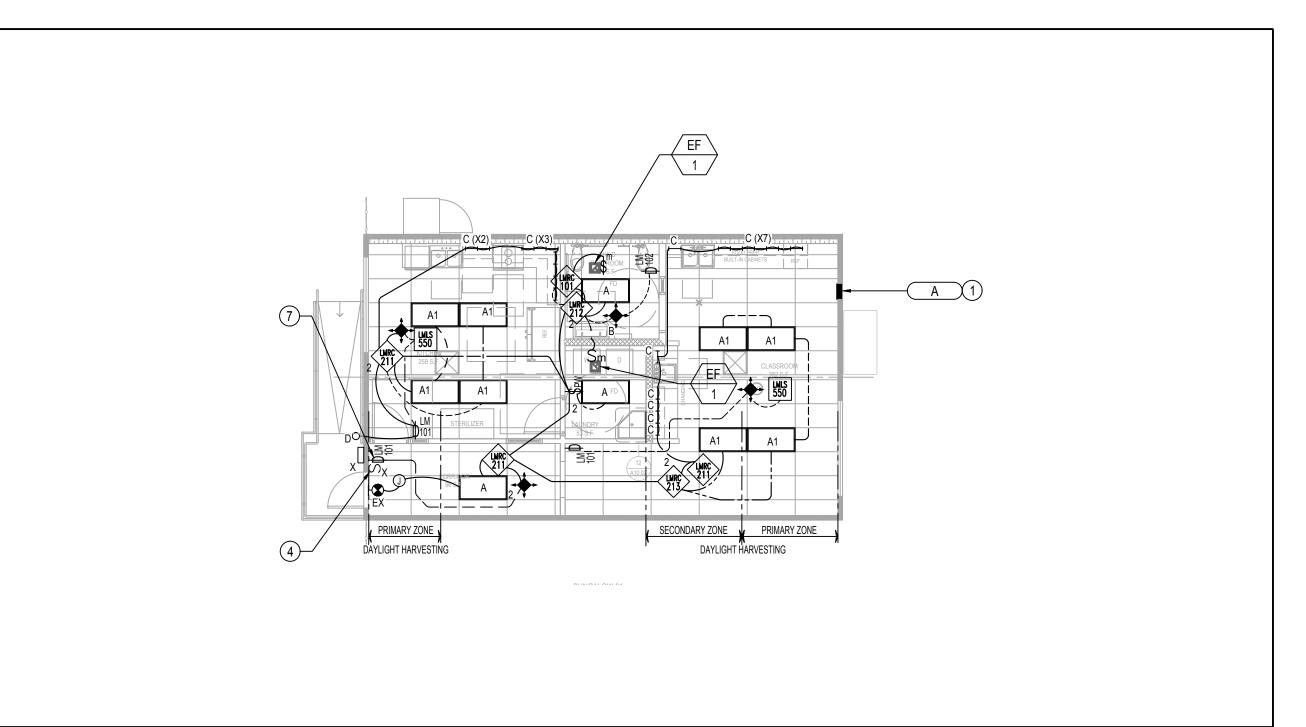


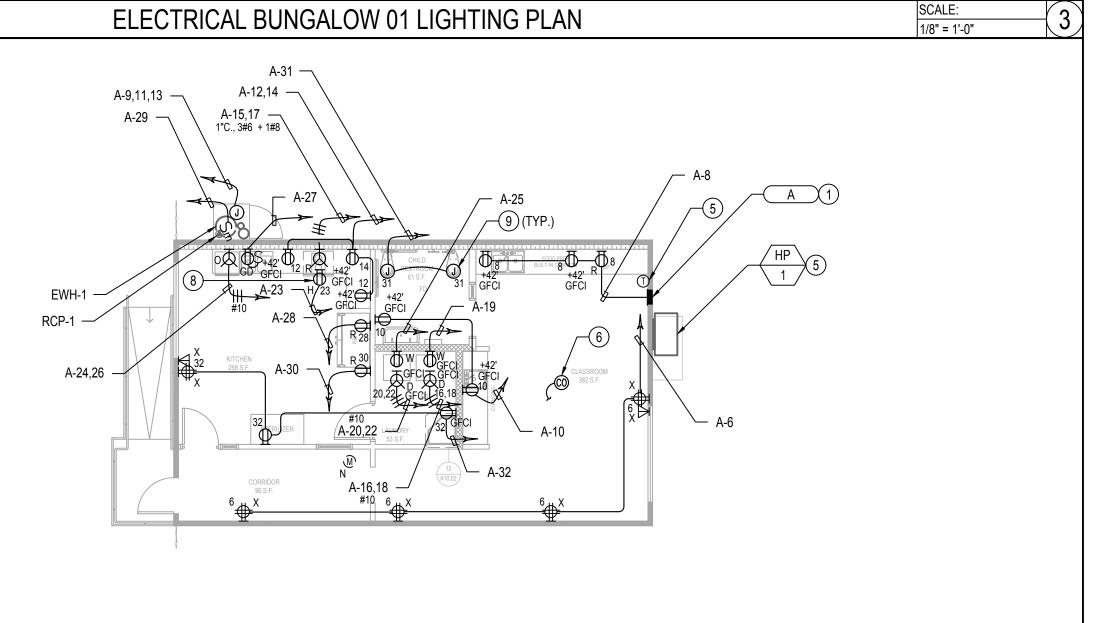

SCALE:

SCALE: 1/8" = 1'-0"

1/8" = 1'-0"

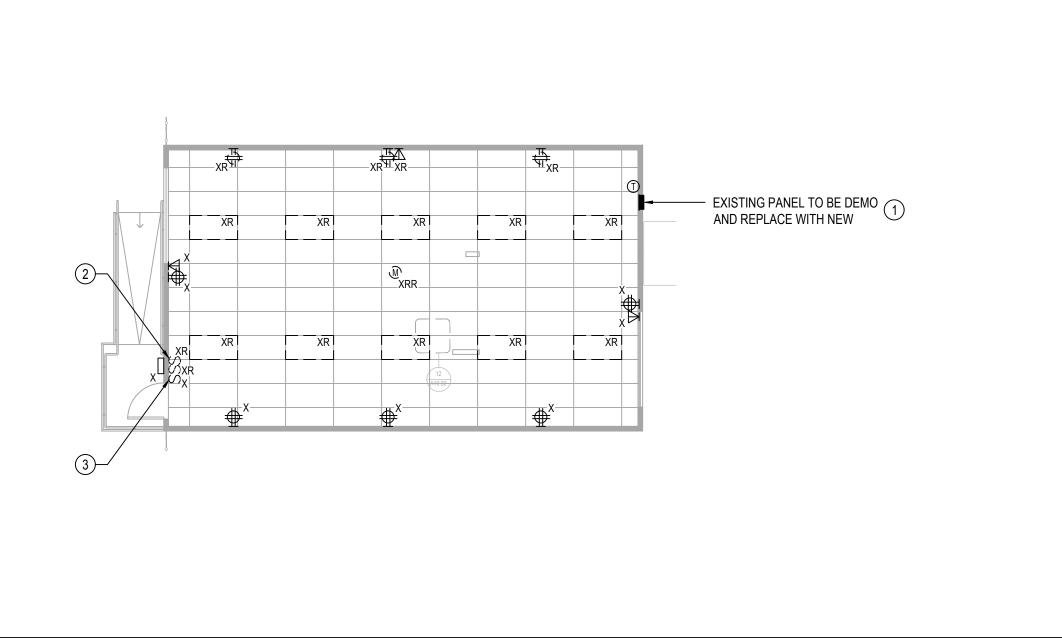

**ELECTRICAL BUNGALOW 01 POWER PLAN** 

ELECTRICAL BUNGALOW 01 DEMOLITION PLAN

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## REFERENCE NOTES

- PRIOR TO START OF WORK (I.E. ELECTRICAL DEMO OR CONSTRUCTION), CONTRACTOR SHALL VERIFY EXISTING PANEL INSTALLATION TO DETERMINE ALL LABOR, TOOLS AND MATERIAL REQUIRED FOR DEMO AND NEW ELECTRICAL WORK AS SHOWN.
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- DEMO AND REMOVED EXISTING PANEL AND PROVIDE NEW REPLACEMENT PANEL AS SHOWN.
- 3. PROVIDE NEW TYPE WRITTEN PANEL CIRCUIT DIRECTORY CARD
- DEMO, DISCONNECT AND REMOVE EXISTING LIGHTS SWITCHES SERVING THE EXISTING LIGHTING.
- 3 EXISTING LIGHT SWITCH WHICH SERVE AND CONTROL THE BUILDING EXTERIOR LIGHT TO REMAIN IN PLACE AND IN SERVICE FOR SCHOOL DISTRICT USE.
- 4 EXISTING WALL ELECTRICAL OUTLET (I.E. DUPLEX RECEPTACLES) AND/OR DEVICE (I.E. SWITCH) TO BE RECONNECTED TO NEW BRANCH CIRCUITRY SHOWN.
- 5 EXISTING HVAC SYSTEM EQUIPMENT AND THERMOSTAT TO REMAIN IN PLACE AND IN SERVICE FOR SCHOOL DISTRICT USE.
- 6 IN THE IMMEDIATE VICINITY OF THE CHILD CARE/NURSERY AREA, PROVIDE U.L. LISTED CEILING MOUNTED 120 VOLT OPERATION (WITH BATTERY BACK-UP PER CBC 420.6) CARBON MONOXIDE ALARM DETECTOR COMPLETE WITH OUTLET BOX, INTERNAL ALARM THAT EMIT A SIGNAL. CONNECT TO UN-SWITCHED HOT WIRE OF LOCAL LIGHTING CIRCUIT. VERIFY AND COORDINATE EXACT DETAILS PRIOR TO ROUGH-INS.
- 7 FOR THE EXISTING LIGHT SWITCH AND INSTALLATION OF NEW LOW VOLTAGE LIGHTING CONTROL PROVIDE NEW NEW MULTI-GANG COVERPLATE.
- 8 120V RECEPTACLE LOCATED WITHIN CABINET ABOVE FOR HOOD EXHAUST.
- 9 PROVIDE J-BOX AND CONNECT PER MANUFACTURER'S RECOMMENDATION FOR AUTOMATED FLUSHOMETER URINAL AND ELECTRONIC SENSOR FAUCETS AND WATER CLOSETS. 120V 50VA. CONTROL TO SPARE 120V CIRCUIT ON PANEL B OR P-B FOR THIS

(E) PORTABLE CLASSROOM BUILDING PANEL (MFR. BY SQAURE 'D') TO BE DEMO AND REPLACE WITH NEW

		120/208	VOLTS					F	PAN	NEL	"A	<b>39</b>					MAI	N BK	<b>(R:</b> 1	00A,2P	22,000 <b>AIC</b>			
S	щ	1	PHASE					L	.OC#	ATION	(E)	PORT.	CR	13		(X =	C.F	R. NU	MBER)		100A <b>Bussing</b>		щ	
RK\NOTE!	KER TYPE	3	WIRE					F	EED	DER SE	E SII AGRA	NÇĻE M	LINE				ENT	ER (	CAB'T	. AT	FLUSH MTG.		KER TYPE	
REMARK	BREAKER		LOCATION	VOLT • A	AMPS • B	LTG OR LC L	REC	MIS	CIR	BKR			E	3KR	CIR	MIS	REC	LTG OR LC L	VOLT • A	AMPS • B	LOCATION		BREAKER	
=	HACR	=(E) REC'S		-		-	-	-	1	20/1	+		-	50/	2	-	-	1	2652		(E) HP-1 UNIT	=	HACR	ì
-	HACR	=(E) REC'S			-	<u> </u>	-	-	3	20/1	1 +	—∳	- 🗁	2	4	-	-	1		2652	SMALL APPL	=	HACR	į
-	HACR	= NO LABEL		-		-	-	-	5	20/1	Ì →		-	30/	6	-	-	-	0		(E) HEATER NOT USED OFF (SPARI	:) =	HACR	į
-	-	= SPACE			-	-	-	-	7	-	1+	<del> </del>	- 🗁	2	8	-	-	-		0	W/CIR. #6		HACR	į
-	HACR	=(E) LIGHTS C	CR/EXT LT'S	250		5	-	-	9	20/1	<b>1</b> →		-	-	10	-	-	-	-		SPACE	=	-	
-	-	=(E) LIGHTS C	R/EXT LT'S		250	5	-	-	11	20/1	1+	<del></del>	- [	-	12	-	-	-		-	SPACE	=	-	1
		=									] '	'												
		<b>- φ Α</b> • 2902	VA				φВ	290	)2 VA	١												=		
		TOTAL CO	NNECTED LOAD: 580	4		VA	C	R	27.	9 <b>AN</b>	IPS	• 2	208	VOL	TS	- 1	Ιφ	PE	R CEC	220.82	LOAD CALCULATION	=		
		= <b>LCL:</b> 5304	$VA \times 125\% = 6630 VA$																			=		
		FDI - 7130	VA OR 34.3 AMPS																			=		
		_ · <del></del> , 100																						
			OR TYPE CIRCUIT BREAKE	R L	./0 =	PRO\	/IDE	LOCK	-OFF	DEVIC	E ON	CIRCL	JIT B	REAKE	R	AF	CI =	ARC	FAULT	INTERR	RUPTING TYPE CIRCUIT BREAKER FAULT ABD GROUND FAULT E CIRCUIT BREAKER.	Ξ		

INI PORTABLE	CLASSROOM	BUILDING	REPLACEMENT	PANEL	IMFR.	BY	SQAURE 'D'I
IN PUNIABLE	CLASSICUM	DUILDING	REPLACEMENT	PANEL	IMITH.	DІ	SUMURE D

	TYPE	120/208 <b>VOLTS</b> 3 <b>PHASE</b>								NEL ATION	<b>" /</b>	•	R. 1	3 (BUN	GALO)			N BK	<b>(R:</b> 20	00		200 <b>A. Bussing</b>	TYPE	
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	JÄE.	LOCATION	VO	LT AN	IPS	LTG	DEC	МІС	CIP	BKR				BKR	CIP	МІФ	DEC	LTG	VO	LT AN	IP8	LOCATION	JRE,	REW
		LOCATION	φA	φB	φC	LCL	, LEO		OIR	DICIT						IMIG	, LEO	LCL	φА	φB	φC		3	Ľ
-	HACR	=(E) HP-1 HEAT PUMP	2652			_	_	_	1	60/	<u></u> →	+	+	20/1	2	3	_	29	699			LIGHTING/EXT, LIGHT =	-	<u>l</u> -
-		=W/CIR. #1		2652		_	-	_	3	/2	] +	+	+	20/1	4	-	6	-		1080		WALL REC'S =	-	<u> </u>
-	HACR	=(E) HEAT PUMP (ELEC HTR)			1882	_	_	1	5	30⁄	] +		+	20/1	6	-	8	-			1440	WALL REC'S =	-	-
-		=W/CIR. #5	1882			_	_		7	/2	] 👆		+	20/1	8	_	2	-	1500			REFRIG./COUNTER APP. REC'S.	-	-
-	-	= ELECTRIC WATER HEATER		4000		1	_	1	9	60/	] +	<del>-</del>	+	20/1	10	_	2	-		1500		RESTROOMS/COUNTER APP. REC'S	•	-
-	-	=W/CIR. #9			4000	1	_	_	11		] +		+	20/1	12	-	2	_			1500	COUNTER APP. REC'S. =	-	-
-	-	=W/CIR. #9	4000			1	-	_	13	/3	] →		+	20/1	14	-	2	-	1500			COUNTER APP. REC'S. =	-	Γ
-	-	= ELECTRIC RANGE		4000		-	-	_	15	50/	1+	<b>-</b> ∳-	+	30/	16	-	1	-		2250		ELECTRIC DRYER =	-	Γ
-	-	=W/CIR. #15			4000	-	-	_	17	/2	1+	-	+	/2	18	-	-	-			2250	W/CIR. #16 =	-	Γ
-	-	= WASHER	1500			-	1	-	19	20/1	] →		+	30/	20	-	1	-	2250			ELECTRIC DRYER =	-	Γ
L/0	-	FIRE ALARM FCPS		100		_	-	1	21	20/1	1+	-∳-	+	/2	22	-	-	- 1		2250		W/CIR. #16 =	-	1-
- 1	-	= HOOD			200	-	1	-	23	15/1	1+		+	30/	24	-	1	-			2500	ELECTRIC BUILT-IN OVEN =	-	1-
-	-	= WASHER	1200			_	1	-	25	20/1	<b>1</b> →		+	/2	26	-	-	- 1	2500			W/CIR. #24 =	-	1-
- 1	-	=(N) GARBAGE DISPOSAL		460		-	-	-	27	20/1	1+	-∳-	+	15/1	28	-	1	- 1		1200		REFRIGERATOR =	-	-
- 1	_	=RCP-1			200	-	-	-	29	20/1	14	-	+	15/1	30	-	1	- 1			1500	REFRIGERATOR =	-	1-
- 1	_	=LAV/URINAL/WC SENSOR	200			-	T -	2	31	20/1	1 →	-	+	20/1	32	T -	3	-	750			KITCHEN/STERILIZER/LAUNDRY RECP. =	-	1 -
- 1	_	= SPACE		_		-	-	-	33	_	14		+	_	34	<b> </b>	-	T - 1		_		SPACE =	-	1-
- 1	_	= SPACE			-	-	-	-	35	-	14	-	+	_	36	-	-	-			-	SPACE =	-	1-
-	_	= SPACE	-			-	-	-	37	-	<b>│</b> -∳		+	_	38	-	-	-	-			SPACE =	-	1-
-	-	= SPACE		_		-	-	-	39	_	14		+	_	40	-	-	- 1		_		SPACE =	-	1-
-	_	= SPACE			-	-	-	-	41	-	14	-	<b>+</b>	_	42	-	-	- 1			_	SPACE =	-	1-
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		<b>- φ Α=</b> 20633 VA					φВ	194	92 \	/A					'			_	C= 19	9472 V	/A			
		TOTAL CONNECTED LOA	<b>D:</b> 5	9597	W	AT	TS	OR	165	.4 AN	1PS	•	20	8 VOL	.TS	- 3	3 Ø		-			=		
		<b>LCL:</b> 12699 VA x 125% = 1	15874 \	VA																		=		
		F <b>DL:</b> 62772 VA OR 174.2 A HACR = HACR TYPE CIRCUIT	MPS		./0 =	PRO	VIDE	LOC	K-01	N DEVIC	E 01	N CIR	RCUI	T BREAK	KER	AF	-CI =	ARC	FAULT	INTER	RUPTING	= G TYPE CIRCUIT BREAKER =		
		= GFCI = GROUND FAULT INTE			•																	Ξ		

2 AND/OR 3 HOMERUNS), CONTRACTOR SHALL FIELD INSTALL ON ALL MULTI-USE CIRCUIT BREAKERS APPROVED HANDLE TIE (PER CEC 210.4(B))

NOTE:
1. PROVIDE CIRCUIT BREAKER LOCK—ON CLIP AND PAINT CIRCUIT BREAKER "RED"

IDENTIFICATION STAMP DIV. OF THE STATE ARCHITECT APP: 03-122151 INC:

REVIEWED FOR

SS FLS ACS D

DATE: 11/02/2022

# abode communities architecture

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PROGRESS SET 02.01.22

DSA PROGRESS SET 03.02.22

DSA APPLICATION SET 04.01.22

DSA BACK-CHECK SET 10.05.22

DSA BACK-CHECK SET 10.24.22

SHEET NAME:

ELECTRICAL BUNGALOW 01 FLOOR PLANS

SCALE:

DRAWN BY
DESIGNED BY


CHECKED BY

APPROVED BY

SHEET NUMBER:

**E2.01** 

AS NOTED

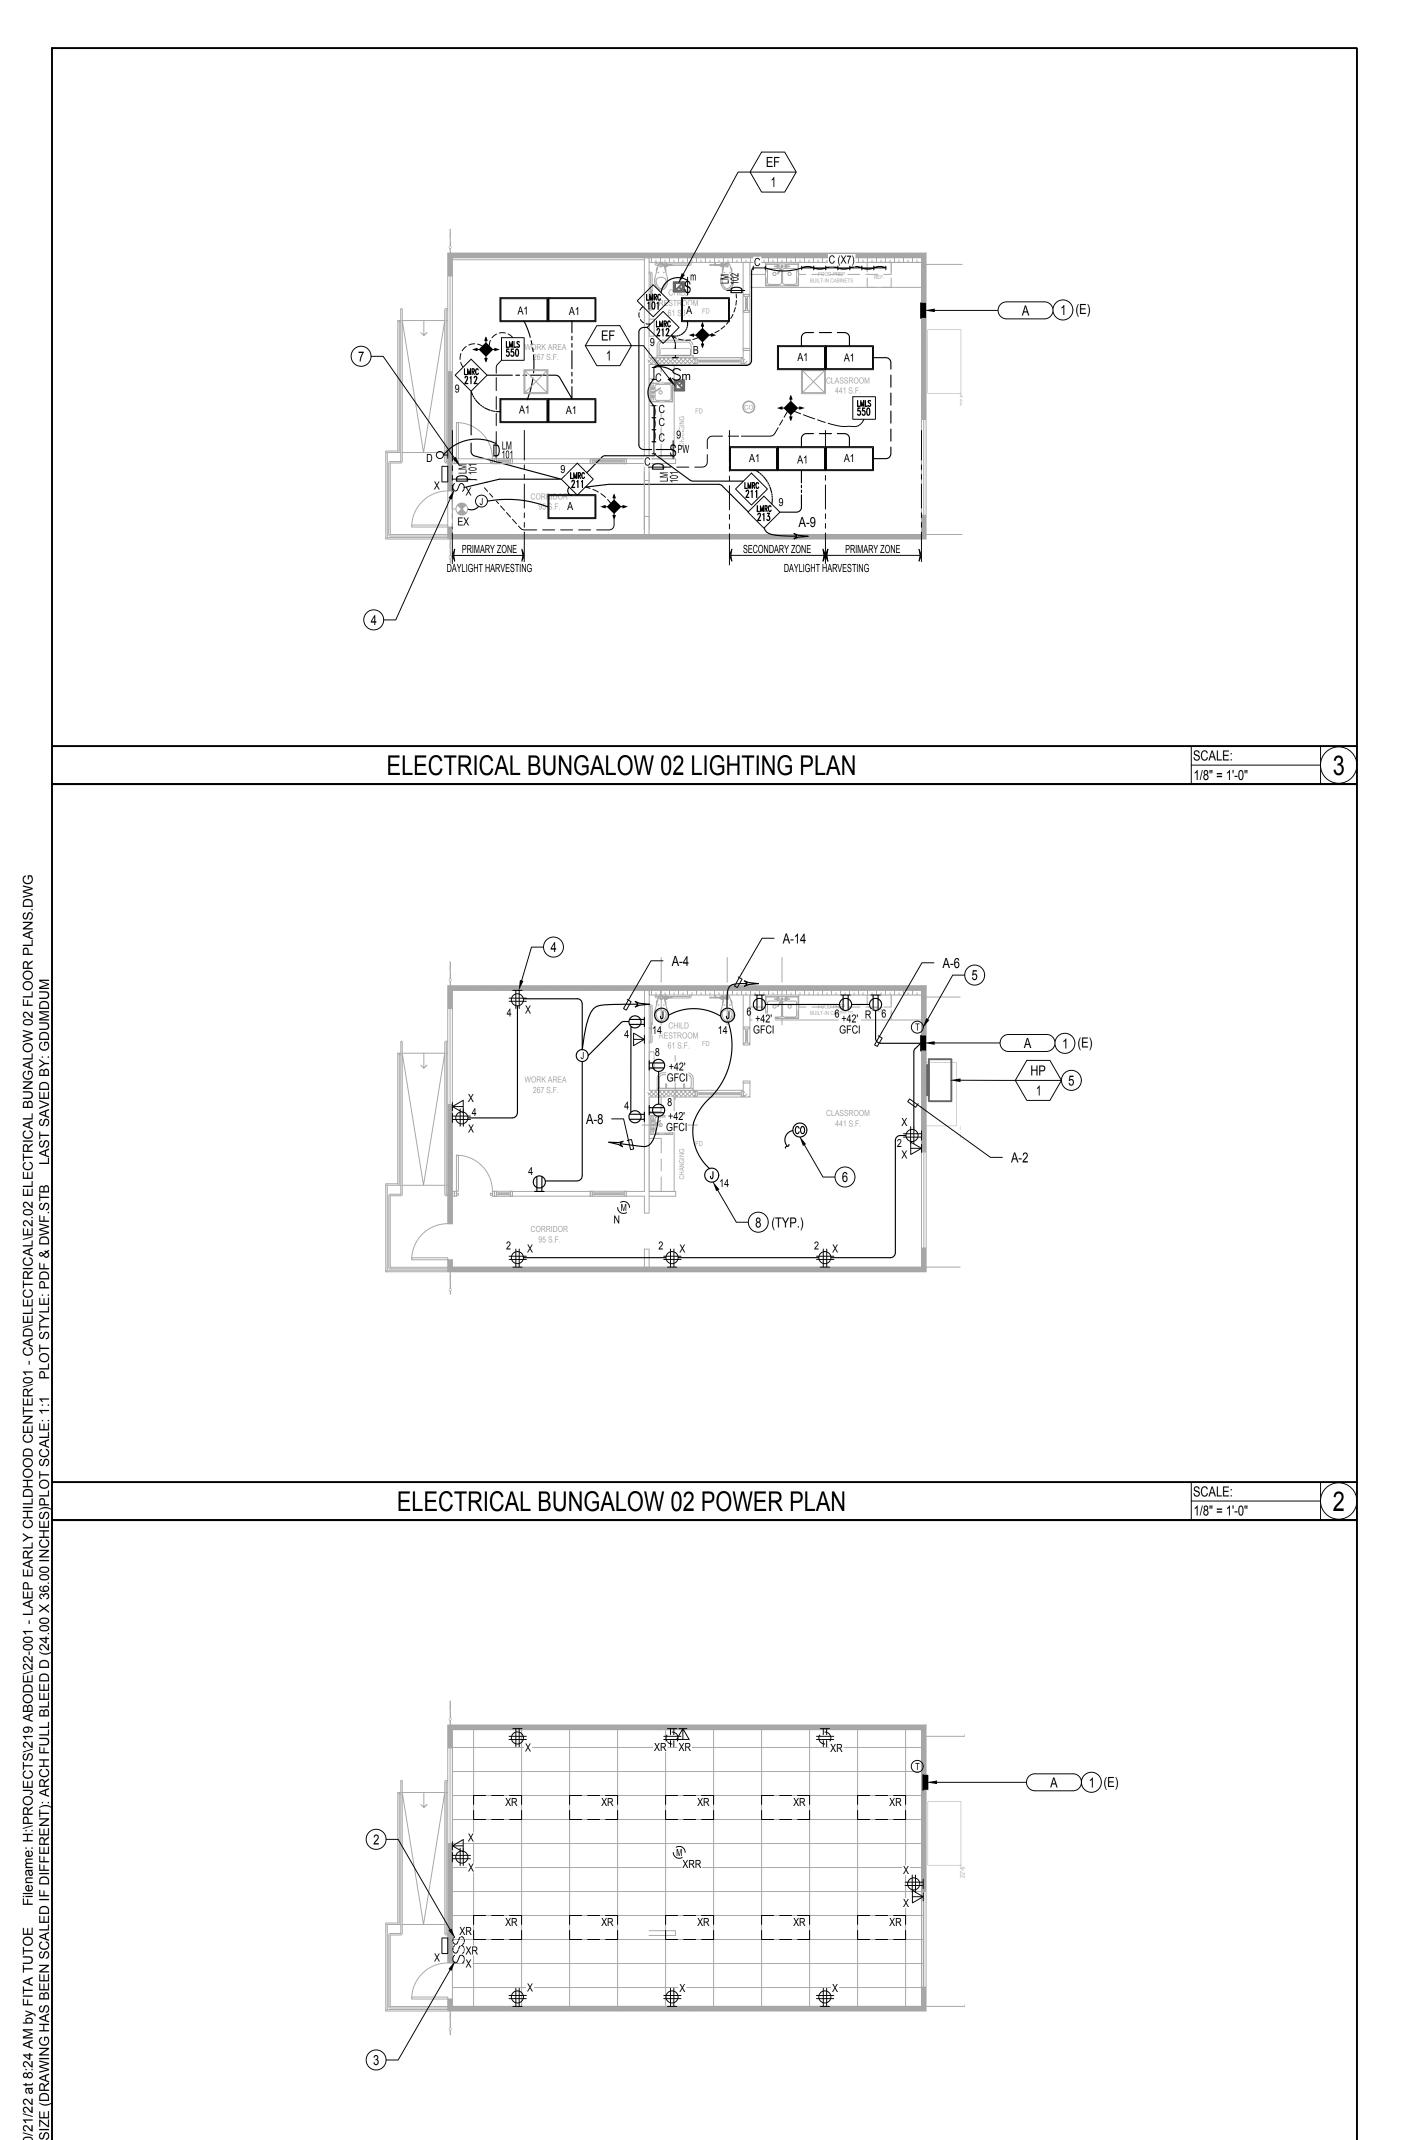

ELECTRICAL BUNGALOW 02 DEMOLITION PLAN

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## REFERENCE NOTES

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- 9 CONNECT LOW VOLTAGE WIRING TO ROOM CORRESPONDING LV LIGHTING CONTROLLER.

SCALE:

1/8" = 1'-0"

١		120/208 <b>VOLTS</b>					•	PAI	NEL	"A"				MAI	N BI	<b>CR:</b> 1	00A,2P	22,000 AIC		
3	мī	1 PHASE					L	.oc	ATION	(E) PORT. (	CR 14		(X =	= C.F	R. NU	JMBER)		100A <b>Bussing</b>	سا	l
KEMAKK (NOIES	KER TYPE	3 <b>WIRE</b>					F	FEEDER SEE SINGLE LINE DIAGRAM'''					ENTER CAB'T. AT			. AT	FLUSH MTG.	KER TYPE		
I MA	REAKER		VOLT AMPS LTG OR REC MIS C		Ī <u>-</u>	Τ	T		T	T		L	LTG	G VOLT AMPS			BREAKER	l		
_	В	LOCATION			IIS CIR BKR BKR CIR MIS			MIS REC  OR  LCL		OR I		LOCATION	<u> </u>	ľ						
	HACR	=(E) HP-1 UNIT	2652		-	-	1	1	60/	+	20/1	2	-	8	_	1440		(E) REC'S	= HACR	Ι
	HACR	=W/CIR. #1		2652	-	-	-	3	/2	<b>│</b>	20/1	4	-	7	-		1260	(E) REC'S/CLOCK		Ī
1	HACR	(E) HEATER NOT USED OFF (SPARE)	0		-	-	-	5	60/	<b>                                     </b>	20/1	6	-	3	_	1500		REFRIG/COUNTER APPL. REC'S	= HACR	Ī
	HACR	=W/CIR. #5		0	-	T -	-	7	/2	<b>│</b>	20/1	8	-	2	<u> </u>		360	RESTROOMS REC'S	□HACR	Γ
7	HACR	(E) LIGHTS CR/EXT LT'S	456		25	T -	-	9	20/1	<b>│ ┿</b> ──┼	20/1	10	1	-	T -	200		RCP-1	□HACR	Γ
-	-	= SPACE		<b> </b> -	-	T -	-	11	_	<b>│</b>	20/1	12	-	-	T -		-	SPARE	= HACR	Γ
7	-	= SPACE	_		-	-	-	13	_	<b>│ ┿</b> ──┼	20/1	14	3	-	_	200		LAV/URINAL/WC SENSOR	= = =	
	-	<u> </u>		_	-	-	_	15	-	] +	_	16	-	_	_		-	SPACE	= -	
١		- - <b>φΑ</b> = 6448 VA				 ф В	<b>42</b>	 72 V	A										<b>-</b> [ -	
١		TOTAL CONNECTED LOAD: 10	720	1	VA	C	R	51.	.5 <b>AM</b>	<b>IPS ●</b> 20	10V 8	_TS	- '	1 φ	PE	R CEC	220.82	2 LOAD CALCULATION	彐	
١		LCL: 200 VA x 125% = 250 VA																	=	
١		FDL: 10770 VA OR 51.8 AMPS																	目	
١		HACR = HACR TYPE CIRCUIT BREAK	ER I	_/0 =	PRO	VIDE	LOCK	(-OFI	F DEVICE	ON CIRCUIT	T BREAK	ER	AF	FCI =	- ARC	FAULT	INTERF	RUPTING TYPE CIRCUIT BREAKER	4	
		GFCI = GROUND FAULT INTERRUPTII	IC TYPE	CIRCUIT	ΓBR	EAKEF	7						C	AG =	COM	BINATIC	N ARC	FAULT ABD GROUND FAULT E CIRCUIT BREAKER.	=	

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SHEET NAME:

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SHEET NUMBER:

SCALE:


DRAWN BY DESIGNED BY

CHECKED BY

APPROVED BY

AS NOTED

E2.02

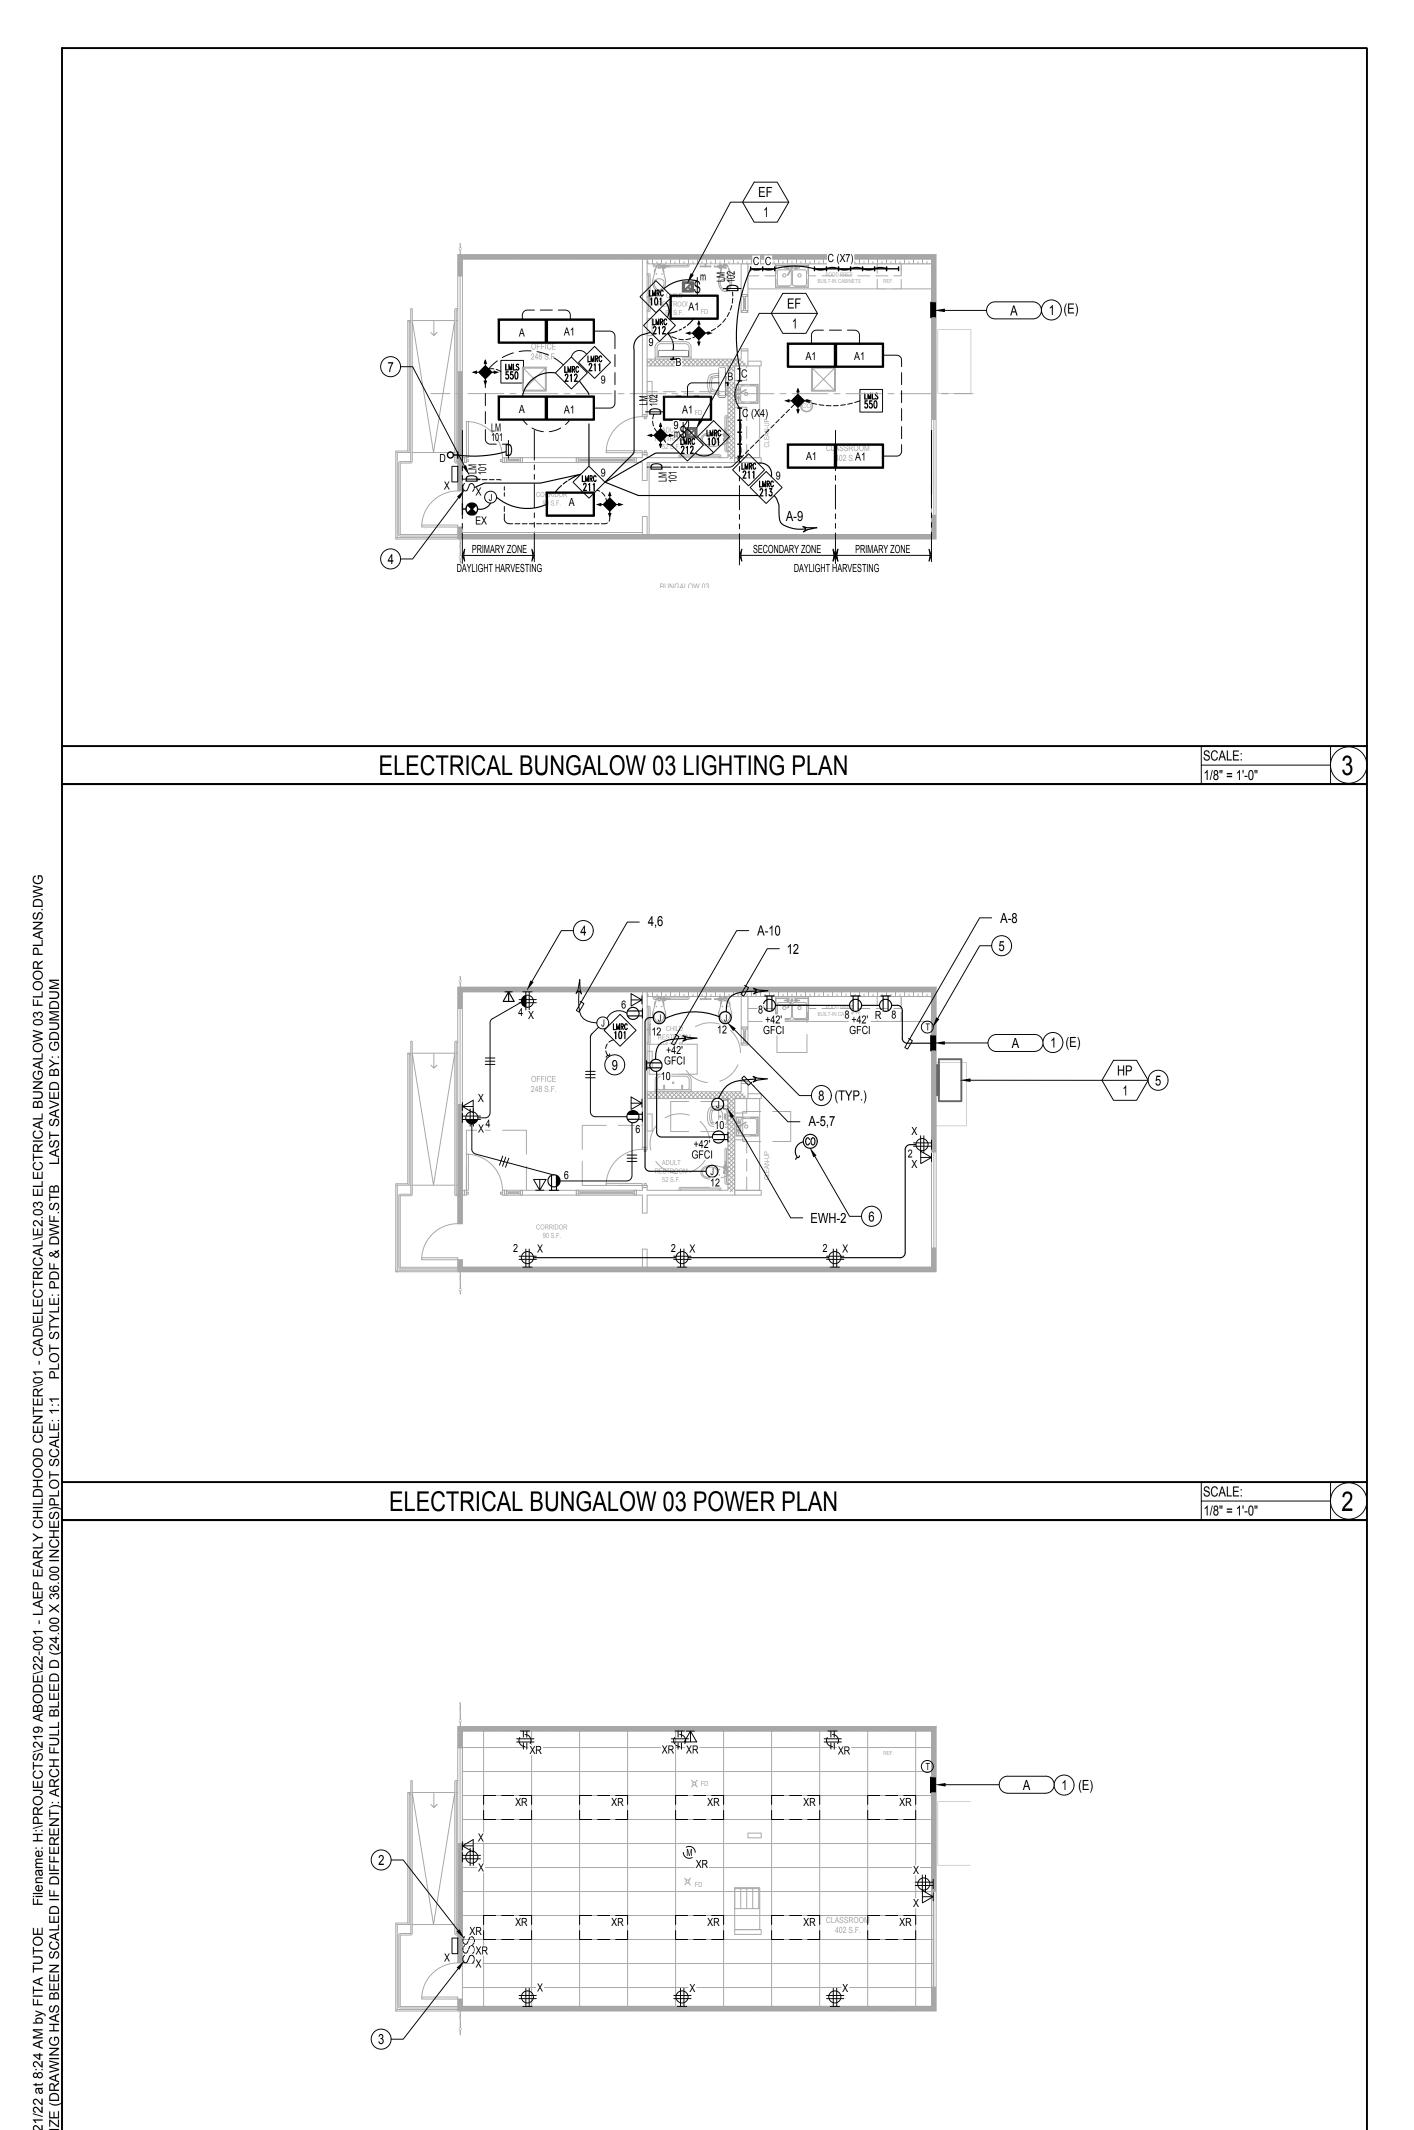

ELECTRICAL BUNGALOW 03 DEMOLITION PLAN

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- 6 IN THE IMMEDIATE VICINITY OF THE CHILD CARE/NURSERY AREA, PROVIDE U.L. LISTED CEILING MOUNTED 120 VOLT OPERATION (WITH BATTERY BACK-UP PER CBC 420.6) CARBON MONOXIDE ALARM DETECTOR COMPLETE WITH OUTLET BOX, INTERNAL ALARM THAT EMIT A SIGNAL. CONNECT TO UN-SWITCHED HOT WIRE OF LOCAL LIGHTING CIRCUIT. VERIFY AND COORDINATE EXACT DETAILS PRIOR TO ROUGH-INS.
- 7 FOR THE EXISTING LIGHT SWITCH AND INSTALLATION OF NEW LOW VOLTAGE LIGHTING CONTROL PROVIDE NEW NEW MULTI-GANG COVERPLATE.
- 8 PROVIDE J-BOX AND CONNECT PER MANUFACTURER'S RECOMMENDATION FOR AUTOMATED FLUSHOMETER URINAL AND ELECTRONIC SENSOR FAUCETS AND WATER CLOSETS. 120V 50VA. CONNECT TO SPARE 120V CIRCUIT ON PANEL B OR P-B FOR THIS
- 9 CONNECT LOW VOLTAGE WIRING TO ROOM CORRESPONDING LV LIGHTING CONTROLLER.

SCALE:

1/8" = 1'-0"

		120/208	VOLTS					F	'Al	<b>IEL</b>	"A	"				MAI	N BI	<b>KR:</b> 1	00A,2P	22,000 <b>AIC</b>		
Si	м	1	PHASE					L	OCA	TION	(E)	PORT. C	R 15		(X =	C.F	R. NU	JMBER)		100A <b>Bussing</b>	سا	S
REMARK\NOTES	REAKER TYPE	3	WIRE					FEEDER SEE SINGLE LINE DIAGRAM'''					ENTER CAB'T. AT				. AT	FLUSH MTG.	J BREAKER TYPE	REMARK\NOTES		
EMA	REA		LOCATION	VOLT AMPS LTG OR REC		MIC	CID	DVD			BKR	CIB	MIC	DEC	LTG	VOLT AMPS		LOCATION	Z KE	EMA		
~	Ф		LUCATION			LCL	REC	MI2	CIR	BKK	BKK		CIR	MIS	MIS REC C	LCL	ФΑ	<b>ф</b> B	LOCATION	Θ	<u>~</u>	
	HACR	=(E) HP-1 UN	IIT	2652		1	-	-	1	60/	+	+	20/1	2	_	8	-	1440		(E) REC'S	HACR	-
_	HACR	=W/CIR. #1			2652	1	-	_	3	/2	+	<del></del>	20/1	4	_	5	_		900	(E) REC'S/CLOCK	HACR	-
-		=WATER HEATE	:R	2050		-	_	_	5	60/	+	-+	20/1	6	-	4	_	720		OFFICE	HACR	1
-	HACR	=W/CIR. #5			2050	ı	-	_	7	/2	+	<del></del>	20/1	8	-	3	-		1500	REFRIG/COUNTER APPL. REC'S	HACR	1
1	HACR	=(E) LIGHTS C	R/EXT LT'S	456		12	-	1	9	20/1	+	<del></del>	20/1   10   -   3   -   1500   RESTROOM/COUNTER APPL. REC'S				HACR	1				
1	HACR	= SPARE	SPARE 0 11 20/1 - 20/1 12 2 200 LAV/URINAL/WC SENSOR = H							HACR	1											
1	HACR	= SPARE		0		ı	-	_	13	20/1	+	<del></del>	-	14	_	-	-	-		SPACE	<b>=</b> -	-
-	-	= SPACE			1	-	-	-	15	-	+	<del></del>	-	16	-	-	-		-	SPACE	<b>=</b> -	-
		=										'									<u> </u>	
		<b>- φ Α</b> ≈ 8818	VA				φВ	730	2 VA	1											Ξ	
		TOTAL CO	NNECTED LOAD: 1612	20	١	/A	0	R	77.	5 <b>AM</b>	PS	• 208	3 VOL	_TS	- 1	Ιφ	PE	R CEC	220.82	2 LOAD CALCULATION		
1 1		<b>LCL:</b> 3840	$VA \times 125\% = 4800 VA$																		j	
		<b>FDL:</b> 17080	VA OR 82.1 AMPS																		1	
		= HACR = HAC	OR TYPE CIRCUIT BREAKE	R L,	/0 =	PR0\	/IDE I	LOCK	-OFF	DEVICE	ON	CIRCUIT	BREAK	ER	AF	CI =	= ARC	FAULT	INTERF	RUPTING TYPE CIRCUIT BREAKER	1	
		= GFCI = GRC	OUND FAULT INTERRUPTING	TYPE (	CIRCUIT	BRE	AKEF	?							CA	4G =	INTE	BINATIC ERRUPTI	N ARC NG TYP	FAULT ABD GROUND FAULT E CIRCUIT BREAKER.	‡	
		<u> </u>																				Щ
(H)	) A	AND OD 7 11	DARD BRANCH CIRCUIT	BREAK	<u>(ERS 1</u>	H ALL PANEL BOARD BRANCH CIRCUIT BREAKERS THE FOLLOWING SHALL APPLY:  APPLY:  ON ALL MULTI-WIRED HOMERUN CIRCUIT BREAKERS (REFER TO PLANS TO DETERMINE 2 AND/OR 3 HOMERUNS), CONTRACTOR SHALL FIELD INSTALL ON ALL MULTI-USE CIRCUIT BREAKERS APPROVED HANDLE TIE (PER CEC 210.4(B))																

IDENTIFICATION STAMP DIV. OF THE STATE ARCHITECT

APP: 03-122151 INC:

REVIEWED FOR

SS FLS ACS D

DATE: 11/02/2022

# abode communities architecture

PROJECT:

## LAEP EARLY CHILDHOOD CENTER

13928 KORNBLUM AVE. HAWTHORNE, CA 90250

CLIENT:

Los Angeles Education

Partnership 1541 Wilshire Blvd., Suite 200 Los Angeles, CA 90017 T: 213.622.5237

ARCHITECT:

Abode Communities 1149 S. Hill Street, Suite 700 Los Angeles, CA 90015 T: 213.629.2702

CONSULTANTS:

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DSA APPLICATION NUMBER: 03-122151 PROJECT NO: 219-22-001

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STAM



	DATE	REV
PROGRESS SET	02.01.22	
DSA PROGRESS SET	03.02.22	
DSA APPLICATION SET	04.01.22	
DSA BACK-CHECK SET	10.05.22	
DSA BACK-CHECK SET	10.24.22	

SHEET NAME:

ELECTRICAL BUNGALOW 03 FLOOR PLANS


SCALE:


SHEET NUMBER:

**E2.03** 

AS NOTED

DRAWN BY DESIGNED BY CHECKED BY DM
APPROVED BY DM

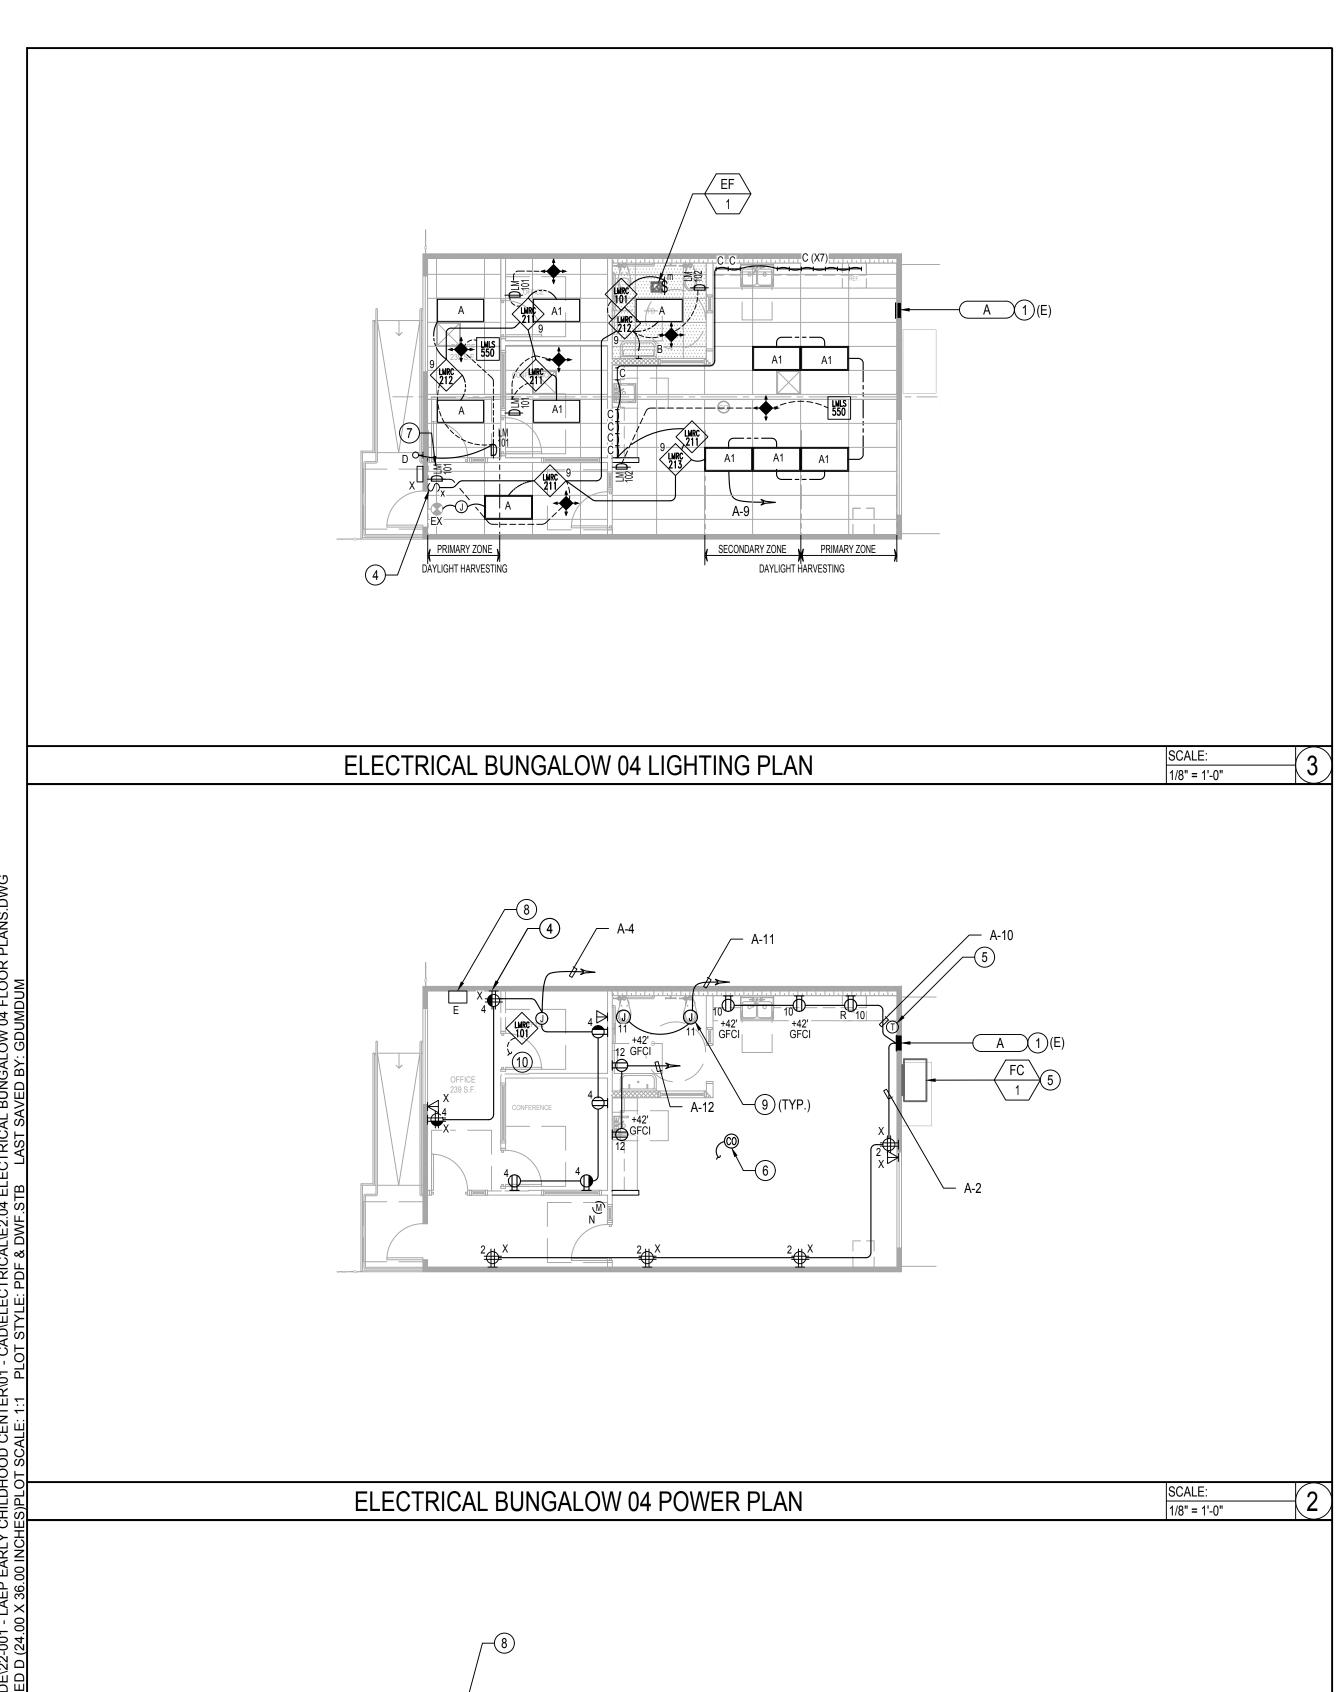

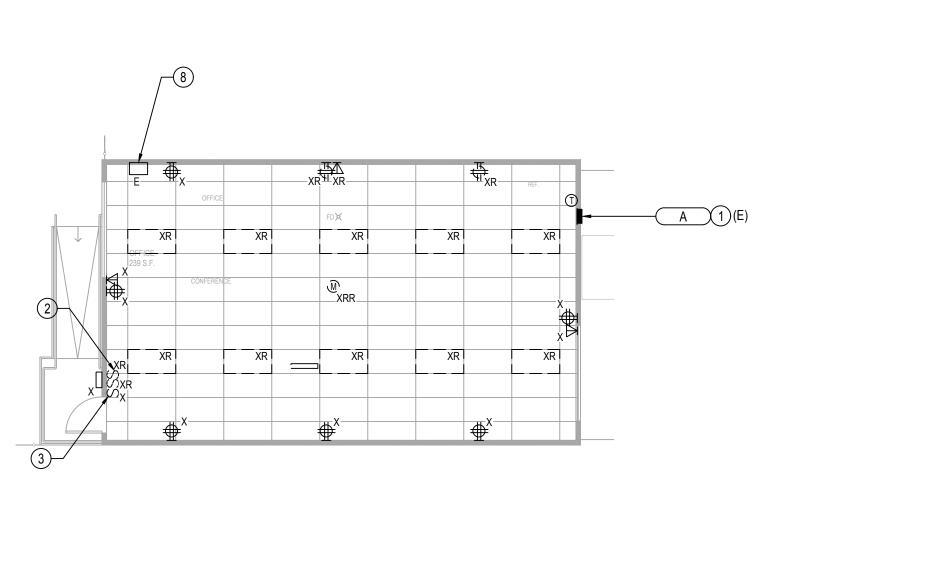

ELECTRICAL BUNGALOW 04 DEMOLITION PLAN

L COPYRIGHT ©2022 BREEN ENGINEERING, INC.

SCALE:

1/8" = 1'-0"

## REFERENCE NOTES

- PRIOR TO START OF WORK (I.E. ELECTRICAL DEMO OR CONSTRUCTION), CONTRACTOR SHALL VERIFY EXISTING PANEL INSTALLATION TO DETERMINE ALL LABOR, TOOLS AND MATERIAL REQUIRED FOR DEMO AND NEW ELECTRICAL WORK AS SHOWN.
- 1. CONFIRM AND VERIFY EXISTING PANEL CIRCUITS TO ENSURE THAT THOSE CIRCUIT UN-AFFECTED BY NEW OR DEMO ELECTRICAL WORK THIS CONTRACT REMAIN IN PLACE AND IN SERVICE. THIS INCLUDING EXISTING CIRCUITRY SERVING THE EXTERIOR LIGHTS, EXISTING HVAC HEAT PUMP UNITS AND MISCELLANEOUS WALL RECEPTACLES.

2. PROVIDE NEW TYPE WRITTEN PANEL CIRCUIT DIRECTORY CARD

- 2 DEMO, DISCONNECT AND REMOVE EXISTING LIGHTS SWITCHES SERVING THE EXISTING LIGHTING.
- 3 EXISTING LIGHT SWITCH WHICH SERVE AND CONTROL THE BUILDING EXTERIOR LIGHT TO REMAIN IN PLACE AND IN SERVICE FOR SCHOOL DISTRICT USE.
- 4 EXISTING WALL ELECTRICAL OUTLET (I.E. DUPLEX RECEPTACLES) AND/OR DEVICE (I.E. SWITCH) TO BE RECONNECTED TO NEW BRANCH CIRCUITRY SHOWN.
- 5 EXISTING HVAC SYSTEM EQUIPMENT AND THERMOSTAT TO REMAIN IN PLACE AND IN SERVICE FOR SCHOOL DISTRICT USE.
- 6 IN THE IMMEDIATE VICINITY OF THE CHILD CARE/NURSERY AREA, PROVIDE U.L. LISTED CEILING MOUNTED 120 VOLT OPERATION (WITH BATTERY BACK-UP PER CBC 420.6) CARBON MONOXIDE ALARM DETECTOR COMPLETE WITH OUTLET BOX, INTERNAL ALARM THAT EMIT A SIGNAL. CONNECT TO UNSWITCHED HOT WIRE OF LOCAL LIGHTING CIRCUIT. VERIFY AND COORDINATE EXACT DETAILS PRIOR TO ROUGH-INS.
- 7 FOR THE EXISTING LIGHT SWITCH AND INSTALLATION OF NEW LOW VOLTAGE LIGHTING CONTROL PROVIDE NEW NEW MULTI-GANG COVERPLATE.
- (8) EXISTING IDF RACK DATA CABINET.
- 9 PROVIDE J-BOX AND CONNECT PER MANUFACTURER'S RECOMMENDATION FOR AUTOMATED FLUSHOMETER URINAL AND ELECTRONIC SENSOR FAUCETS AND WATER CLOSETS. 120V 50VA. CONNECT TO SPARE 120V CIRCUIT ON PANEL B OR P-B FOR THIS BUILDING.
- (10) CONNECT LOW VOLTAGE WIRING TO ROOM CORRESPONDING LV LIGHTING CONTROLLER.

밆	1 PHASE				F	LOCATION (E) PORT. CR 16 BUNGALOW 04				(X = C.R. NUMBER)			<b>(R:</b> 10 MBER)	•	22,000 AIC 100A Bussing	일 일			
	3 <b>WIRE</b>					F	EED	DER SE		E LINE			ENTER CAB'T. AT			. AT	FLUSH MTG.	AKER TY	
ZE E	LOCATION	VOLT AMPS LTG		MIC	CIR	DVD		DVD	CIB	MIC	DEC	LTG	VOLT	AMPS	LOCATION	M. REA	إ		
ш	LOCATION	<b>ф</b> A	<b>ф</b> B	LCL	KEC.	MIS	CIK	DKK		DKK	CIR	MIS	REC	LCL	<b>ф</b> A	<b>ф</b> B	ECCATION	Ш	Ľ
IACR	=(E) HP-1 UNIT	2652		1	_	-	1	60/	+	20/1	2	-	8	-	1440		(E) REC'S	= HACR	ł
IACR	=W/CIR. #1		2652	1	_	_	3	/2	+	20/1	4	-	7	_		1260	(E) REC'S/CLOCK	= HACR	₹
IACR	=(E) HEATER NOT USED OFF (SPARE)	0		-	_	_	5	60/	+	20/1	6	_	-	_	400		(E) IDF RACK CABINET REC'S	= HACR	₹
IACR	=W/CIR. #5		0	-	_	-	7	/2	+	20/1	8	-	_	-		400	(E) IDF RACK CABINET REC'S	□HACR	ł
IACR	=(E) LIGHTS CR/EXT LT'S	456		12	_	ı	9	20/1	+	20/1	10	-	2	1	1500		REFRIG/COUNTER APPL. REC'S	= HACR	₹
IACR	LAV/URINAL/WC SENSOR		200	-	-	2	11	20/1	+	20/1	12	-	4	1		1500	RESTROOM/COUNTER APPL. REC'S	= HACR	₹
IACR	= SPARE	0		ı	_	ı	13	20/1	+	_	14	ı	-	ı	ı		SPACE	= -	
-	= SPACE		-	_	_	_	15	-	++	_	16	-	-			-	SPACE	<u>‡</u>	Į
	- - <b>∳A</b> ∍ 6448 VA				φ B:	601	2 VA	\										<u> </u>	l
	TOTAL CONNECTED LOAD: 124	-60	1	VA	0	R	59.	9 <b>AM</b>	PS • 20	8 VOL	_TS	- 1	ф	PE	R CEC	220.82	2 LOAD CALCULATION	3	ı
	- LCL: 4200 VA x 125% = 5250 VA																	3	L
	F <b>DL:</b> 13510 VA OR 65.0 AMPS																	1	ı
	HACR = HACR TYPE CIRCUIT BREAK	er L	/0 =	PRO\	√IDE I	LOCK	-OFF	DEVICE	ON CIRCUIT	BREAK	ER	AF	CI =	ARC	FAULT	INTERF	RUPTING TYPE CIRCUIT BREAKER	7	ı
	= GFC1 = GROUND FAULT INTERRUPTIN	G TYPE (	CIRCUIT	BRE	EAKER	?						C F	\G =	INTE	RRUPTII	NG TYP	E CIRCUIT BREAKER.	7	ı
	ACR ACR ACR ACR ACR	LOCATION  ACR = (E) HP-1 UNIT  ACR = W/CIR. #1  ACR = (E) HEATER NOT USED OFF (SPARE)  ACR = W/CIR. #5  ACR = (E) LIGHTS CR/EXT LT'S  ACR = LAV/URINAL/WC SENSOR  ACR = SPARE  - SPACE  - SPACE  - A 6448 VA  - TOTAL CONNECTED LOAD: 124  - LCL: 4200 VA x 125% = 5250 VA  - FDL: 13510 VA OR 65.0 AMPS  - HACR = HACR TYPE CIRCUIT BREAK	3 WIRE	Cocation   Volt amps	COCATION   VOLT AMPS   LTG OR	Cocation   Colt   Col	Cocation   Cocation	Cocation   Volt amps   LTG   OR   REC   MIS   CIR	Cocation   Cocation	Sure   Sunge   Sunge	BUNGALOW 04   SEE SINGLE LINE DIAGRAM***   LOCATION   VOLT AMPS   LTG   REC MIS CIR BKR   BKR     ACR = (E) HP-1 UNIT   2652   1 1 60     ACR = W/CIR. #1   2652   1 3 2     ACR = (E) HEATER NOT USED OFF (SPARE)   0   5 60     ACR = W/CIR. #5   0   7 2     ACR = (E) LIGHTS CR/EXT LT'S   456   12 - 9 20/1     ACR = LAV/URINAL/WC SENSOR   200 2 11 20/1     ACR = SPARE   0   13 20/1     ACR = SPARE   0   13 20/1     ACR = SPACE   15 5     E	BUNGALOW 04   SEE SINGLE LINE	SEE SINGLE LINE	BUNGALOW 04   SEE SINGLE LINE   SEE SINGLE LIN	Sure   See Single Line   See	BUNGALOW 04   SEE SINGLE LINE   BKR   CIR MIS REC   LTG OR   CIC   TO A ACR   CE) HP-1 UNIT   2652   1 1   60   20/1   2 - 8   - 1440	See   Single   See   See	Suncalow   O4   See Single Line   See Single L	BUNGALOW 04    SEE SINGLE LINE   BKR   BKR   CIR MIS REC   CR   CR   MIS REC   CR   CR   MIS REC   CR   CR   MIS REC   CR   CR   CR   CR   CR   CR   CR

IDENTIFICATION STAMP DIV. OF THE STATE ARCHITECT

APP: 03-122151 INC:

REVIEWED FOR

SS FLS ACS D

DATE: 11/02/2022

# abode communities architecture

PROJECT:

## LAEP EARLY CHILDHOOD CENTER

13928 KORNBLUM AVE. HAWTHORNE, CA 90250

CLIENT:

Los Angeles Education

Partnership 1541 Wilshire Blvd., Suite 200 Los Angeles, CA 90017 T: 213.622.5237

ARCHITECT:

Abode Communities 1149 S. Hill Street, Suite 700 Los Angeles, CA 90015 T: 213.629.2702

CONSULTANTS:

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PROJECT NO: 219-22-001

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	DATE	REV
PROGRESS SET	02.01.22	
DSA PROGRESS SET	03.02.22	
DSA APPLICATION SET	04.01.22	
DSA BACK-CHECK SET	10.05.22	
DSA BACK-CHECK SET	10.24.22	

SHEET NAME:

ELECTRICAL BUNGALOW 04 FLOOR PLANS

SCALE: AS NOTED

SHEET NUMBER:

**E2.04** 

DRAWN BY DESIGNED BY CHECKED BY DIM
APPROVED BY DIM

Proiect Address:

DOCUMENTATION AUTHOR'S DECLARATION STATEMENT									
	lata								
I certify that this Certificate of Compliance documentation is accurate and comp	· · · · · · · · · · · · · · · · · · ·								
Documentation Author Name:	Documentation Author Signature:								
Desmond Mahony, P.E.									
Company: Breen Engineering Inc.	Signature Date: 2022-04-05								
Address:	CEA/ HERS Certification Identification (if applicable):								
1983 West 190TH Street, Suite 200	E20642								
City/State/Zip:	Phone:								
Torrance CA 90504	(310) 464-8404								
RESPONSIBLE PERSON'S DECLARATION STATEMENT									
I certify the following under penalty of perjury, under the laws of the State of California:									
1. The information provided on this Certificate of Compliance is true and correct.									
2. I am eligible under Division 3 of the Business and Professions Code to accept responsibility for the bu	ilding design or system design identified on this Certificate of Compliance (responsible designer)								
<ol> <li>The energy features and performance specifications, materials, components, and manufactured devi of Title 24, Part 1 and Part 6 of the California Code of Regulations.</li> </ol>	ces for the building design or system design identified on this Certificate of Compliance conform to the requiremen								
<ol> <li>The building design features or system design features identified on this Certificate of Compliance an plans and specifications submitted to the enforcement agency for approval with this building permit</li> </ol>	e consistent with the information provided on other applicable compliance documents, worksheets, calculations, application.								
<ol> <li>I will ensure that a completed signed copy of this Certificate of Compliance shall be made available w inspections. I understand that a completed signed copy of this Certificate of Compliance is required t</li> </ol>	ith the building permit(s) issued for the building, and made available to the enforcement agency for all applicable obe included with the documentation the builder provides to the building owner at occupancy.								
Responsible Designer Name: Desmond Mahony, P.E	Responsible Designer Signature:								
Company:	Date Signed:								
Breen Engineering Inc.	2022-04-05								
Address:	License:								
1983 West 190th Street, Suite 200	E20642								
City/State/Zip:	Phone:								
Torrance CA 90504	(310) 464-8404								

Registration Number: Registration Date/Time: Registration Provider: Energysoft CA Building Energy Efficiency Standards - 2019 Nonresidential Compliance Report Version: 2019.1.003 Schema Version: rev 20200601

#### STATE OF CALIFORNIA **Indoor Lighting**

NRCC-LTI-E			CALIFORNIA ENERGY COMMISSION
CERTIFICATE OF COMPLIANCE			NRCC-LTI-
Project Name:	LAEP EARLY CHILDHOOD CENTER	Report Page:	(Page 4 of 7
Project Address:	13928 KORNBLUM AVE.	Date Prepared:	4/5/2022

I. LIGHTING POWER ALLOWANCE: COMPLETE BUILDING OR AREA CATEGORY METHODS

Each area complying using the Complete Building or Area Category Methods per §140.6(b) are included in this table. Column 06 indicates if additional lighting power allowances per §140.6(c) or adjustments per §140.6(a) are being used

01	02	03	04	05	0	6	
Area Description	Complete Building or Area Category Primary	Allowed Density	Area (ft <sup>2</sup> )	Allowed Wattage	Additional Allowance / Adjustme		
Area Description	Function Area	(W/ft <sup>2</sup> )	Area (IL-)	(Watts)	Area Category	PAF	
CLASSROOM & KITCHEN	Classroom, Lecture, or Training Vocational Area	0.7	713	499.1	No	No	
CLASSROOM & TEACHERS WORK AREA	Classroom, Lecture, or Training Vocational Area	0.7	653	457.1	No	No	
CLASSROOM, CONFERENCE & OFFICE	Classroom, Lecture, or Training Vocational Area	0.7	802	561.4	No	No	
CLASSROOM & OFFICE	Classroom, Lecture, or Training Vocational Area	0.7	722	505.4	No	No	
		TOTALS:	2,890	2,023	See Tables J,	or P for detail	

		TOTALS.	2,030	2,023	See lables 1,	or Front detail	
Unconditioned Spaces							
01	02	03	04	05	0	6	
Area Description	Complete Building or Area Category Primary	Allowed Density	Area (ft²)	Allowed Wattage	Additional Allowance / Adjustment		
Area Description	Function Area	(W/ft <sup>2</sup> )	Area (It )	(Watts)	Area Category	PAF	
CORRIDOR, LAUNDRY & RESTROOM	Classroom, Lecture, or Training Vocational Area	0.7	210	147	No	No	
CORRIDOR, ADULTS RESTROOM & CHILD RESTROOM	Classroom, Lecture, or Training Vocational Area	0.7	210	147	No	No	
CORRIDOR, FILE ROOM, & CHILD RESTROOM	Classroom, Lecture, or Training Vocational Area	0.7	202	141.4	No	No	
CORRIDOR & CHILD RESTROOM	Classroom, Lecture, or Training Vocational Area	0.7	148	103.6	No	No	
		TOTALS:	770	539	See Tables J,	or P for detail	

		-	
J. ADDITIONAL ALLOWANCE: AREA CATEGORY METHOD QUALIFYING LIGHTING SYSTEM	M		
This section does not apply to this project.			
K. TAILORED METHOD GENERAL LIGHTING POWER ALLOWANCE			

This section does not apply to this project. Registration Date/Time:

Registration Provider: Energysoft Registration Number: Report Generated: 2022-04-05 02:12:30 CA Building Energy Efficiency Standards - 2019 Nonresidential Compliance Report Version: 2019.1.003 Report Generated: 2022-04-05 02:12:30 Schema Version: rev 20200601

> STATE OF CALIFORNIA Indoor Lighting

CALIFORNIA ENERGY COMMISSION CERTIFICATE OF COMPLIANCE NRCC-LTI-E Project Name: LAEP EARLY CHILDHOOD CENTER Report Page: (Page 5 of 7 Project Address: 13928 KORNBLUM AVE. Date Prepared: 4/5/2022

L. ADDITIONAL LIGHTING ALLOWANCE: TAILORED WALL DISPLAY This section does not apply to this project M. ADDITIONAL LIGHTING ALLOWANCE: TAILORED FLOOR AND TASK LIGHTING This section does not apply to this project

N. ADDITIONAL LIGHTING ALLOWANCE: TAILORED ORNAMENTAL/SPECIAL EFFECTS This section does not apply to this projec

O. ADDITIONAL LIGHTING ALLOWANCE: TAILORED VERY VALUABLE MERCHANDISE This section does not apply to this project P. POWER ADJUSTMENT: LIGHTING CONTROL CREDIT (POWER ADJUSTMENT FACTOR (PAF)) This section does not apply to this project

Q. RATED POWER REDUCTION COMPLIANCE FOR ALTERATIONS This section does not apply to this project. R. 80% LIGHTING POWER FOR ALL ALTERATIONS - CONTROLS EXCEPTIONS

This section does not apply to this project.

S. DAYLIGHT DESIGN POWER ADJUSTMENT FACTOR (PAF)

This section does not apply to this project.

Registration Number: Registration Date/Time: Registration Provider: Energysoft CA Building Energy Efficiency Standards - 2019 Nonresidential Compliance Report Generated: 2022-04-05 02:12:30 Report Version: 2019.1.003 Schema Version: rev 20200601 STATE OF CALIFORNIA **Indoor Lighting** CALIFORNIA ENERGY COMMISSION CERTIFICATE OF COMPLIANCE NRCC-LTI-Project Name: LAEP EARLY CHILDHOOD CENTER Report Page: (Page 6 of 7) **Project Address:** 13928 KORNBLUM AVE. Date Prepared: 4/5/2022

Selections have been made based on information provided in this document. If any selection have been changed by permit applicant, an explanation should be included in Table E. Additional Remarks. These documents must be provided to the building inspector during construction and can be found online at https://www.energy.ca.gov/title24/2019standards/2019\_compliance\_documents/Nonresidential\_Documents/NRCI/ Field Inspector Form/Title Pass NRCI-LTI-01-E - Must be submitted for all buildings

U. DECLARATION OF REQUIRED CERTIFICATES OF ACCEPTANCE

T. DECLARATION OF REQUIRED CERTIFICATES OF INSTALLATION

Selections have been made based on information provided in this document. If any selection have been changed by the permit applicant, an explanation should be included in Table E. Additional Remarks. These documents must be provided to the building inspector during construction and any with "-A" in the form name must be completed through an Acceptance Test Technician Certification Provider (ATTCP). For more information visit: http://www.energy.ca.gov/title24/attcp/providers.html Systems/Spaces To Be Field | Field Inspector

Form/Title	Systems/Spac	es to be Field	rieid in:	spector
Totally ride	Ver	ified	Pass	Fail
NRCA-LTI-02-A - Must be submitted for occupancy sensors and automatic time switch controls.				
NRCA-LTI-04-A - Must be submitted for demand responsive lighting controls.				
	•			

Registration Number: Registration Date/Time: Registration Provider: Energysoft CA Building Energy Efficiency Standards - 2019 Nonresidential Compliance Report Version: 2019.1.003 Report Generated: 2022-04-05 02:12:30 Schema Version: rev 20200601

STATE OF CALIFORNIA Indoor Lighting

CALIFORNIA ENERGY COMMISSION CERTIFICATE OF COMPLIANCE This document is used to demonstrate compliance with requirements in §110.9, §110.12(c), §130.0, §130.1, §140.6 and §141.0(b)2 for indoor lighting scopes using the prescriptive LAEP EARLY CHILDHOOD CENTER Report Page: (Page 1 of 7) Project Name 4/5/2022 13928 KORNBLUM AVE. Date Prepared: roiect Address

A. GENERAL INFORMATION

HAWTHORNE 04 Total Conditioned Floor Area (ft<sup>2</sup>) 2,890 1 Project Location (city) 05 Total Unconditioned Floor Area (ft<sup>2</sup>) 2 Climate Zone 3 Occupancy Types Within Project (select all that apply): 06 # of Stories (Habitable Above Grade)

B. PROJECT SCOPE

This table includes any lighting systems that are within the scope of the permit application and are demonstrating compliance using the prescriptive path outlined in \$140.6 or

. <u>O(b)2</u> for alterations.							
Scope of Work	Scope of Work Conditioned Spaces		Unconditioned Spaces				
01	02	03	04	05			
My Project Consists of (check all that apply):	Calculation Method	Area (ft²)	Calculation Method	Area (ft²)			
New Lighting System	Area Category Method	2890	Area Category Method	770			
New Lighting System - Parking Garage							
Total Area of Work (ft²)	2890	-	770				

C. COMPLIANCE RESULTS

Unconditioned

Registration Number:

If any cell on this table says "DOES NOT COMPLY" or "COMPLIES with Exceptional Conditions" refer to Table D. for guidance. djusted Lighting Power per §140.6(a) (Watts) Compliance Results 08 09 unconditioned Category Total Adjuste PAF Lighting spaces must not be Category 140.6(c)3 Building Additional Designed Control Credits 05 must be >= 08 combined for Allowed §140.6(c)2 §140.6(c)2G (Watts) §140.6(a)2 compliance per §140.6(b)1 (See Table I) | (See Table I) | (See Table J) | (See Table K Conditioned 2,023 2,023 1,709 1709 COMPLIES 539 539 ≥ 402 402 COMPLIES

Registration Date/Time:

CA Building Energy Efficiency Standards - 2019 Nonresidential Compliance Report Version: 2019.1.003 Report Generated: 2022-04-05 02:12:30 Schema Version: rev 20200601 STATE OF CALIFORNIA **Indoor Lighting** CALIFORNIA ENERGY COMMISSION CERTIFICATE OF COMPLIANCE NRCC-LTI-E LAEP EARLY CHILDHOOD CENTER Report Page: (Page 2 of 7) roject Address: 13928 KORNBLUM AVE. Date Prepared: 4/5/2022

C. COMPLIANCE RESULTS

Controls Compliance (See Table H for Details) COMPLIES D. EXCEPTIONAL CONDITIONS

E. ADDITIONAL REMARKS

No

No

his table is auto-filled with uneditable comments because of selections made or data entered in tables throughout the form.

his table includes remarks made by the permit applicant to the Authority Having Jurisdiction . INDOOR LIGHTING FIXTURE SCHEDULE

his table includes all permanent designed lighting and all portable lighting in offices. Designed Wattage: Conditioned Spaces Field Inspector How is Wattage | Total Number | ame or Iten Watts per Aperture & (Track) Fixture luminaire<sup>2</sup> determined of Luminaires §140.6(a)3 Tag Description Color Change<sup>1</sup> Pass Fail Mfr. Spec 1,023 Mfr. Spec В No No 24 No 24 No No 10 59 590

Total Designed Watts: CONDITIONED SPACES 1,709 Designed Wattage: Unconditioned Spaces 01 02 03 04 05 06 09 Field Inspector Name or Iter Modular Watts per How is Wattage | Total Number | Excluded per Complete Luminaire Aperture & (Track) Fixture determined of Luminaires <u>§140.6(a)3</u> Tag Description luminaire<sup>2</sup> Pass Fail Color Change<sup>1</sup> Mfr. Spec

Registration Date/Time: Registration Provider: Energysoft Registration Number: Report Generated: 2022-04-05 02:12:30 CA Building Energy Efficiency Standards - 2019 Nonresidential Compliance Report Version: 2019.1.003 Schema Version: rev 20200601 STATE OF CALIFORNIA

Mfr. Spec

No

66

**Indoor Lighting** 

CALIFORNIA ENERGY COMMISSION CERTIFICATE OF COMPLIANCE LAEP EARLY CHILDHOOD CENTER Report Page: (Page 3 of 7) **Project Name:** 13928 KORNBLUM AVE. Date Prepared: 4/5/2022 Project Address: . INDOOR LIGHTING FIXTURE SCHEDULE

No No 24 Mfr. Spec 5 No Total Designed Watts: UNCONDITIONED SPACES 402 FOOTNOTE: Design Watts for small aperture and color changing luminaires which qualify per §140.6(a)4B is adjusted to be 75% of their rated wattage. Table F automatically makes this adjustment, the permit applicant should enter full rated wattage in column 05.

<sup>2</sup>Authority Having Jurisdiction may ask for Luminaire cut sheets to confirm wattage used for compliance per §130.0(c) Wattage used must be the maximum rated for the luminaire, not

G. MODULAR LIGHTING SYSTEMS

A1

This section does not apply to this project.

H. INDOOR LIGHTING CONTROLS (Not including PAFs)

This table includes lighting controls for conditioned and unconditioned spaces. When a control having a \* is shown, the notes section of this table provides more detail on how compliance is achieved. The lighting controls section of the Compliance Summary Table on the first page will show "DOES NOT COMPLY" if the notes are left blank.

**Building Level Controls** Mandatory Demand Response §110.12(c) Shut-off controls §130.1(c) Required > 10,000 SF Whole Building Auto Time Switch

Area Level Controls 06 Complete Building or Area Area Controls Shut-Off Controls Field Inspector Controls Area Description Category Primary Function Daylighting Systems §130.1(a) §130.1(c) Daylighting §130.1(b) Pass Fail \*NOTES: Controls with a \* require a note in the space below explaining how compliance is achieved. EX: Conference 1: Primary/Skylight Daylighting: Exempt because less than 120 watts of general lighting; EXCEPTION 1 Plan Sheet Showing Daylit Zones: to <u>§130.1(d)2</u>

Registration Number:

CA Building Energy Efficiency Standards - 2019 Nonresidential Compliance

Registration Date/Time: Report Version: 2019.1.003 Schema Version: rev 20200601

Registration Provider: Energysoft DRAWN BY EVK DESIGNED BY CHECKED BY APPROVED BY

IDENTIFICATION STAMP DIV. OF THE STATE ARCHITEC APP: 03-122151 INC: REVIEWED FOR SS 🗹 FLS 🗹 ACS 🗹 DATE: 11/02/2022

## abode communities

## LAEP EARLY **CHILDHOOD CENTER**

13928 KORNBLUM AVE. **HAWTHORNE, CA 90250** 

CLIENT:

Los Angeles Education Partnership 1541 Wilshire Blvd., Suite 200 Los Angeles, CA 90017

ARCHITECT:

T: 213.622.5237

Registration Provider: Energysoft

Field Inspector

**Abode Communities** 1149 S. Hill Street, Suite 700 Los Angeles, CA 90015 T: 213.629.2702

CONSULTANTS:

**Breen Engineering** 1983 W. 190th St., Suite 200 Torrance, CA 90504 T: 310.464.8404

MECHANICAL/ **ELECTRICAL/ PLUMBING Breen Engineering** 1983 W. 190th St., Suite 200 Torrance, CA 90504 T: 310.464.8404

STRUCTURAL **Breen Engineering** 1983 W. 190th St., Suite 200 Torrance, CA 90504 T: 310.464.8404



1983 WEST 190TH STREET, SUITE 200 TORRANCE, CA 90504 **TEL:** (310) 464-8404 **FAX:** (310) 464-8408 WWW.BREENENG.COM DSA APPLICATION NUMBER: 03-122151

PROJECT NO: 219-22-001 The ideas and designs represented herein and this drawing, all prepared by Abode Communities are for the use solely with respect to this project and Abode Communities shall retain all common law, statutory and other reserved rights including copyright, and they shall not be used by others for any other purpose without written permission of

Abode Communities | Architecture.

STAMP:



DATE REV 02.01.22 PROGRESS SET DSA PROGRESS SET 03.02.22 DSA APPLICATION SET 04.01.22 DSA BACK-CHECK SET 10.05.22 DSA BACK-CHECK SET 10.24.22

SHEET NAME:

TITLE 24 COMPLIANCE FORMS -SHEET ONE

SHEET NUMBER:

- men e e i algumana			
NRCC-LTO-E			CALIFORNIA ENERGY COMMISSION
CERTIFICATE OF COMPLIANCE			NRCC-LTO-E
Project Name:	LAEP EARLY CHILDHOOD CENTER	Report Page:	(Page 7 of 7)
Project Address:	13928 KORNBLUM AVE.	Date Prepared:	4/5/2022

DOCUMENTATION AUTHOR'S DECLARATION STATEMENT	
I certify that this Certificate of Compliance documentation is accurate and comple	ete.
Documentation Author Name: Desmond Mahony, P.E.	Documentation Author Signature:
Company: Breen Engineering Inc.	Signature Date: 2022-04-05
Address: 1983 West 190TH Street, Suite 200	CEA/ HERS Certification Identification (if applicable): E20642
City/State/Zip: Torrance CA 90504	Phone: (310) 464-8404
of Title 24, Part 1 and Part 6 of the California Code of Regulations.  4. The building design features or system design features identified on this Certificate of Compliance are plans and specifications submitted to the enforcement agency for approval with this building permit a	es for the building design or system design identified on this Certificate of Compliance conform to the requirements consistent with the information provided on other applicable compliance documents, worksheets, calculations, pplication.
Responsible Designer Name: Desmond Mahony, P.E	Responsible Designer Signature:
Company: Breen Engineering Inc.	Date Signed: 2022-04-05
Address: 1983 West 190th Street, Suite 200	License: E20642
City/State/7in:	Phone:

STATE OF CALIFORNIA

**Outdoor Lighting** CALIFORNIA ENERGY COMMISSION CERTIFICATE OF COMPLIANCE NRCC-LTO-E LAEP EARLY CHILDHOOD CENTER Report Page: (Page 4 of 7) Project Address 13928 KORNBLUM AVE. Date Prepared: 4/5/2022

H. OUTDOOR LIGHTING CONTROLS

This table demonstrates compliance with controls requirements for all new or altered luminaires installed as part of the permit application. For alteration projects, luminaires which are existing to remain (ie untouched) and luminaires which are removed and reinstalled (wiring only) do not need to be included in this table even if they are within the spaces covered by When an option having a \* is selected, the notes section of this table must be completed. The lighting controls section of the Compliance Summary Table on the first page will show "DOES NOT COMPLY" if the notes are left blank.

andatory Controls					
01	02	03	04	0	5
Area Description	Shut-Off §130.2(c)1	Auto-Schedule §130.2(c)2	Motion Sensor §130.2(c)3	Field In:	spector
			<u> </u>	Pass	Fail
IOTES: Controls with a * require a note in the spo	ace below explaining how compliance is a	chieved.			
Not permitted by health & safety to be turned of	off; EXCEPTION 1 to §130.2(c)				

STATE OF CALIFORNIA **Outdoor Lighting** 

CERTIFICATE OF COMPLIANCE NRCC-LTO-E LAEP EARLY CHILDHOOD CENTER Report Page: (Page 1 of 7) roiect Name: 13928 KORNBLUM AVE. Date Prepared: 4/5/2022 roiect Address A. GENERAL INFORMATION 01 Project Location (city) **IHAWTHORNE** 04 Total Illuminated Hardscape Area (ft<sup>2</sup>) 228 02 Climate Zone 03 Outdoor Lighting Zone per Title 24 Part 1 §10.114 or as designated by Authority Having Jurisdiction (AHJ): ☐ LZ-0: Very Low - Undeveloped Parkland ☐ LZ-2: Moderate - Rural Areas ☐ LZ-4: High - Must be reviewed by CA Energy Commission for Approval ☐ LZ-1: Low - Developed Parkland □ LZ-3: Moderately High - Urban Areas

B. PROJECT SCOPE This table includes outdoor lighting systems that are within the scope of the permit application and are demonstrating compliance using the prescriptive path outlined in §140.7 or 141.0(b)2L for alterations My Project Consists of: Must Comply with Allowances from §140.7 ☐ Altered Lighting System Is your alteration increasing the connected lighting load (Watts)? Yes 🔵 Sum Total of Luminaires Being Added or Altered Calculation Method % of Existing Luminaires Being Altered<sup>1</sup> □ < 10% □ >= 10% and < 50% □ >= 50%

Please proceed to Table F. Outdoor Lighting Fixture Schedule to define the project's luminaires. <sup>1</sup> FOOTNOTES: % of Existing Luminaires Being Altered = (Sum Total of Luminaires Being Added or Altered / Existing Luminaires within the Scope of the Permit Application) x 100.

Registration Number:

Torrance CA 90504

CA Building Energy Efficiency Standards - 2019 Nonresidential Compliance

Registration Date/Time: Report Version: 2019.1.003

Schema Version: rev 20200601

(310) 464-8404

Registration Provider: Energysoft

Registration Number:

STATE OF CALIFORNIA

Proiect Name:

Project Address:

**Outdoor Lighting** 

it or lose it" allowance.

CERTIFICATE OF COMPLIANCE

I. LIGHTING POWER ALLOWANCE (per §140.7)

Area Description

BUNGLALOW 01 ENTRANCE

**BUNGLALOW 02 ENTRANCE** 

J. LIGHTING ALLOWANCE: PER APPLICATION

This section does not apply to this project.

Registration Number:

BUNGLALOW 03 FNTRANCE

Report Generated: 2022-04-05 02:12:30 CA Building Energy Efficiency Standards - 2019 Nonresidential Compliance

This table includes areas using allowance calculations per <u>§140.7</u>. General Hardscape

Allowance is per Table 140.7-A while "Use it or lose it" Allowances are per Table 140.7-B .

Indicate which allowances are being used to expand sections for user input. Luminaires

that qualify for one of the "Use it or lose it" allowances shall not qualify for another "Use

Calculated General Hardscape Lighting Power Allowance per Table 140.7-A (LZ 0, 1 & 4)

Calculated General Hardscape Lighting Power Allowance per Table 140.7-A (LZ 2 & 3)

Surface Type

Asphalt

Registration Date/Time: Report Version: 2019.1.003

Schema Version: rev 20200601

☑ General

Hardscape

Allowance

Table I (below)

06

(Watts)

1.4

05

Area Wattage Allowance (AWA)

Density (W/ft<sup>2</sup>)

0.025

0.025

0.025

Application

Table J

LAEP EARLY CHILDHOOD CENTER Report Page:

04

Area (ft<sup>2</sup>)

13928 KORNBLUM AVE. Date Prepared:

Registration Provider: Energysoft Report Generated: 2022-04-05 02:12:30

NRCC-LTO-E

(Page 5 of 7)

Table M

Total General

AWA + LWA

(Watts)

10

Allowance

(Watts)

8.8

8.8

§140.7(d)1

Registration Number:

STATE OF CALIFORNIA

NRCC-LTO-E

Project Name

Project Address

**Outdoor Lighting** 

CERTIFICATE OF COMPLIANCE

4/5/2022

CALIFORNIA ENERGY COMMISSION

"Use it or lose it" Allowance (select all that apply) (select all that apply)

Table K

07 | 08

Perimeter

Length (If)

Area Wattage Allowance (AWA)

Density (W/lf)

0.2

0.2

Initial Wattage Allowance for Entire Site (Watts):

Total General Hardscape Allowance (Watts):

Registration Number: CA Building Energy Efficiency Standards - 2019 Nonresidential Compliance Registration Date/Time: Report Version: 2019.1.003

Schema Version: rev 20200601

141.0(b)2L

Registration Provider: Energysoft Report Generated: 2022-04-05 02:12:30

Registration Provider: Energysoft

Report Generated: 2022-04-05 02:12:30

CALIFORNIA ENERGY COMMISSION

NRCC-LTO-E

(Page 3 of 7)

4/5/2022

CALIFORNIA ENERGY COMMISSION

ARCHITECT:

CLIENT:

Partnership

**Abode Communities** 1149 S. Hill Street, Suite 700 Los Angeles, CA 90015 T: 213.629.2702

Los Angeles, CA 90017 T: 213.622.5237

**IDENTIFICATION STAMP** 

DIV. OF THE STATE ARCHITEC

REVIEWED FOR SS 🗹 FLS 🗹 ACS 🗹

APP: 03-122151 INC:

DATE: 11/02/2022

abode

LAEP EARLY

13928 KORNBLUM AVE.

HAWTHORNE, CA 90250

Los Angeles Education

1541 Wilshire Blvd., Suite 200

communities

**CHILDHOOD CENTER** 

CONSULTANTS:

**Breen Engineering** 1983 W. 190th St., Suite 200 Torrance, CA 90504 T: 310.464.8404

MECHANICAL/ **ELECTRICAL/ PLUMBING Breen Engineering** 1983 W. 190th St., Suite 200 Torrance, CA 90504 T: 310.464.8404

STRUCTURAL **Breen Engineering** 1983 W. 190th St., Suite 200 Torrance, CA 90504 T: 310.464.8404



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any other purpose without written permission of

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DATE REV PROGRESS SET 02.01.22 DSA PROGRESS SET 03.02.22 DSA APPLICATION SET 04.01.22 DSA BACK-CHECK SET 10.05.22 DSA BACK-CHECK SET 10.24.22

SHEET NAME:

TITLE 24 COMPLIANCE FORMS -SHEET TWO

SHEET NUMBER:

K. LIGHTING ALLOWANCE: SALES FRONTAGE This section does not apply to this project. L. LIGHTING ALLOWANCE: ORNAMENTAL This section does not apply to this project. Registration Number: Registration Date/Time: Registration Provider: Energysoft CA Building Energy Efficiency Standards - 2019 Nonresidential Compliance Report Version: 2019.1.003 Report Generated: 2022-04-05 02:12:30 CA Building Energy Efficiency Standards - 2019 Nonresidential Compliance Schema Version: rev 20200601 STATE OF CALIFORNIA **Outdoor Lighting** CALIFORNIA ENERGY COMMISSION NRCC-ITO-F CERTIFICATE OF COMPLIANCE NRCC-LTO-E LAEP EARLY CHILDHOOD CENTER Report Page: (Page 6 of 7) Project Name: 13928 KORNBLUM AVE. Date Prepared: 4/5/2022 Project Address: M. LIGHTING ALLOWANCE: PER SPECIFIC AREA This section does not apply to this project. N. EXISTING CONDITIONS POWER ALLOWANCE (alterations only) This section does not apply to this project. O. DECLARATION OF REQUIRED CERTIFICATES OF INSTALLATION Selections have been made based on information provided in this document. If any selection have been changed by permit applicant, an explanation should be included in Table E. dditional Remarks. These documents must be provided to the building inspector during construction and can be found online at https://www.energy.ca.gov/title24/2019standards/2019\_compliance\_documents/Nonresidential\_Documents/NRCI/ Field Inspector Form/Title Pass NRCI-LTO-01-E - Must be submitted for all buildings P. DECLARATION OF REQUIRED CERTIFICATES OF ACCEPTANCE There are no NRCA forms required for this project.

STATE OF CALIFORNIA **Outdoor Lighting** CALIFORNIA ENERGY COMMISSION NRCC-LTO-E CERTIFICATE OF COMPLIANCE NRCC-LTO-E (Page 2 of 7) Project Name: LAEP EARLY CHILDHOOD CENTER Report Page: 13928 KORNBLUM AVE. Date Prepared: 4/5/2022 Project Address: C. COMPLIANCE RESULTS Results in this table are automatically calculated from data input and calculations in Tables F through I. Note: If any cell on this table says "COMPLIES with Exceptional Conditions" refer Table D. Exceptional Conditions for guidance or see applicable Table referenced below. Calculations of Total Allowed Lighting Power (Watts) §140.7 or §141.0(b)21 **Compliance Results** 80 General Existing Per Specific Hardscape **Total Allowed** Application Frontage Area Total Actual Allowance §140.7(d)2 Allowance 07 must be >= 08 §140.7(d)2 §140.7(d)2 §140.7(d)2 (Watts)

(See Table L)

This table includes remarks made by the permit applicant to the Authority Having Jurisdiction.

(See Table J) (See Table K) (See Table M) (See Table I) (See Table N) 80 COMPLIES Cutoff Compliance (See Table G for Detail Controls Compliance (See Table H for Details COMPLIES his table is auto-filled with uneditable comments because of selections made or data entered in tables throughout the form. E. ADDITIONAL KEMIAKKS

F. OUTDOOR LIGHTING FIXTURE SCHEDULE For new or altered lighting systems demonstrating compliance with §140.7 all new luminaires being installed and any existing luminaires remaining or being moved within the spaces overed by the permit application are included in the Table below. For altered lighting systems using the Existing Power method per <u>§141.0(b)2L</u> only new luminaires being installed and

placement luminaires being installed as part of the project scope are included (ie, existing luminaires remaining or existing luminaires being moved are not included). Designed Wattage: 01 Cutoff Req. > How is 6,200 initial Watts per lame or Ite Inspector Complete Luminaire Description Wattage luminaire1, 2 Status<sup>3</sup> §140.7(a) lumen output 🗕 luminaires <sup>2</sup> determined §130.2(b) 4 Pass Fail NA: < 6200 Mfr. Spec 80 lumens Total Design Watts: 80 NOTES: Selections with a \* require a note in the space below explaining how compliance is achieved.

LAEP EARLY CHILDHOOD CENTER Report Page:

13928 KORNBLUM AVE. Date Prepared:

Registration Date/Time:

Report Version: 2019.1.003

Schema Version: rev 20200601

K: Luminaire is lighting a statue; EXCEPTION 2 to §130.2(b)

 $^1$ FOOTNOTES: Authority Having Jurisdiction may ask for Luminaire cut sheets to confirm wattage used for compliance per  $\frac{§130.0(c)}{}$ <sup>2</sup> For linear luminaires, wattage should be indicated as W/lf instead of Watts/luminaire. Total linear feet should be indicated in column 05 instead of number of luminaires. <sup>3</sup> Select "New" for new luminaires in a new outdoor lighting project, or for added luminaires in an alteration. Select "Altered" for replacement luminaires in an alteration. Select "Existing to Remain" for existing luminaires within the project scope that are not being altered and are remaining. Select "Existing Reinstalled" for existing luminaires which are being removed and reinstalled as part of

the project scope. <sup>4</sup> Compliance with mandatory cutoff requirements is required for luminaires with initial lumen output >= 6,200 unless exempted by \$130.2(b)

G. CUTOFF REQUIREMENTS (BUG)

This section does not apply to this project.

Registration Date/Time: CA Building Energy Efficiency Standards - 2019 Nonresidential Compliance Report Version: 2019.1.003

Schema Version: rev 20200601

Registration Provider: Energysoft

Report Generated: 2022-04-05 02:12:30 CA Building Energy Efficiency Standards - 2019 Nonresidential Compliance

Report Version: 2019.1.003 Schema Version: rev 20200601

DRAWN BY Registration Date/Time: DESIGNED BY CVK CHECKE DeByt General 1914 2022-04-05 02:12:30 APPROVED BY

	FIRE ALARM SCHEDULE								
SYMBOL MANUFACTURER MODEL		DESCRIPTION CFM		ВАСКВОХ	MOUNTING HEIGHT				
FACP	SILENT KNIGHT	6820	FIRE ALARM CONTROL PANEL	7165-0559:0500	25"H x 14.75"W x 4"D	TOP OF BOX BELOW 6'3"			
ANN	SILENT KNIGHT	5860	REMOTE ANNUNCIATOR	7165-0559:135	6.625"H x 8.25"W x 1.375"D	52" A.F.F. TO CENTER			
FCPS	SILENT KNIGHT	5895XL	ZONE EXPANDER/POWER SUPPLY	7165-0559:135	26"H x 16"W x 4.65"D	TOP OF BOX BELOW 6'3"			
H	WHEELOCK	MT-12/24-R	HORN, WEATHERPROOF	7135-0785:0118	IOB	80" A.F.F. TO BOTTOM			
15	WHEELOCK	RSSWP-2475	STROBE, 15CD	7300-0785:0154	4S w/RING	80" A.F.F. TO BOTTOM OF LENS			
75	WHEELOCK	RSSWP-2475	STROBE, 75CD	7300-0785:0154	4S w/RING	80" A.F.F. TO BOTTOM OF LENS			
•	SILENT KNIGHT	SD505-APS	NEW SMOKE DETECTOR (w/ BASE: SD505-6(4)AB)	7272-0559:129	4S w/PLASTER RING	ON CEILING			
HD	SILENT KNIGHT	SD505-AHS	NEW HEAT DETECTOR (w/ BASE: SD505-6(4)AB)	7270-0559:127	4S w/PLASTER RING	ON CEILING			
F	SILENT KNIGHT	PS-SATK-WP	PULL STATION (w/ MODULE: SD505-MIM)	7270-0559:121	PS- WPB	48" A.F.F. TO CENTER			

		<b>WIRING SCHEDULE</b>	
DESIG.	CIRCUIT TYPE	DESCRIPTION	MODEL
M	MAPNET ADDRESSABLE	4 TWISTED PAIR, 18 AWG FPLR	HONEYWELL CABLE 18/8 SOL FPL #4309, CSFM #7161-1487:0100
FA	SLC INTELLIGENT LOOP NETWORK COMM	1 TWISTED PAIR, 18 AWG FPLR (FA2 = 2 SET OF CABLES)	HONEYWELL CABLE 18/2 SOL FPL #4106, CSFM #7161-1487:0100
1A	VOICE EVAC SPEAKER OUTPUT SIGNAL CIRCUIT CABLE	2#16 AWG (RED/BLACK)	HONEYWELL CABLE #4311, CSFM #7161-1487:0100
1V	STROBE SIGNAL OUTPUT CIRCUIT CABLE	2#14 AWG (RED/BLACK)	HONEYWELL CABLE #4111 CSFM #7161-1487:0100 OR #12 THWN CU.
1A/1V	1A & 1V CABLE	MIN. 3/4" CONDUIT SYSTEM WITH BOTH VOICE EVAC SPEAKER OUTPUT SIGNAL CIRCUIT CABLE AND STROBE SIGNAL OUTPUT CIRCUIT CABLE	REFER TO 1A AND 1V ABOVE FOR CABLE TYPE
2A/2V	(2) SET OF 1A & 1V CABLES	1" CONDUIT SYSTEM WITH (2) SET BOTH VOICE EVAC SPEAKER OUTPUT SIGNAL CIRCUITS CABLES AND STROBE SIGNAL OUTPUT CIRCUITS CABLES OR LOOP	REFER TO 1A AND 1V ABOVE FOR CABLE TYPE
6 STRAND F.O.	6 STRAND FIBER OPTIC	6 STRAND FIBER OPTIC FIRE ALARM CABLES	

1. ALL CABLE SHALL BE INSTALLED PER NEC/CEC PA VOICE CIRCUIT.

2. ALL WIRING SHALL CONFORM TO NEC 760 PART A & C FOR A POWER-LIMITED SUPPLY.

3. ALL WIRING IN WET LOCATIONS SHALL BE THWN, UL LISTED FOR OUTDOOR USE OR EQUAL. 4. ALL FIRE ALARM CABLING SHALL BE RUN IN MINIMUM 3/4" CONDUIT RACEWAY UNLESS OTHERWISE NOTED.

CODES AND PERMITS: ALL EQUIPMENT, INSTALLATION, ETC., SHALL CONFORM TO LOCAL ELECTRICAL, MECHANICAL AND OTHER APPLICABLE CODES. CONTRACTOR SHALL OBTAIN AND PAY FOR ALL PERMITS. COPIES OF ALL PERMITS AND INSPECTION REPORTS SHALL BE SUBMITTED TO THE ARCHITECT. CODES INCLUDE BUT NOT LIMITED TO:

**CODES AND STANDARDS** 

TITLE 24, PART 2, CCR (2019 CALIFORNIA BUILDING CODE W/AMENDMENTS) TITLE 24. PART 3. CCR (2019 CALIFORNIA ELECTRICAL CODE W/AMENDMENTS) TITLE 24, PART 4, CCR (2019 CALIFORNIA MECHANICAL CODE W/AMENDMENTS)

TITLE 24, PART 5, CCR (2019 CALIFORNIA PLUMBING CODE W/AMENDMENTS) TITLE 24. PART 9. CCR (2019 CALIFORNIA FIRE CODE W/AMENDMENTS) 2019 CALIFORNIA GREEN BUILDINGS STANDARDS CODES)

2019 CALIFORNIA REFERENCED STANDARDS CODE (PART 12, TITLE 24, CCR) NFPA 13 - 2016 NFPA 72 - 2016

REFERENCED CODE SECTIONS FOR APPLICABLE STANDARDS 2019 CBC, CHAPTER 35 2019 CFC, CHAPTER 80

NFPA STANDARDS AND GUIDES NFPA 72 NATIONAL FIRE ALARM CODES (CALIFORNIA AMENDED, 2016 EDITION) NOTE: SEE UL STANDARD 1971 FOR "VISUAL DEVICES".

REFERENCE CODE SECTION FOR NFPA STANDARDS-2019 CBC (SFM) CHAPTER 35. SEE CHAPTER 35 FOR STATE OF CALIFORNIA AMENDMENTS TO NFPA STANDARDS.

UPON RECEIPT OF THE CERTIFICATE OF COMPLIANCE, THE INSTALLER SHALL SUPPLY THE OWNER WITH A WRITTEN OPERATION, TESTING AND MAINTENANCE INSTRUCTIONS, POINT TO POINT AS BUILD DRAWINGS AND EQUIPMENT SPECIFICATIONS.

NFPA 72 CHAPTER 10,14 INSPECTION TESTING AND MAINTENANCE COMPLETE THE INSPECTION AND TESTING FORM IN ITS ENTIRETY SUBMIT A COPY TO THE DISTRICT, ARCHITECT AND DSA DIVISION OF FIRE AND LIFE SAFETY.

RECORD DRAWINGS OF ALL INSPECTION, TEST SHALL BE MAINTAINED ON PREMISES MINIMUM THREE YEARS. CFC 901 6. 2 (5 YEARS PER TITLE 14) SMOKE DETECTORS TO UTILIZE CALIBRATED MANUFACTURE SENSITIVITY TEST INSTRUMENT. CFC 907. 9.4

## FIRE ALARM SPECIFICATIONS

- THE FIRE ALARM SYSTEM SHALL COMPRISE AUTOMATIC ADDRESSABLE MANUAL PULLS, SMOKE/HEAT DETECTION SYSTEM AND CONFORM TO ARTICLE 760 OF THE 2019 CALIFORNIA ELECTRICAL CODE.
- UPON COMPLETION OF THE INSTALLATION OF THE FIRE ALARM SYSTEM, A SATISFACTORY TEST OF THE ENTIRE SYSTEM SHALL BE MADE PRIOR TO AND IN THE PRESENCE OF THE FIRE MARSHALL OR ENFORCING AGENCY.
- A STAMPED SET OF APPROVED FIRE ALARM PLANS SHALL BE ON THE JOB SITE. AND USED FOR INSTALLATION. ANY DEVIATION FOR THE APPROVED PLANS, INCLUDING THE SUBSTITUTION OF DEVICES, SHALL BE APPROVED BY THE FIRE MARSHALL OR ENFORCING AGENCY.
- FIRE ALARM DRAWINGS ARE SCHEMATIC IN NATURE ONLY. CONTRACTOR SHALL ROUTE CONDUIT RACEWAY AS FIELD CONDITION PERMIT OR AS INDICATED ON PLANS. ANY DISCREPANCIES BETWEEN THE DRAWINGS AND CODE OR RECOGNIZED
- STANDARDS, SHALL BE BROUGHT TO THE ATTENTION OF THE INSPECTOR OF RECORD.
- ALL DEVICES OF THE FIRE ALARM SYSTEMS SHALL BE APPROVED AND LISTED BY THE CALIFORNIA STATE FIRE MARSHALL. A CERTIFICATE OF COMPLETION SHALL BE PREPARED BY THE INSTALLER AND GIVEN TO THE FIRE MARSHALL UPON
- COMPLETION OF THE INSTALLATION. CONSULT INSTALLER PRIOR TO MAKING ANY MODIFICATIONS TO THE SYSTEMS WIRING.
- UPON COMPLETION OF THE INSTALLATION. THE INSTALLER SHALL SUPPLY THE OWNER WITH WRITTEN OPERATING, TESTING AND MAINTENANCE INSTRUCTIONS, POINT-TO-POINT AS-BUILT DRAWINGS AND EQUIPMENT SPECIFICATIONS.
- A. THE SYSTEM SHALL BE TESTED IN THE PRESENCE OF AND IN A MANNER ACCEPTABLE TO THE ENFORCING AGENCY AND A COMPLETE TESTING AND INSPECTION FORM SHALL BE PROVIDED FOR LOCAL FIRE AND/OR DSA INSPECTOR SIGNATURE.
- 120 VAC, 60HZ INPUT POWER FOR THE FIRE ALARM CONTROLS SHALL BE A DEDICATED CIRCUIT BREAKER PROPERLY LABELED
- 10. 120 VAC IS NOT PERMITTED IN THE SAME CONDUIT WITH LOW VOLTAGE WIRING.
- 11. THE LOCATION OF THE FIRE ALARM CONTROL PANEL SHALL BE APPROVED BY THE FIRE MARSHALL OR ENFORCING AGENCY.
- 12. ALL OPENINGS IN RATED ASSEMBLIES SHALL BE REPAIRED PER UFC, NEC, UBC AND STANDARD BUILDING CODES ON EFFECT AT THE TIME OF APPROVAL. THE SYSTEM SHALL CONFORM TITLES 19 AND 24 AS APPLICABLE TO THIS PROJECT (CBC PART 2,
- REQUIRED AND PER CEC CODES. 14. ALL PANELS SHALL BE MOUNTED WITH CLEARANCES FOR OBSERVATION AND TESTING, AND ALL FIRE ALARM JUNCTION BOXES

13. ALL BACK BOXES SHALL BE AS RECOMMENDED BY MANUFACTURER. CONTRACTOR SHALL LOCATE JUNCTION BOXES AS

- SHALL BE MARKED FOR IDENTIFICATION.
- 15. ALL WIRING OF INITIATING DEVICES SHALL BE SUPERVISED TO THE PRINCIPLE POINT OF ANNUNCIATION (THE FIRE ALARM CONTROL PANEL IS TO SUPERVISE ALL OF THE CIRCUITS AND INITIATING DEVICES).
- 16. WIRING SHALL NOT BE LOOPED THROUGH DEVICES; WIRE MUST BE CUT FOR IN AND OUT. POINT COMMON ANNUNCIATION AND T-TAPPING ARE PROHIBITED.
- A. EXCEPTION: ADDRESSABLE SYSTEMS, MAPNET CONDUCTORS WIRED CLASS "B" MAY BE T-TAPPED.
- 17. ALL FIRE ALARM WIRING SHALL BE RUN IN MINIMUM  $^3\!\!4$ " CONDUIT.
- A. ALL CONDUIT SIZES SHOWN AND INDICATED ON DRAWING ARE MINIMUMS. CONTRACTOR TO ADJUST SIZES FOR FIELD CONDITIONS (I.E. NUMBER OF BENDS, ETC.) BUT SHALL NOT BE SMALLER THAN 3/4".
- 18. ALL FIRE ALARM SYSTEM WIRING TERMINATIONS IN MAIN PULL BOXES AND TERMINAL CABINETS SHALL BE ON BOX MOUNTED TERMINAL BLOCKS.
- 19. ALL FIRE ALARM WIRING MUST TEST FREE OF OPENS, SHORTS AND GROUNDS. SEE INSTALLATION MANUALS FOR FIELD WIRING SPECIFICATIONS FOR ADDITIONAL INSTALLATION REQUIREMENTS.
- 20. (2) PRIMARY PHONE LINE SHALL BE DEDICATED FOR THE FIRE ALARM SYSTEM TO COMMUNICATE WITH U.L. LISTED CENTRAL
- 21. WIRING COLOR CODE SHALL BE CONSISTENT THROUGHOUT THE SYSTEM AND SHALL ALLOW FOR EASY IDENTIFICATION OF
- INITIATING, INDICATING AND AUXILIARY CIRCUITS. 22. CABINET TERMINALS SHALL BE NUMBERED AND CODED. FLEXIBLE CONNECTORS SHALL BE USED FOR DEVICES MOUNTED IN
- 23. THE FIRE DEPARTMENT WILL TEST AND VERIFY ADEQUATE AUDIBILITY BEING PROVIDED THROUGHOUT, PARTICULARLY IN OPEN WORK AREAS AND IN TESTING AREAS.
- A. AUDIBLE DEVICES(S) TO BE AT LEASE 15 DBA ABOVE THE AMBIENT SOUND LEVELS, BUT NOT LESS THAN THE 75 DBA AT 10' OR MORE THAN 110DBA AT THE MINIMUM HEARING DISTANCE. AUDIBLE DEVICES SHALL SOUND THE TEMPORAL FIRE
- 24. CONDUIT AND JUNCTION BACK BOXES ARE NOT TO BE USED FOR UNRELATED WIRING.
- ALL CONDUIT MOUNTING BOXES, AND PANELS SHALL BE HUNG AND FASTENED WITH FITTINGS TO ENSURE POSITIVE GROUNDING THROUGHOUT THE ENTIRE SYSTEM.
- 26. PLACE THE BOTTOM OF THE WALL MOUNTED STROBE EXACTLY 80" ABOVE THE FLOOR TO BOTTOM OF LENS AND MAKE SURE THE TOP OF THE STROBE IS AT LEAST 6" BELOW THE CEILING. PLACE THE TOP OF THE STROBE 6" BELOW THE CEILING IF THE CEILING IS TOO LOW, AND MAKE SURE IT PROTRUDES LESS THAN 4" IF IN A WALKWAY, CORRIDOR OR AISLE. NOTE THAT THESE MOUNTING REQUIREMENTS ALSO APPLY TO COMBINATION HORN/STROBE OR SPEAKER/STROBE APPLIANCES THAT ARE WALL MOUNTED (NFPA 72, CH.6).
- A. MANUAL PULL STATIONS SHALL BE MOUNTED +48" ABOVE FINISHED FLOOR TO CENTER OF BOX. STROBE SHALL BE CEILING OR WALL MOUNTED AT +80" A.F.F. AND EXTERIOR HORNS HALL BE MOUNTED AT +90" A.F.F.
- 27. STROBES SHALL BE VISIBLE IN ALL LOCATIONS THROUGHOUT THE BUILDING PER NFPA 72, CHAPTER 6, SECTION 6-4. A. VISUAL DEVICES SHALL NOT EXCEED 2 FLASHER PER SECOND AND SHALL NOT BE SLOWER THAN 1 FLASH EVERY SECOND.
- 28. PROVIDE 24 HOUR TELEPHONE NUMBER OF CENTRAL STATION NEAR FIRE ALARM CONTROL PANEL.
- 29. ALL FIRE ALARM DEVICES LOCATED IN STUDENT RESTROOM FACILITIES ARE TO HAVE VANDAL-RESISTANT GUARDS INSTALLED.

ALL MANUAL PULL STATIONS IN AREAS WHERE STUDENTS HAVE ACCESS ARE TO HAVE PLASTIC COVERS WITHOUT VANDAL
ALADM

FIRE ALARM SHEET INDEX	
SHEET TITLE	CURRENT ISSUE
FIRE ALARM GENERAL NOTES & SHEET INDEX	DSA RESUBMITTAL
FIRE ALARM CALCULATIONS	DSA RESUBMITTAL
FIRE ALARM FLOOR PLANS	DSA RESUBMITTAL
	SHEET TITLE  FIRE ALARM GENERAL NOTES & SHEET INDEX  FIRE ALARM CALCULATIONS

## **SCOPE OF WORK**

PROVIDE NEW FIRE ALARM SYSTEM INSTALLATION FOR THE CHILDHOOD CENTER AND TIED TO THE EXISTING CAMPUS FIRE ALARM SYSTEM UNDER DSA A#03-101976.

THE SEISMIC ANCHORAGE OF ELECTRICAL EQUIPMENT SHALL CONFORM TO CBC 2019 AND NFPA

CENTRAL STATION COMPANY: BAY ALARM CO. 17111 S. BROADWAY STREET GARDENA, CA 90248 APPLICATION #: 101976

> DRAWN BY DESIGNED BY CHECKED BY APPROVED BY

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## LAEP EARLY CHILDHOOD CENTER

13928 KORNBLUM AVE. **HAWTHORNE, CA 90250** 

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Los Angeles Education **Partnership** 1541 Wilshire Blvd., Suite 200 Los Angeles, CA 90017

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TORRANCE, CA 90504

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	DATE	REV
PROGRESS SET	02.01.22	
DSA PROGRESS SET	03.02.22	
DSA APPLICATION SET	04.01.22	
DSA BACK-CHECK SET	10.05.22	
DSA BACK-CHECK SET	10.24.22	

SHEET NAME:

FIRE ALARM GENERAL NOTES & SHEET INDEX

SHEET NUMBER:

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			VOLTA	CE DDOD	CALCULATIO	Me			
			VOLTA	GL DHOP	CALCULATIO	7113			
ZONE NUMBER	1	SZ-5							
WIRE GAUGE (	AWG)	12	AWG					6530	CIRC MILS
VOLTAGE		24	VOLTS					0300159	OHMS/ FOOT
TEMPERATURE		70	FAHRENHEIT					21.1	CENTIGRADE
								•	
NODE REFERENCE	CONDUCTOR LENGTH (FEET)	UNIT AMPERES	TOTAL AMPERES	AWG SIZE	CIRCULAR MILS	OHMS PER FOOT	VOLTAGE DROP	PERCENT DROP	CUMULATIVE % DROP
1	800	0.200	0.650	12	65.30	0.00159	1.657	6.91%	6.91%
2	20	0.050	0.450	12	65.30	0.00159	0.029	0.12%	7.03%
3	55	0.200	0.400	12	65.30	0.00159	0.070	0.29%	7.32%
4	40	0.200	0.200	12	65.30	0.00159	0.025	0.11%	7.42
								•	
TOTALS	115	0.450	1.050			TOTALS	1.782	7.42%	7.42%
		TOTAL V	OLTAGE DROP	1.782	VOLTS				
TOTAL PERCENTAGE VOLTAGE DROP IN CIRCUIT			7.42%	PERCENT	]				
			'		-				

REACTION							
	MANUAL PULL STATION	SMOKE DETECTOR	HEAT DETECTOR	WATERFLOW SWITCH	TAMPER SWITCH	POWER FAILURE	SYSTEM TROUBLE
ANNUNCIATE AT PANEL	YES	YES	YES	YES	YES	YES	YES
ANNUNCIATE AT REMOTE ANNUNCIATOR	YES	YES	YES	YES	YES	YES	YES
SOUND AUDIBLE ALARM DEVICES	YES	YES	YES	YES	NO	NO	NO
ACTIVATE CENTRAL STATION CONNECTION - ALARM	YES	YES	YES	YES	NO	NO	NO
ACTIVATE CENTRAL STATION CONNECTION - SUPERVISORY	NO	NO	NO	NO	YES	NO	NO
ACTIVATE CENTRAL STATION CONNECTION - SYSTEM TROUBLE	NO	NO	NO	NO	NO	YES	YES
WORKSHEET: SEQUENCE							

	DETECTION ZONE LIST									
DETECTION LOOP		I DESCRIPTION I AREA I		FROM PANEL	WIRE TYPE					
D		ADDRESSIBLE	THROUGHOUT	FACP/6820	D					
		5	SIGNAL ZONE LIST							
SIGNAL ZONE		DESCRIPTION	AREA	FROM PANEL	WIRE TYPE					
SZ	1	HORNS	THROUGH-OUT	FACP/6820	Α					
SZ	2	STROBES	NORTH PORTABLES	FACP/6820	Α					
SZ	3	STROBES	CR9-CR13	FACP/6820	Α					
SZ	4	STROBES	CR1-CR8	FACP/6820	А					
SZ	5	STROBES	EAST PORTABLES	FACP/6820	Α					

QTY	MANUFACTURER	MODEL NUMBER	DESCRIPTION	STANDBY CURRENT	TOTAL STANDBY	ALARM CURRENT	TOTAL ALARM
			,				
1	SILENT KNIGHT	6820	FIRE ALARM CONTROL PANEL	0.1400	0.1400	0.2600	0.2600
1	SILENT KNIGHT	5860	(E) REMOTE ANNUNCIATOR	0.0100	0.0100	0.0100	0.0100
6	SILENT KNIGHT	SD505-APS	(E) SMOKE DETECTOR	0.0005	0.0030	0.0005	0.0030
20	SILENT KNIGHT	SD505-APS	(N) SMOKE DETECTOR	0.0005	0.0100	0.0005	0.0100
1	SILENT KNIGHT	SD505-AHS	(E) HEAT DETECTOR	0.0001	0.0001	0.0005	0.0005
8	SILENT KNIGHT	SD505-AHS	(N) HEAT DETECTOR	0.0001	0.0008	0.0005	0.0040
13	SILENT KNIGHT	PS-SATK-WP	(E) PULL STATION	0.0001	0.0013	0.0001	0.0013
4	SILENT KNIGHT	PS-SATK-WP	(N) PULL STATION	0.0001	0.0004	0.0001	0.0004
13	SILENT KNIGHT	SD500-MIM	(E) MINI DRY CONTACT INPUT MODULE	0.0005	0.0065	0.0005	0.0065
15	WHEELOCK	MT-12/24-R	(E) HORN	0.0000	0.0000	0.0200	0.3000
14	WHEELOCK	RS-2415-VFR	(E) STROBE, 15CD	0.0000	0.0000	0.0500	0.7000
0	WHEELOCK	RS-2415-VFR	(N) STROBE, 15CD	0.0000	0.0000	0.0500	0.0000
6	WHEELOCK	RS-2475-VFR	(E) STROBE, 75CD	0.0000	0.0000	0.2000	1.2000
4	WHEELOCK	RS-2475-VFR	(N) STROBE, 75CD	0.0000	0.0000	0.2000	0.8000
	TOTALS				0.1721		2.4957
	PANEL VOLTAGE			24	60 HOURS	STANDRY	9.6540
	BATTERY VOLTAGE  BATTERY CAPACITY (AMP HOURS)  NUMBER OF BATTERIES USED  TOTAL BATTERY CAPACITY (AH @ PANEL VOLTAGE)			12	5 MINUTES ALARM		0.2653
				17	TOTAL CAPACITY USED		9.9193
				2	BATTERY CAPACITY		17.0000
				17	SPARE CAPACITY		41.65%

QTY	MANUFACTURER	MODEL NUMBER	DESCRIPTION	STANDBY CURRENT	TOTAL STANDBY	ALARM CURRENT	TOTAL ALARM
1	SILENT KNIGHT	5895	ZONE EXPANDER/POWER SUPPLY	0.0700	0.0700	0.1250	0.1250
	TOTALS				0.0700		0.1250
	1	I			1	•	I
	PANEL VOLTAGE			24	60 HOURS STANDBY		4.2000
	BATTERY VOLTAGE	12	5 MINUTES ALARM		0.0104		
	BATTERY CAPACITY (AMP HOURS)			7	TOTAL CAPACITY USED		4.2104
	NUMBER OF BATTERIES USED			2	BATTERY CAPACITY		7.0000
	TOTAL BATTERIES CAPACITY (AH @ PANEL VOLTAGE)			7	SPARE CAPACITY		39.85%
WORK	SHEET: BATTCALCS - 589	95WS					

WIRE ID	WIRE/CABLE	DESCRIPTION	CIRCUIT TYPE	PANEL/ZONE ORIGIN			
D	14/2 FIRE WIRE	DETECTION	ADDRESSIBLE	FACP/6820			
А	12/2 THHN	SIGNAL	STROBES & HORNS	FACP/6820			
С	22/4 THHN	ANNUNCIATOR	COMMUNICATION	FACP/6820			
NOTE: USE TYPE "THWN" FOR WET/ DAMP LOCATIONS.							
WORKSHEET: WIRE SCHEDULE							

## UL LLC CERTIFICATE OF COMPLIANCE **COVER PAGE**

Applicant Subscriber No: 223646-006 Service Center Number: 14 Service Contract No: ACTIVE LISTINGS CCN File No. Vol. No.

CPVX BP643 UUFX S576 CVSG BP8184

Listed Service From: GARDENA, CA (SOUTH BAY BRANCH)

Alarm Service Company: BAY ALARM CO 17111 S BROADWAY STREET GARDENA CA 90248

Service Center: BAY ALARM CO 17111 S BROADWAY STREET GARDENA CA 90248



## REFERENCE NOTE

1 NEW FIRE ALARM DEVICES ADDED TO NEW SCOPE OF

## **GENERAL NOTE**

REFER TO A#03-101976 FOR FIRE ALARM AS-BUILTS FOR MORE INFORMATION ON THE APPROVED FIRE ALARM CALCULATIONS OF THE WHOLE SCHOOL CAMPUS.

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SHEET NAME:

FIRE ALARM CALCULATIONS

SCALE:


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DSA BACK-CHECK SET 10.05.22

DSA BACK-CHECK SET 10.24.22

SHEET NAME:

FIRE ALARM FLOOR PLANS

SCALE: AS NOTED

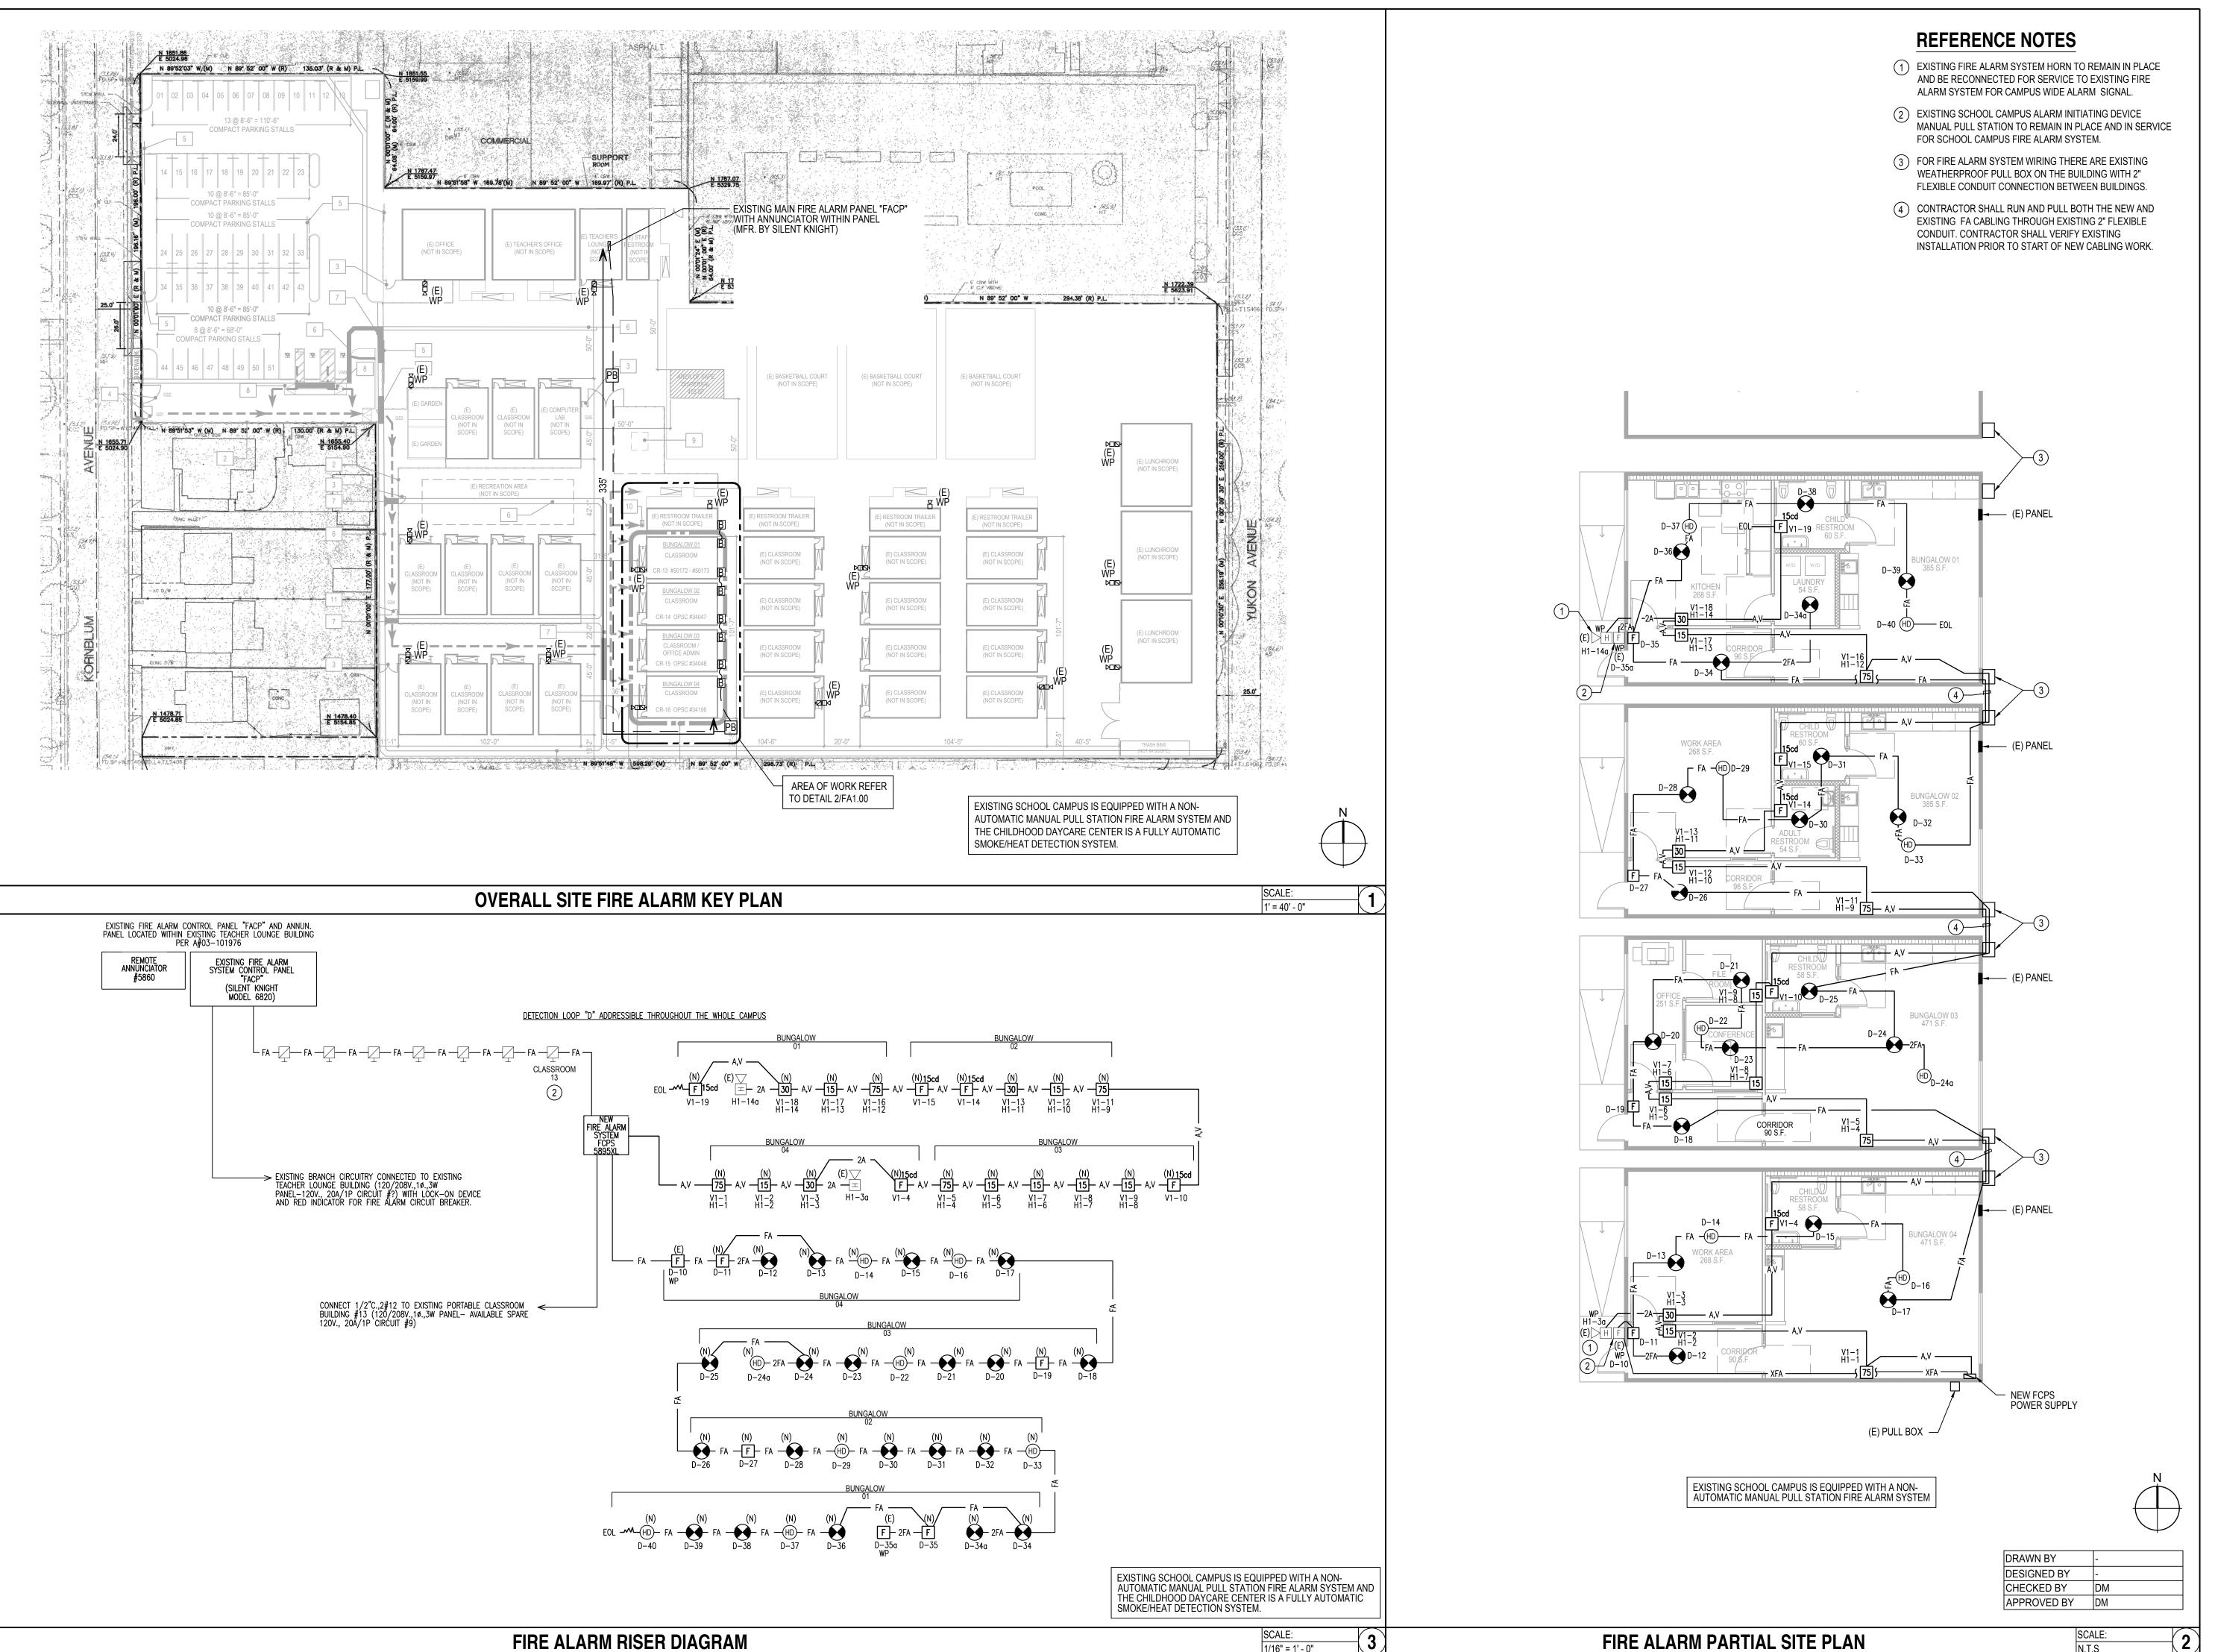SHEET NUMBER:

ELI NUMBER.

FA1.00